

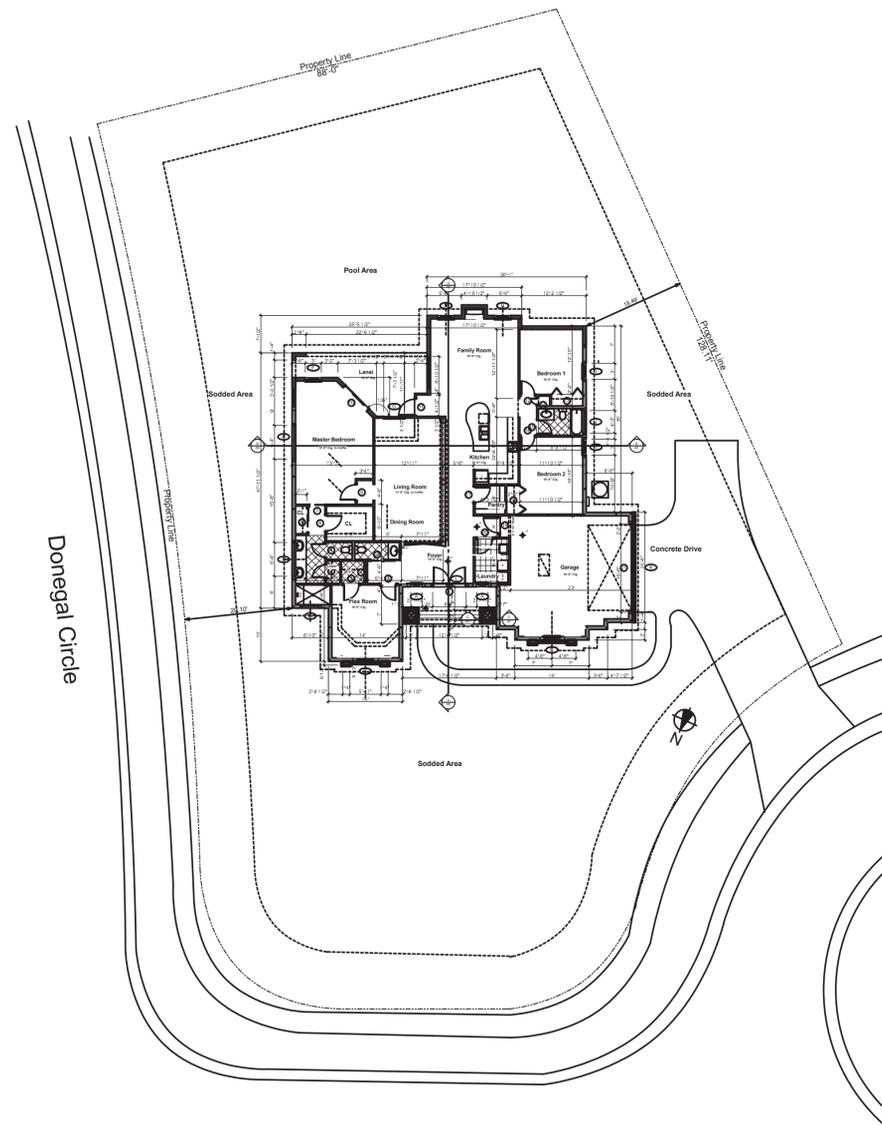
Residential Renovation

1400 Newry Circle
Ormond Beach, Florida

I have inspected the existing footings and walls and certify that they meet or exceed current code requirements.

Plans Conform to the requirements of the Florida Building Code 2010 Edition with adopted supplements.
Wind Speed 140
Enclosed Building Type
Risk Category 2
Exposure Category C
Internal Pressure Coefficient = .18
Wind Importance Factor 1
Wind Pressures +33.1 -43.1

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Site Plan

SCALE: 1/16" = 1'-0"



Axonometric View



Front Perspective View

SCALE: 1:139.75

REVISIONS

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Richard Brookfield Architect, P.A.
Fla. Reg. # AR 0014568
Brookfieldarchitect.com
P.O. Box 4195 Ormond Beach, FL USA 32175
Ph: (386) 334-3564

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March 27, 2015

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SHEET TITLE

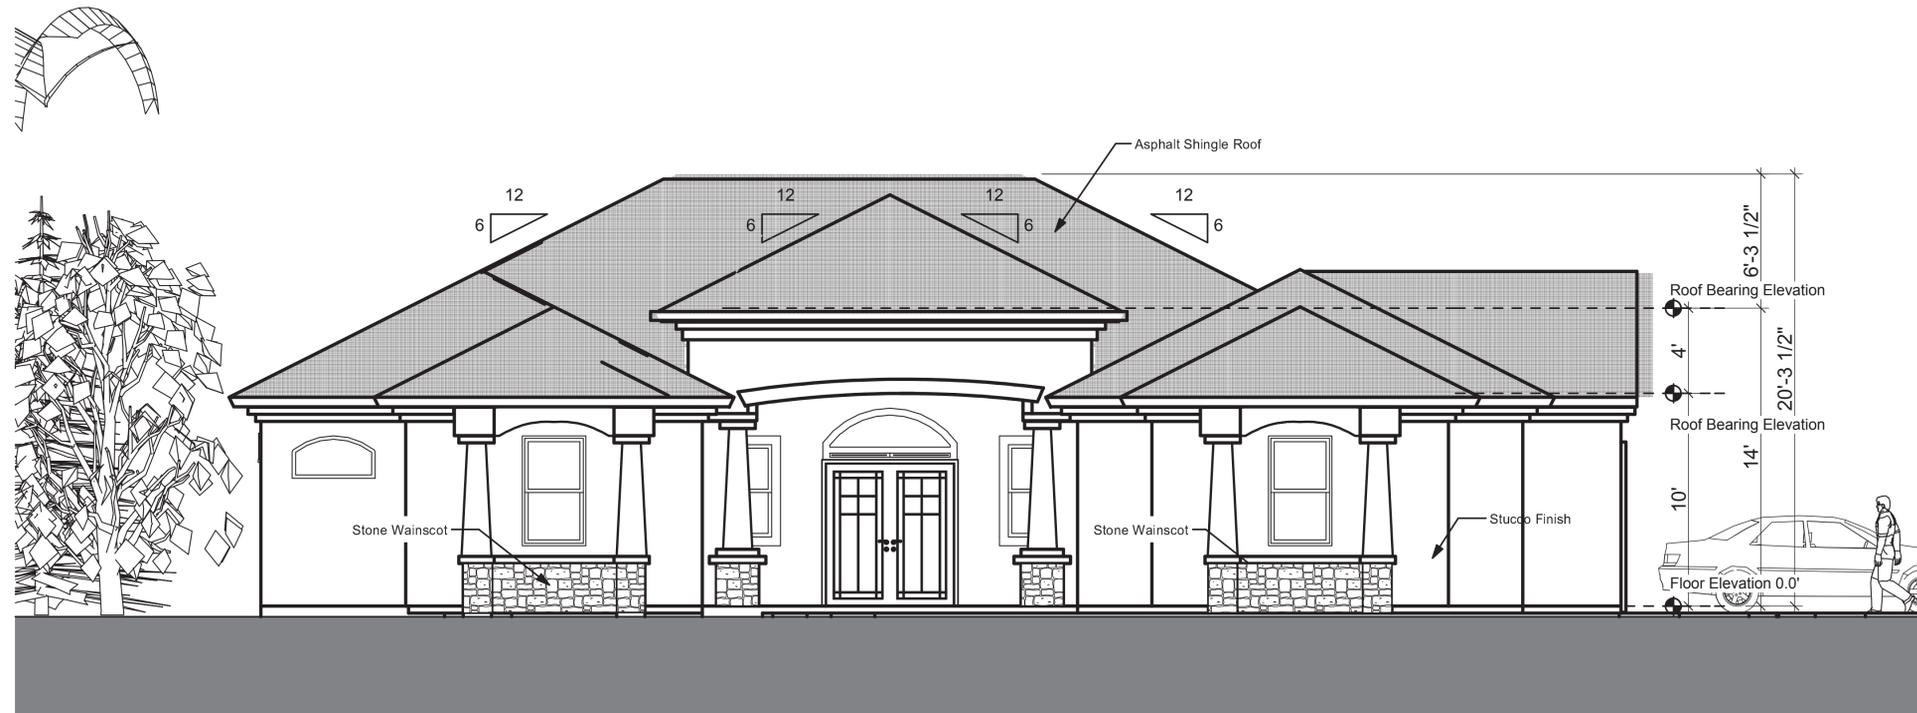
Title Sheet

SHEET

A-1

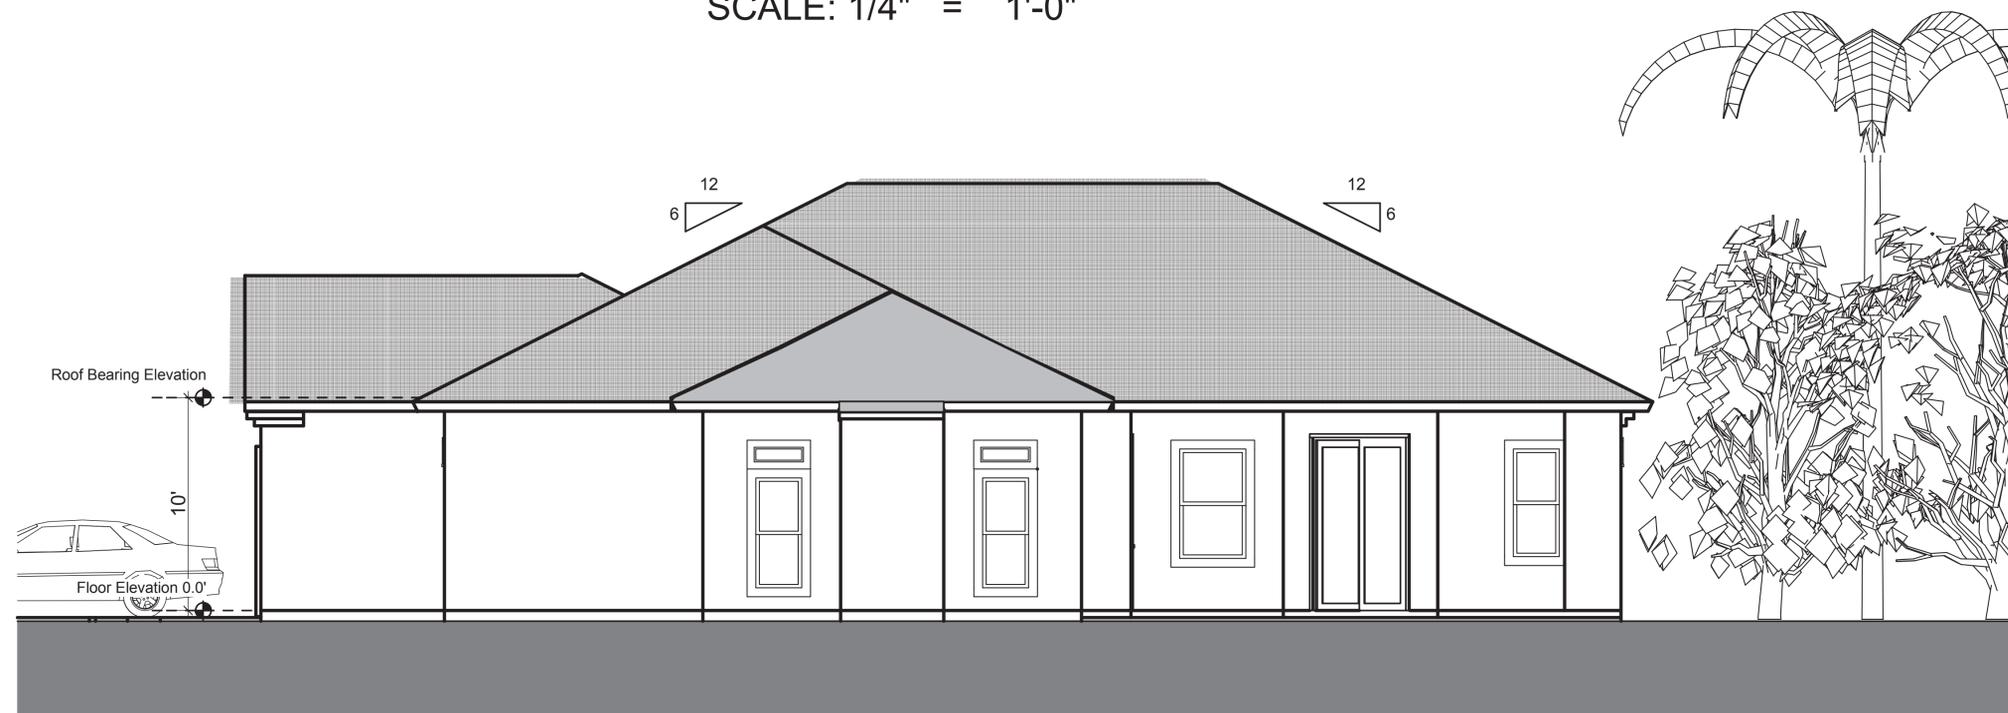
OF

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North Elevation

SCALE: 1/4" = 1'-0"



South Elevation

SCALE: 1/4" = 1'-0"

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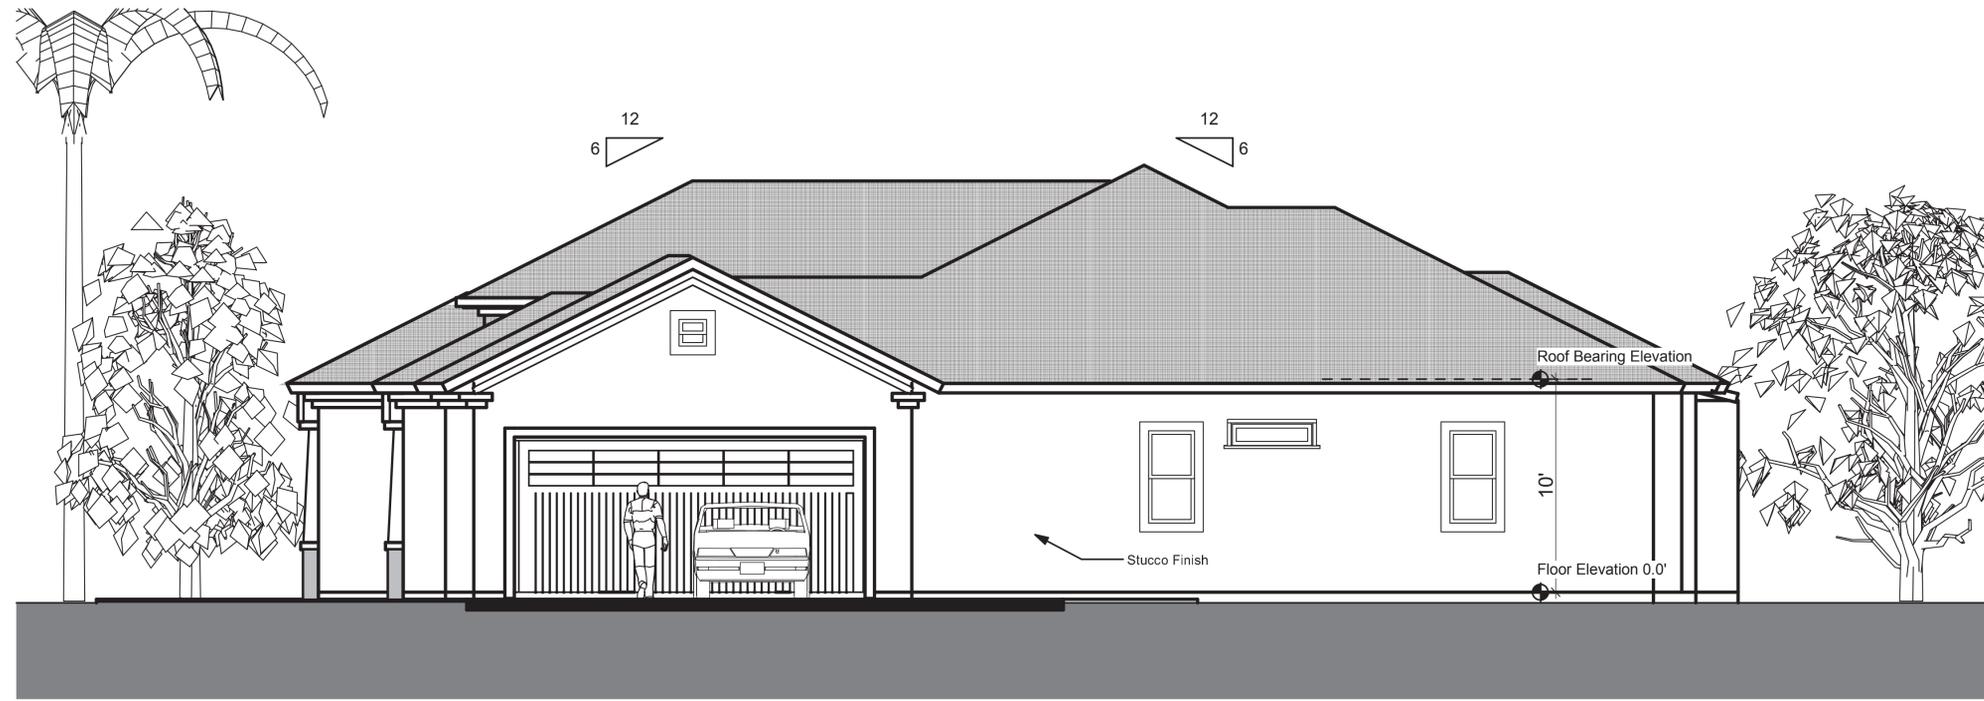
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North Elevation

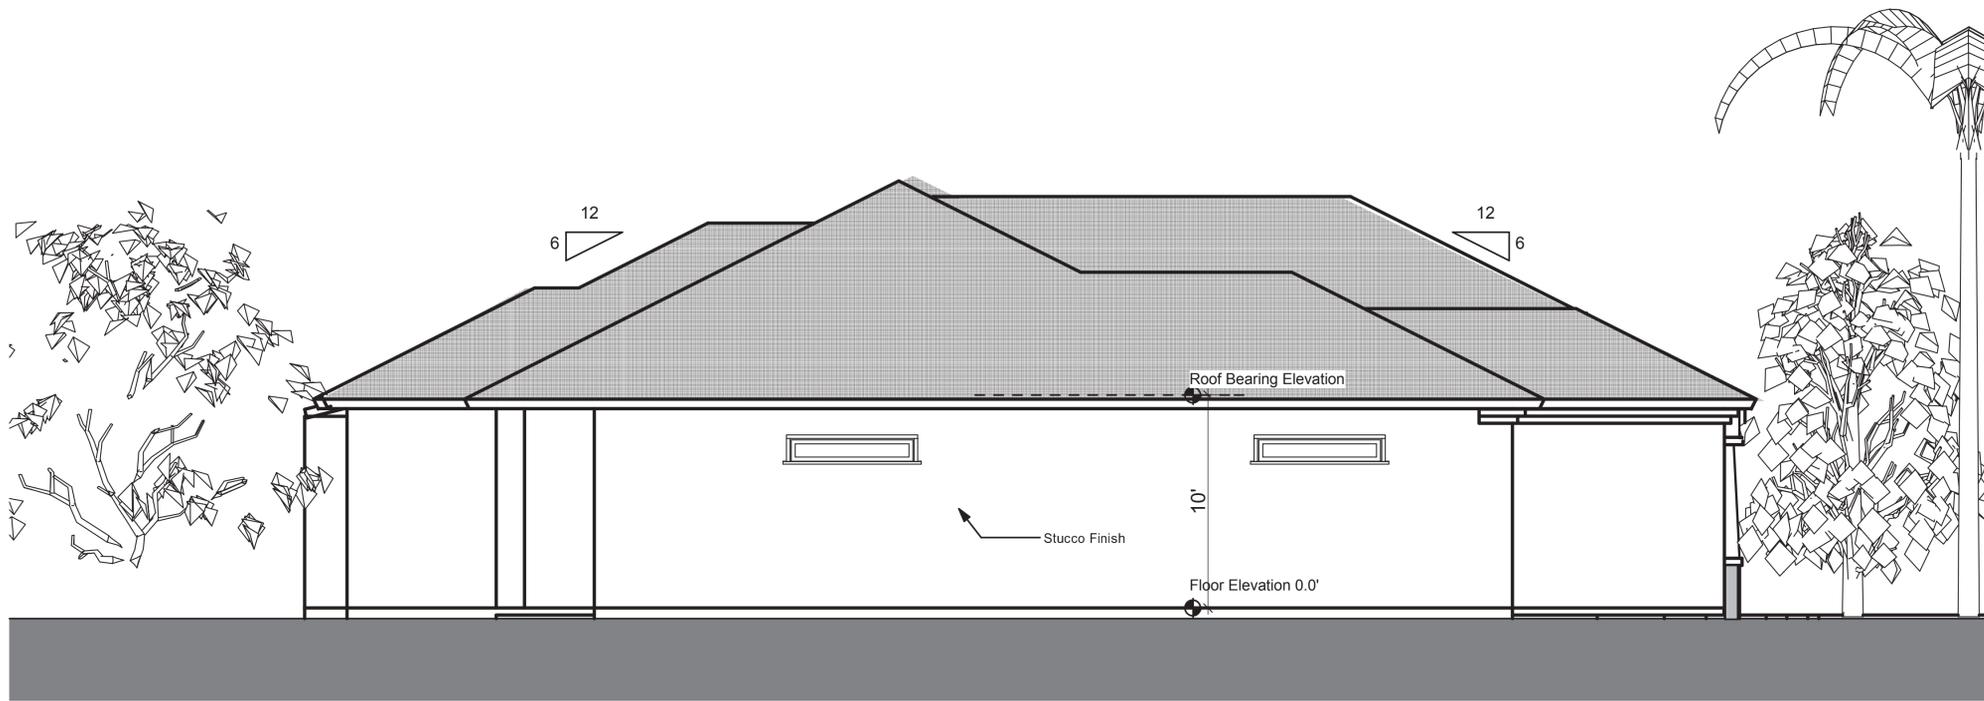
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West Elevation
 SCALE: 1/4" = 1'-0"



East Elevation
 SCALE: 1/4" = 1'-0"

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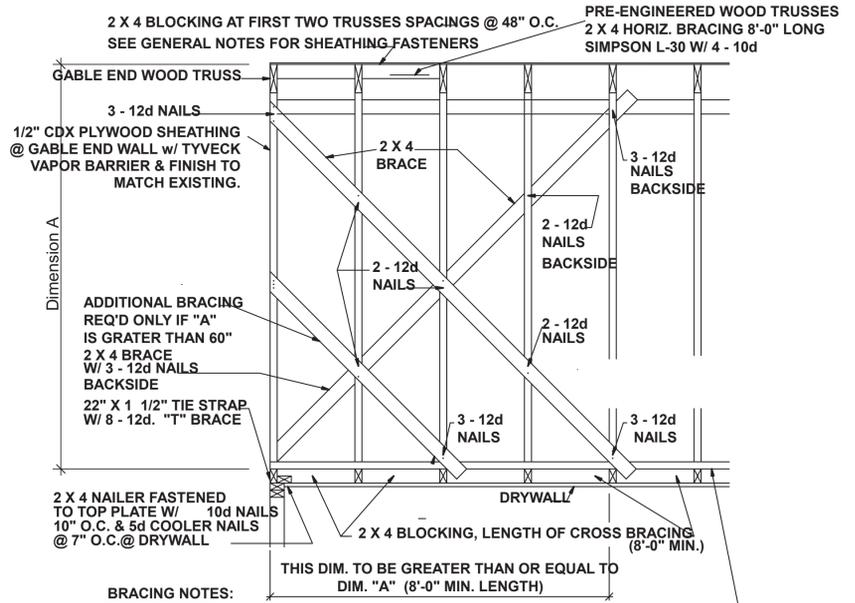
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East Elevation

SHEET

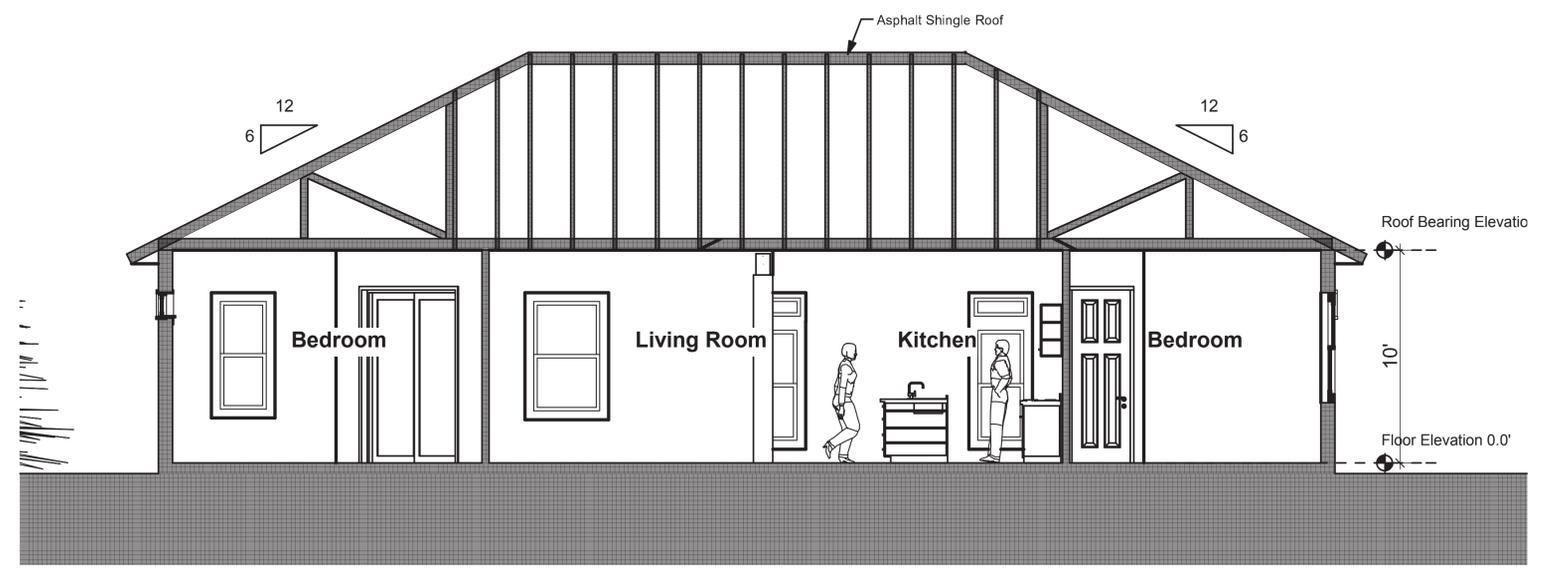
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- BRACING NOTES:**
- ALL NAILS ARE CEMENT COATED
 - ALL 2 X 4 BRACES ARE STRUCTURAL GRADE
 - NAIL EA. HORIZ. BRACE W/ 2 NAILS AT EA. INTERSECTION
 - GABLE END SHEATHING NAILING @ 4" O.C. SHORT SIDES, 6" O.C. LONG SIDES 12" O.C. IN FIELD.
 - BRACE GABLE END 3 - TIMES. ONCE IN MIDDLE & 1/4 IN FROM EA. END.
- 2 X 4 HORIZ. CONT. BRACING ABOVE 2 X 4 BLOCKING W/ 3 - 12d IN EA. TOP OF TRUSS BTM. CORD. LENGTH AS INDICATED ON ROOF PLAN

GABLE - END TRUSS BRACING DETAIL

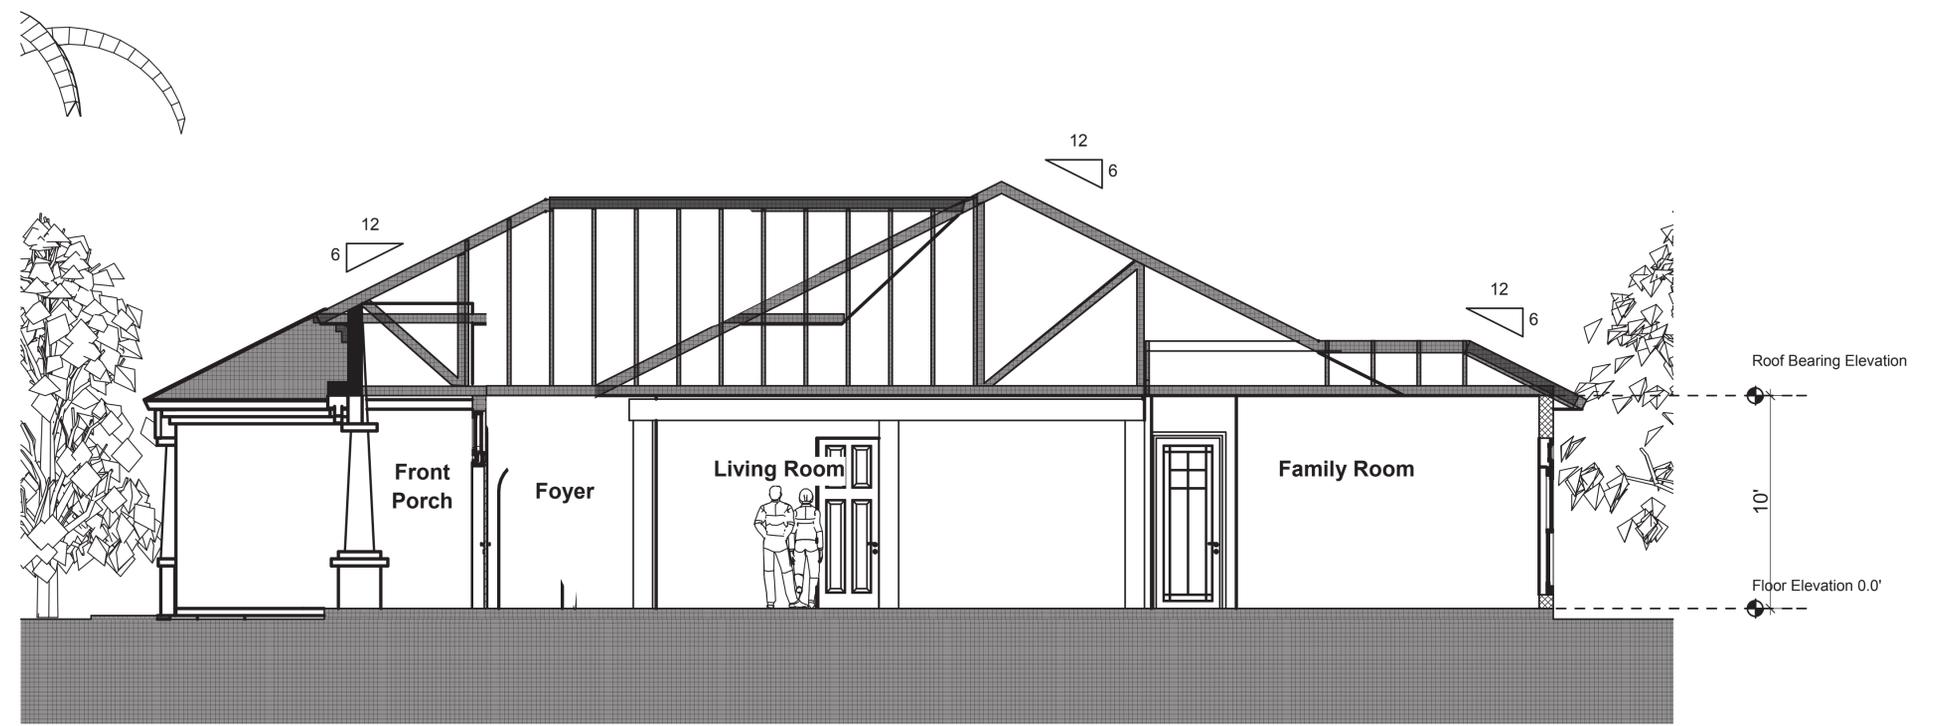


A Section B EW Axis
 SCALE: 1/4" = 1'-0"

Header Dimension Chart

Douglas Fir - Larch, So. Pine No.2
 Roof Load = 20 lbs. D.L., 10 lbs. L.L.; Floor Load = 40 lbs. D.L., 10 lbs. L.L.
 Fb= 1,500 lbs. E= 16,000,000 Fv= 90

Header Supporting	Header Size	Non struct. Sheathing House Depth (Ft.)			1/2" Insul. Bd. Sheathing House Depth (Ft.)			15/32" Plywood Sheathing House Depth (Ft.)		
		24	28	32	24	28	32	24	28	32
Roof	(2) - 2" x 4"	4'-7"	4'-8"	4'-3"	4'-11"	4'-8"	4'-6"	5'-7"	5'-4"	5'-1"
	(2) - 2" x 6"	6'-8"	6'-4"	5'-11"	4'-11"	6'-7"	6'-4"	7'-7"	7'-3"	7'-10"
	(2) - 2" x 8"	8'-3"	8'-0"	7'-7"	8'-6"	8'-2"	7'-11"	8'-11"	8'-7"	8'-4"
	(2) - 2" x 10"	9'-10"	9'-6"	9'-3"	10'-0"	9'-8"	9'-4"	10'-4"	10'-0"	9'-9"
	(2) - 2" x 12"	11'-4"	10'-11"	10'-7"	11'-5"	11'-1"	10'-9"	11'-10"	11'-5"	11'-1"
Roof 1-Story (Bearing)	(2) - 2" x 4"	5'-2"	4'-11"	4'-9"	5'-4"	5'-1"	4'-10"	5'-8"	5'-5"	5'-2"
	(2) - 2" x 6"	6'-9"	6'-5"	6'-0"	6'-11"	6'-7"	6'-3"	7'-4"	7'-0"	6'-8"
	(2) - 2" x 8"	8'-0"	7'-5"	7'-0"	8'-1"	7'-8"	7'-3"	8'-5"	8'-2"	7'-5"
	(2) - 2" x 10"	9'-3"	8'-9"	8'-3"	9'-4"	9'-0"	8'-5"	9'-7"	9'-3"	8'-11"
	(2) - 2" x 12"	10'-5"	10'-1"	9'-7"	10'-6"	10'-2"	9'-9"	10'-10"	10'-5"	10'-1"
Roof 1-Story (Non Bearing)	(2) - 2" x 4"	4'-8"	4'-3"	4'-3"	4'-1"	3'-9"	3'-7"	4'-3"	4'-2"	4'-0"
	(2) - 2" x 6"	5'-10"	5'-3"	5'-1"	4'-10"	4'-5"	4'-2"	5'-3"	4'-11"	4'-7"
	(2) - 2" x 8"	6'-9"	6'-3"	5'-11"	5'-7"	5'-2"	4'-10"	6'-0"	5'-7"	5'-3"
	(2) - 2" x 10"	8'-0"	7'-5"	6'-11"	6'-6"	6'-0"	5'-8"	6'-11"	6'-3"	6'-0"
	(2) - 2" x 12"	9'-3"	8'-7"	8'-1"	7'-6"	7'-0"	6'-6"	7'-11"	7'-4"	6'-11"



B Section A NS Axis
 SCALE: 1/4" = 1'-0"