


36" MAX.

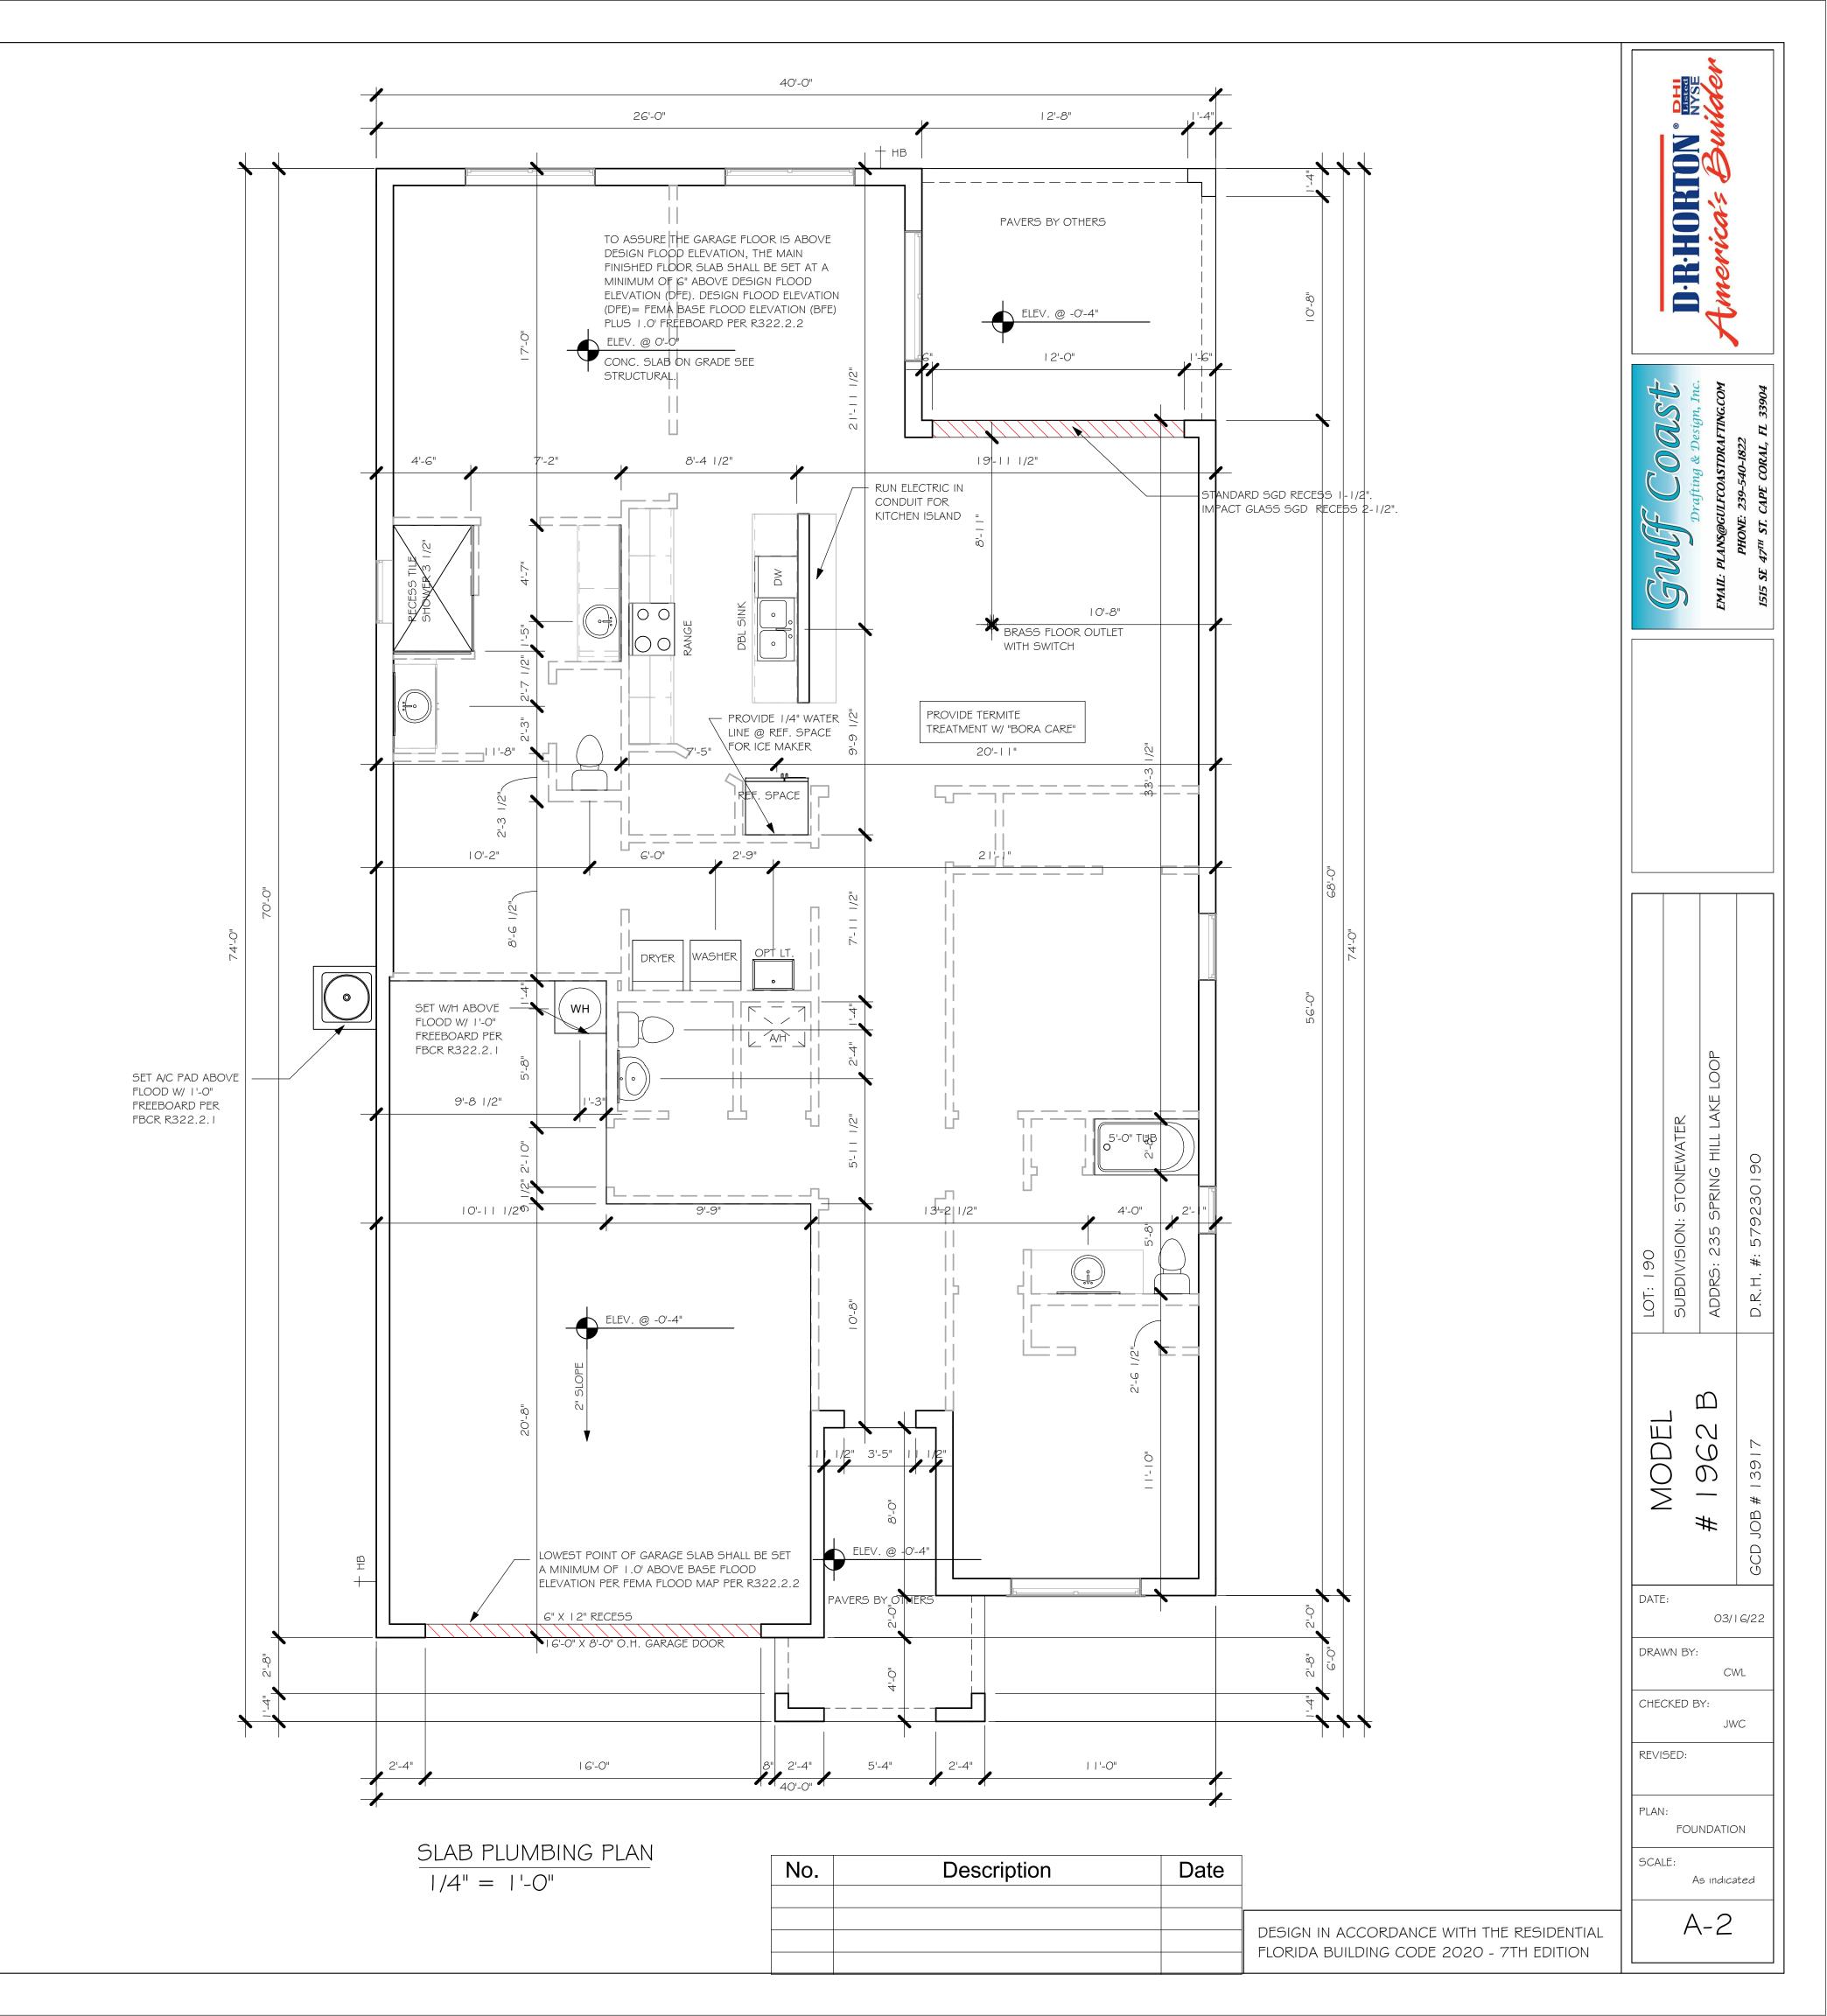

DOOR SCHEDULE						
TYPE MARK						

GARAGE DOOR 8'-0"

12'-0"

16'-0"

	WINDOW SCHEDULE							
MARK	DESCRIPTION	WIDTH	HEIGHT	COMMENTS	QTY			
Α	1/2 34 SH	2'-5"	4'-5"		1			
В	25 SH	3'-4"	5'-5"		1			
С	2-25 SH	6'-4"	5'-3"		4			
D	I 2" X 36" FIXED GLASS	3'-2"	1'-2"		1			

(3)-4080 SL. GL. DR. DISTINCTION 8'-0"

OPT. IMPACT GLASS MAY BE INSTALLED IN LIEU OF SHUTTERS VERIFY W/ CONTRACT

16080 OHGD

DOOR HEADERS						
6'-8" BI-FOLD HEADER HEIGHT 82" A.F.F.						
6'-8" SWING	82 I/2" A.F.F.					
8'-0" SWING	HEADER HEIGHT	98 1/2" A.F.F.				

PLAN NOTES


- I) VERIFY ALL ROUGH OPENING DIMENSIONS FOR ALL WINDOWS AND DOORS
- 2) PROVIDE SAFETY GLAZING WITHIN 24" FROM EXIT PER FLORIDA BUILDING CODE R 308.4.2.
- 3) PROVIDE SAFETY GLAZING AT BATH/ SHOWER
- 4) NON BEARING INTERIOR FRAME WALLS SHALL BE FRAMED W/ WOOD OR METAL STUDS. SPACING SHALL

NOT EXCEED 24" O.C. (NON BEARING WALLS ONLY)

PER FLORIDA BUILDING CODE R 308.4.5.


- 5) PROVIDE DEAD WOOD IN ATTIC FOR OVERHEAD GARAGE DOOR HARDWARE
- 6) KITCHEN KNEE WALL TO BE FRAMED W/ TOP @ 34 1/2" A.F.F.
- 7) INSTALL SMOOTH WALLS IN KITCHEN AND ALL BATHROOM AREAS
- 8) WHERE DRYWALL CEILING IS APPLIED TO TRUSSES
 @ 24" O.C. USE 5/8" DRYWALL OR 1/2" SAG
 RESISTANT PER SEC. R702.3.5
- 9) THE GARAGE SHALL BE SEPARATED FROM THE
 RESIDENCE \$ ATTIC BY NOT LESS THEN 1/2" GYPSUM
 BOARD APPLIED TO THE GARAGE SIDE. GARAGES
 BENEATH HABITABLE ROOMS SHALL BE SEPARATED
 WITH NOT LESS THAN 5/8" TYPE "X" GYPSUM BOARD
 OR EQUIVALENT. WHERE THE SEPARATION IS A
 FLOOR CEILING ASSEMBLY, THE STRUCTURE
 SUPPORTING THE SEPARATION SHALL ALSO BE
 PROTECTED BY NOT LESS THAN 1/2" GYPSOM BOARD
 OR EQUIVALENT
- 10) INSTALL I 3/8" THICK SOLID WOOD DOOR BETWEEN LIVING AND GARAGE PER FLORIDA BUILDING CODE R302.5.1.
- 11) ALL WINDOWS INSTALLED 72" ABOVE GRADE MUST COMPLY WITH R312.2 MIN 24" SILL HEIGHT OR PROVIDED WITH AN APPROVED WINDOW FALL PREVENTION DEVICE
- 12) ALL CLOSET SHELVES TO BE 12". ALL PANTRY \$
 LINEN TO BE (4)-16" SHELVES 18" O.F.F. W/ 15"
 INCREMENT.
- 13) ALL MECHANICAL AND ELECTRICAL EQUIPMENT TO BE INSTALLED AT OR ABOVE FLOOD PLUS 1'-0" FREEBOARD.


CABINET BACKING						
KITCHEN UPPER TOP @ 84" BASE TOP @ 35"						
MASTER BATH	UPPER	BASE TOP @ 35"				
GUEST BATH	BASE TOP @ 31"					
LAUNDRY ROOM UPPER TOP @ 84" BASE						

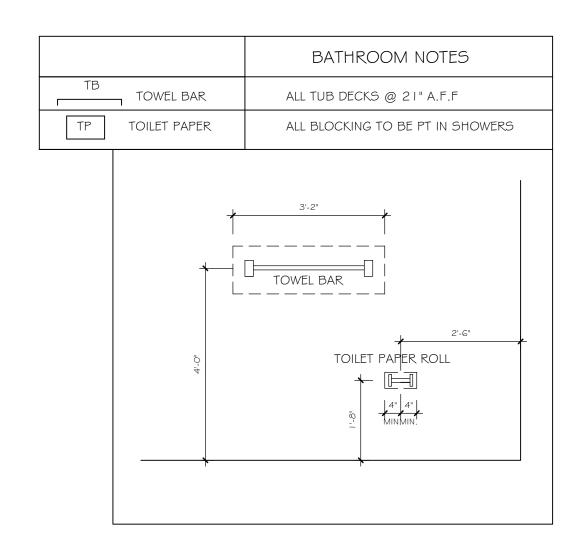


SQUARE FOOTAGE					
ENTRY AREA	98 SF				
LANAI AREA	167 SF				
GARAGE AREA	552 SF				
LIVING AREA	2000 SF				
TOTAL SQAURE FOOTAGE	2817 SF				


INTERIOR DOOR SCHEDULE						
MARK	DOOR WIDTH	NOTES				
	3'-0"	P.K. = POCKET DOOR				
2	2'-8"	B.F. = BI-FOLD DOOR				
3	2'-6"	D.1 DI-1 OLD DOOK				
4	2'-4"	B.P. = BI-PASS DOOR				
5	2'-0"	L.V. = LOUVERED DOOR				
6	1'-8"					
7	1'-6"					
8	2'-11"					

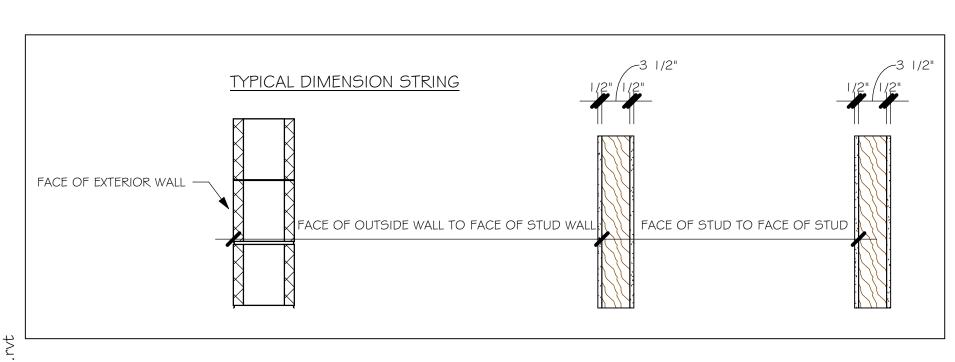

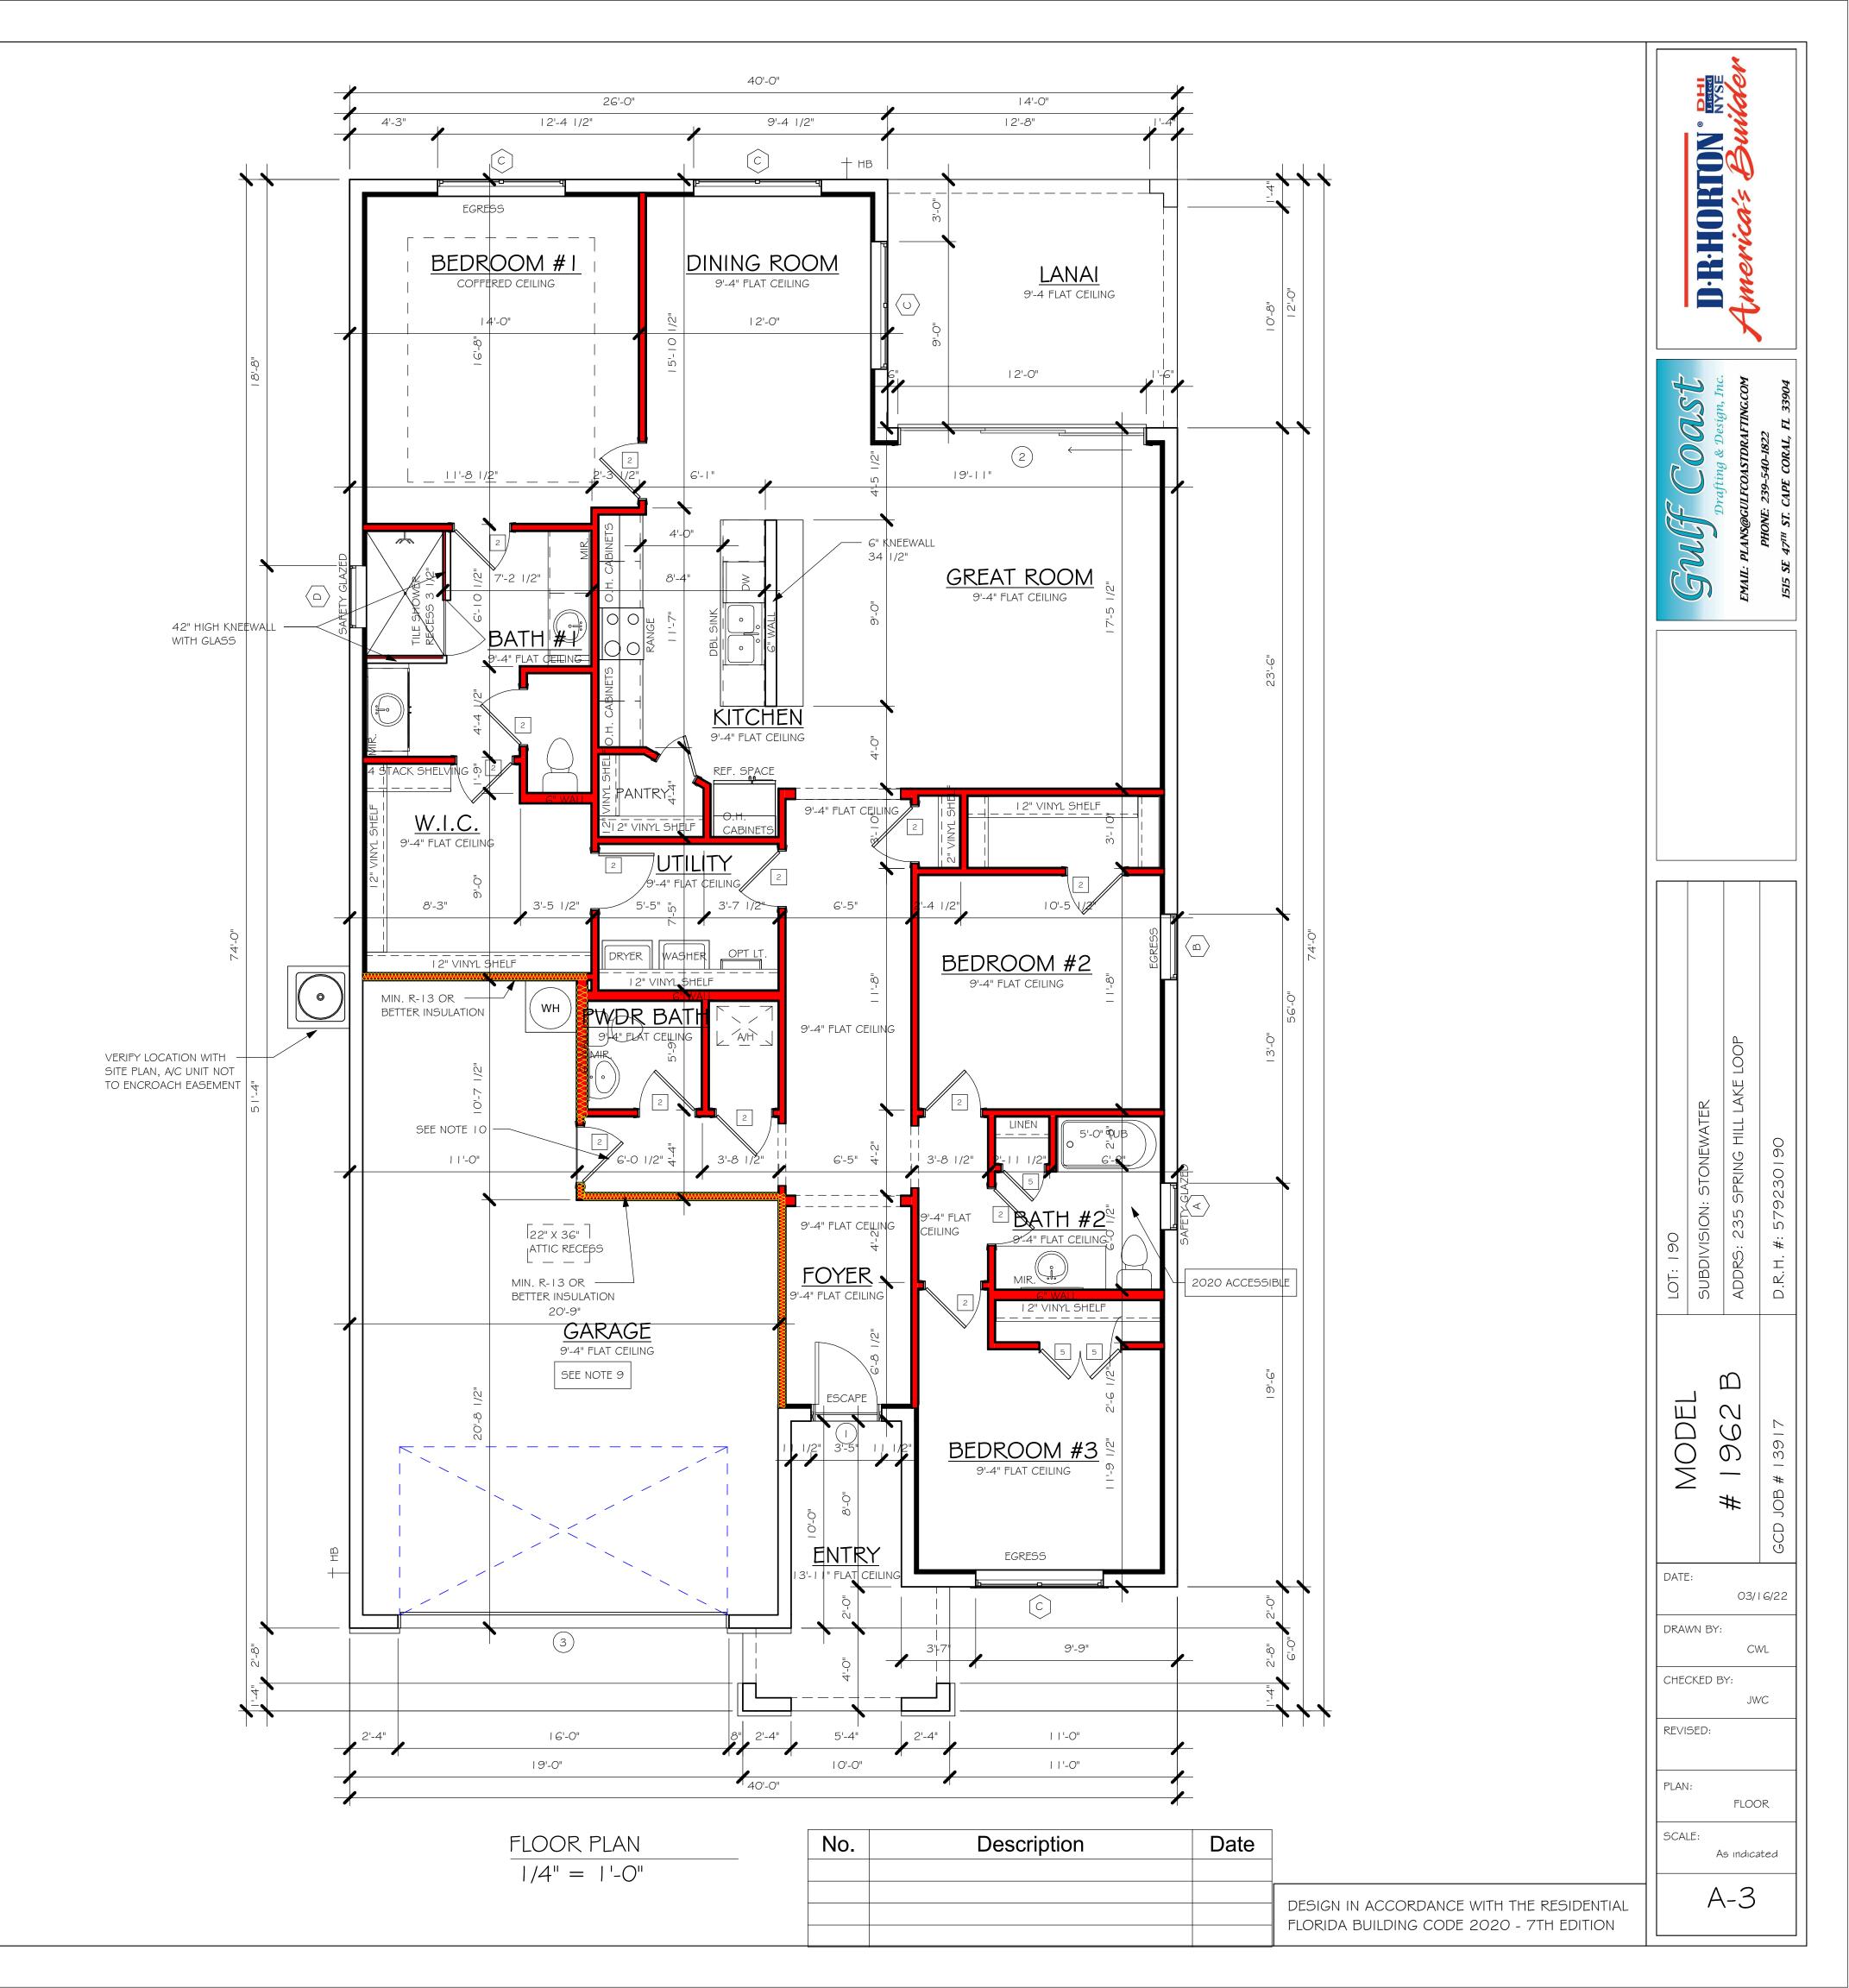

(O-New Data\I-MASTER 2019\2019-BUILDERS\DR HORTON 319\SUBDIVISIONS\STONEWATER 50s\13917 LOT 190 1962 BL\REVIT\13917 1962—

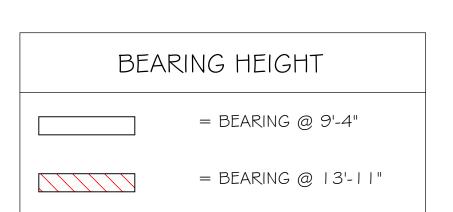

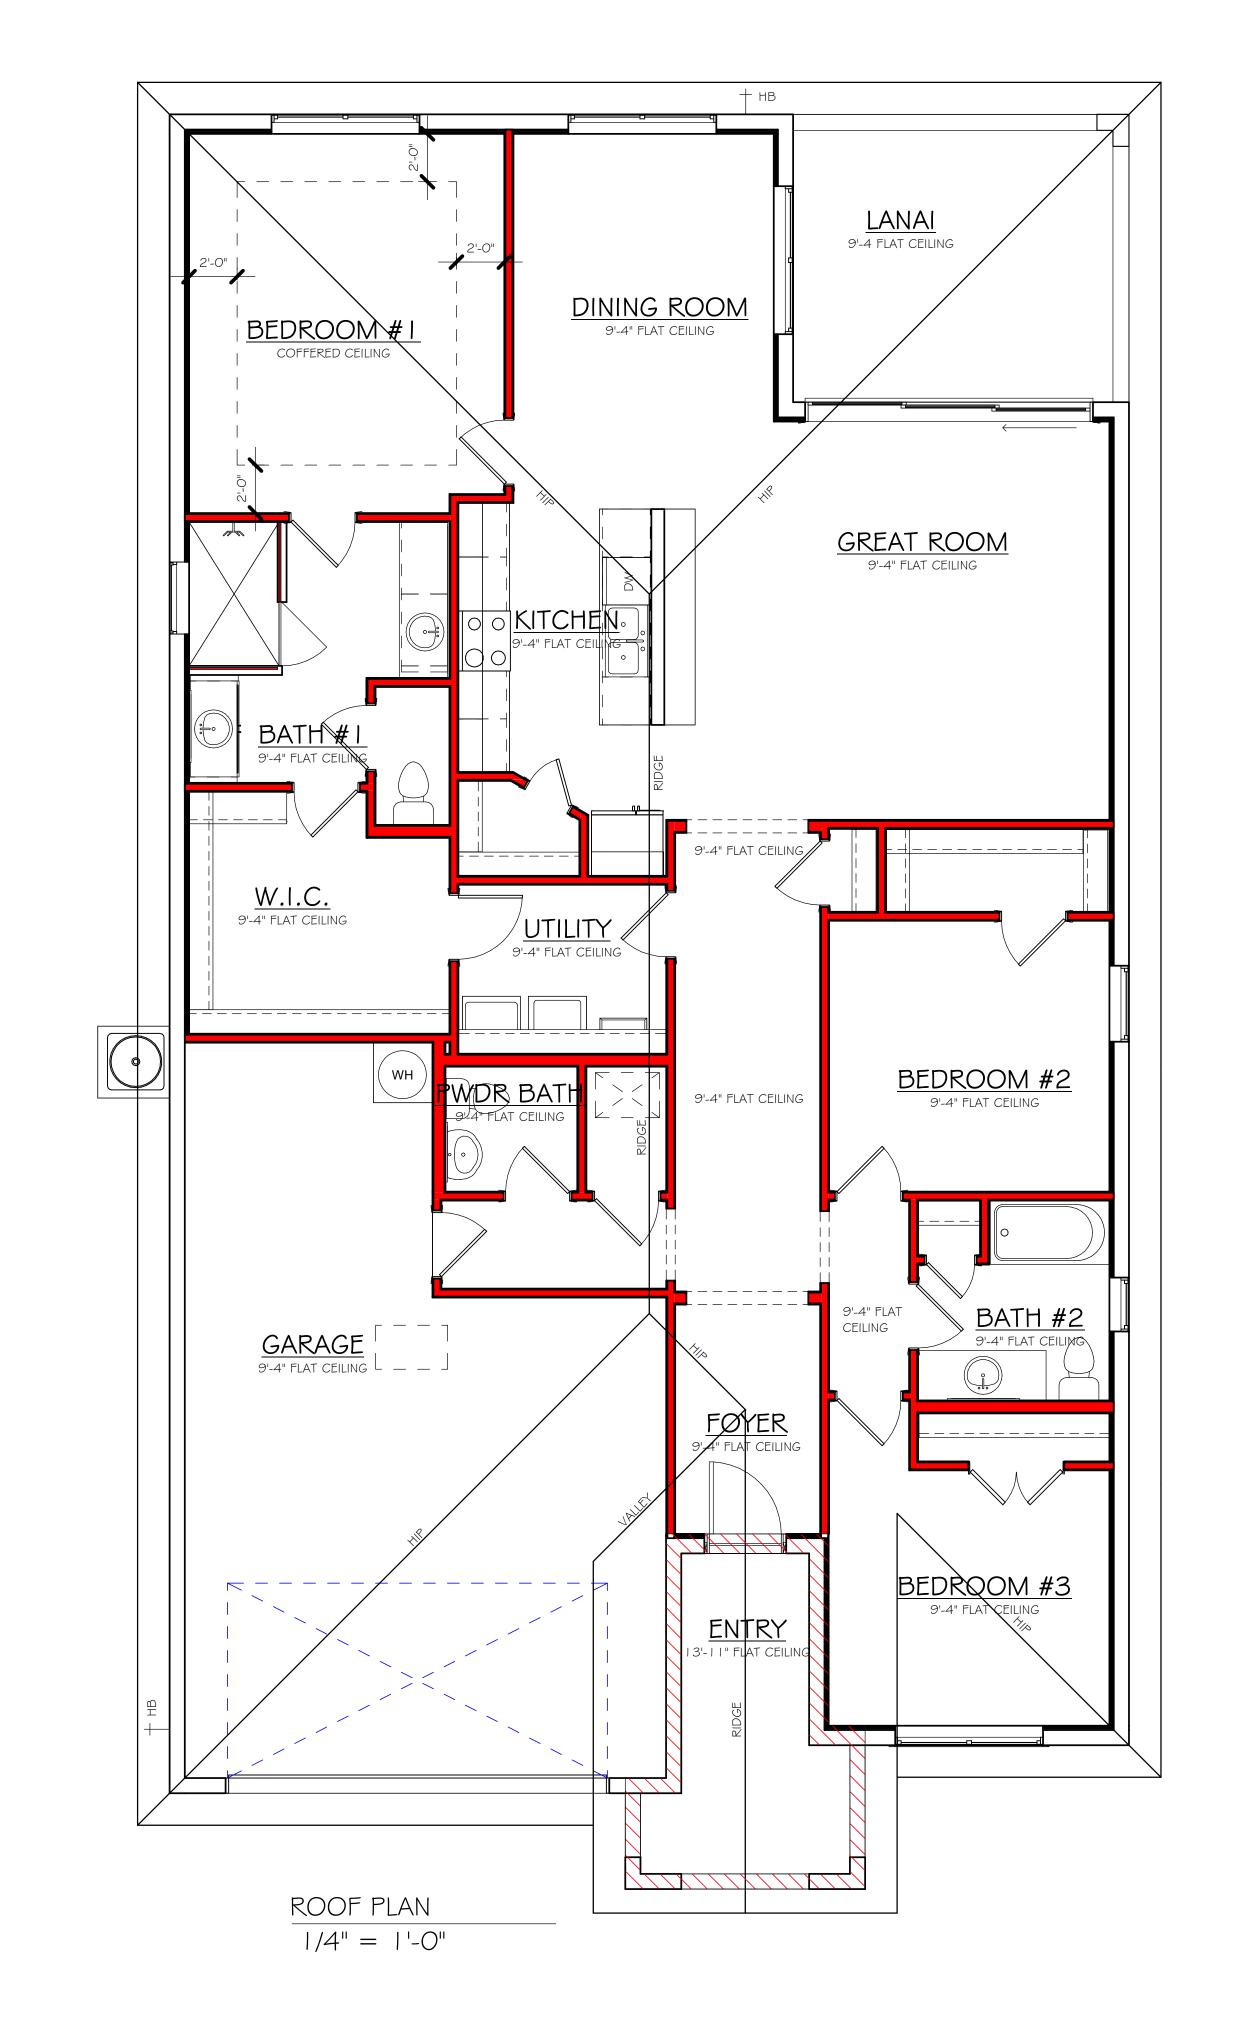

No.

Date Description

DESIGN IN ACCORDANCE WITH THE RESIDENTIAL FLORIDA BUILDING CODE 2020 - 7TH EDITION

MODEL

DATE:

DRAWN BY:

CHECKED BY:

REVISED:

PLAN:

SCALE:

03/16/22

CWL


JWC

ROOF

As indicated

A-4


2' UNDER COUNTER LIGHT NOTE: NOT ALL SYMBOLS ARE USED FOR THIS PROJECT. ELECTRICAL NOTES: ARC-FAULT CIRCUIT-INTERRUPTERS AND TAMPER RESISTANT RECEPTACLES SHALL BE INSTALLED IN DWELLING UNITS PER N.E.C 210.12 AND 406.11 ALL ELECTRIC, ELECTRICAL EQUIPMENT AND APPLIANCES TO BE SET AT OR ABOVE BASE FLOOD ELEVATION PLUS 1'-0" FREEBOARD. ALL OUTLETS IN WET AREAS AND ALL EXTERIOR OUTLETS TO BE GFI'S. INSTALL PHONE AND T.V PER CONTRACT. INSTALL ALL ELECTRICAL PER NEC 2017

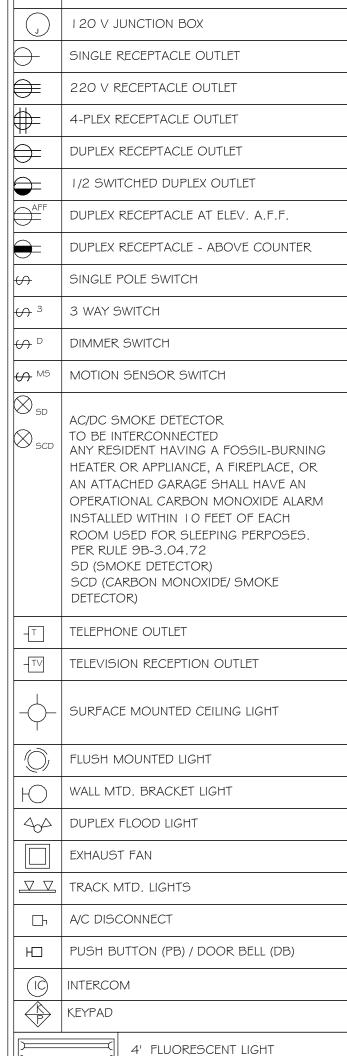

ELECTRICAL LEGEND


ELECTRICAL METER


ELECTRICAL PANEL

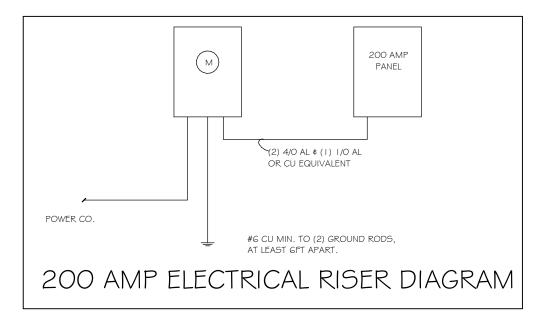


FLECTRICAL PLAN 1962 "B"

LLLCINICAL I LAN 1362 D							
200	200 AMP SERVICE						
TAG	QUANTITY	PRODUCT					
Α	(37)	(FLUSH MOUNTED LT)					
В	(3)	(VAPORS)					
C	(5)	(PENDANT LIGHT					
D	(X)	(10" MUSHROOMS)					
E	(5)	(24" 3 LT)					
L	(X)	(36" 4 LT)					
G	(X)	(NOT USED)					
Ι	(3)	(COACH LIGHTS)					
_	(X)	(COACH LIGHTS)					
<u>ا</u>	()	(J BOX)					
K	(4)	(4' FLUORESCENT)					
L	(3)	(2' FLUORESCENT)					
Μ	(X)	(5LT CHANDELIER)					
Z	(X)	(3 LT)					
0	(X)	(PENDANT/ NOOK)					
Р	(X)	(X)					
Q	(X)	(X)					

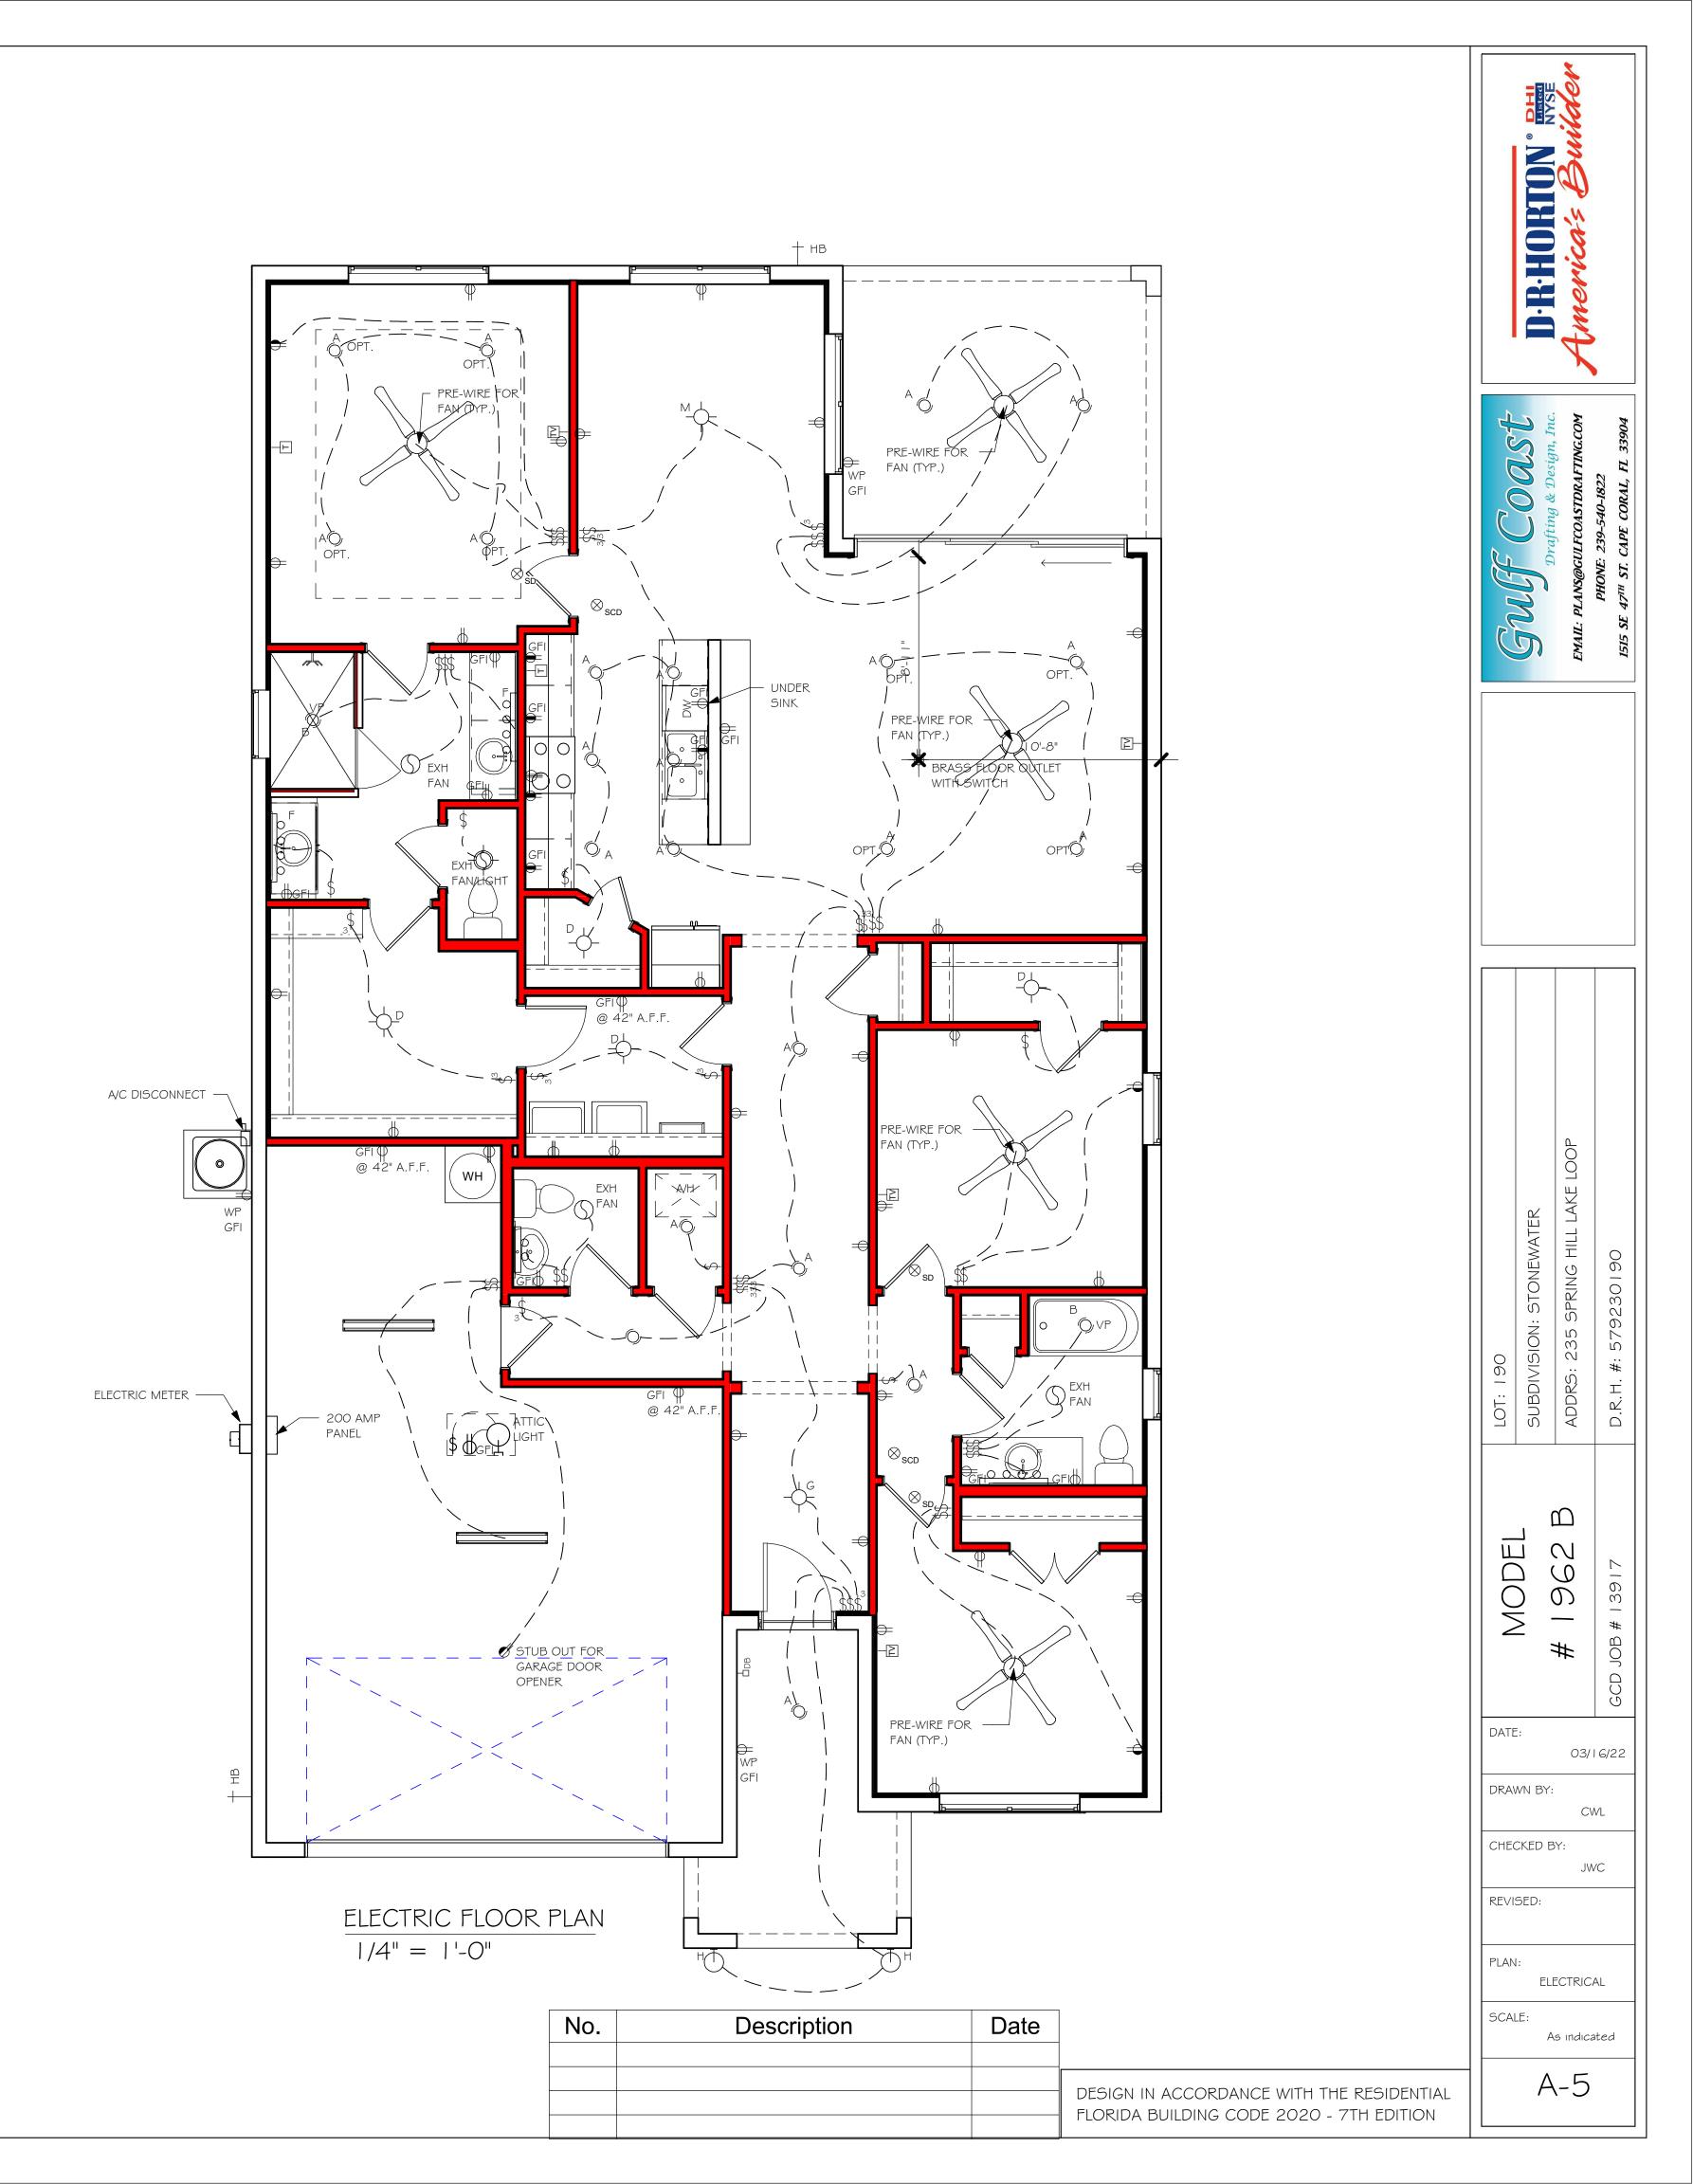

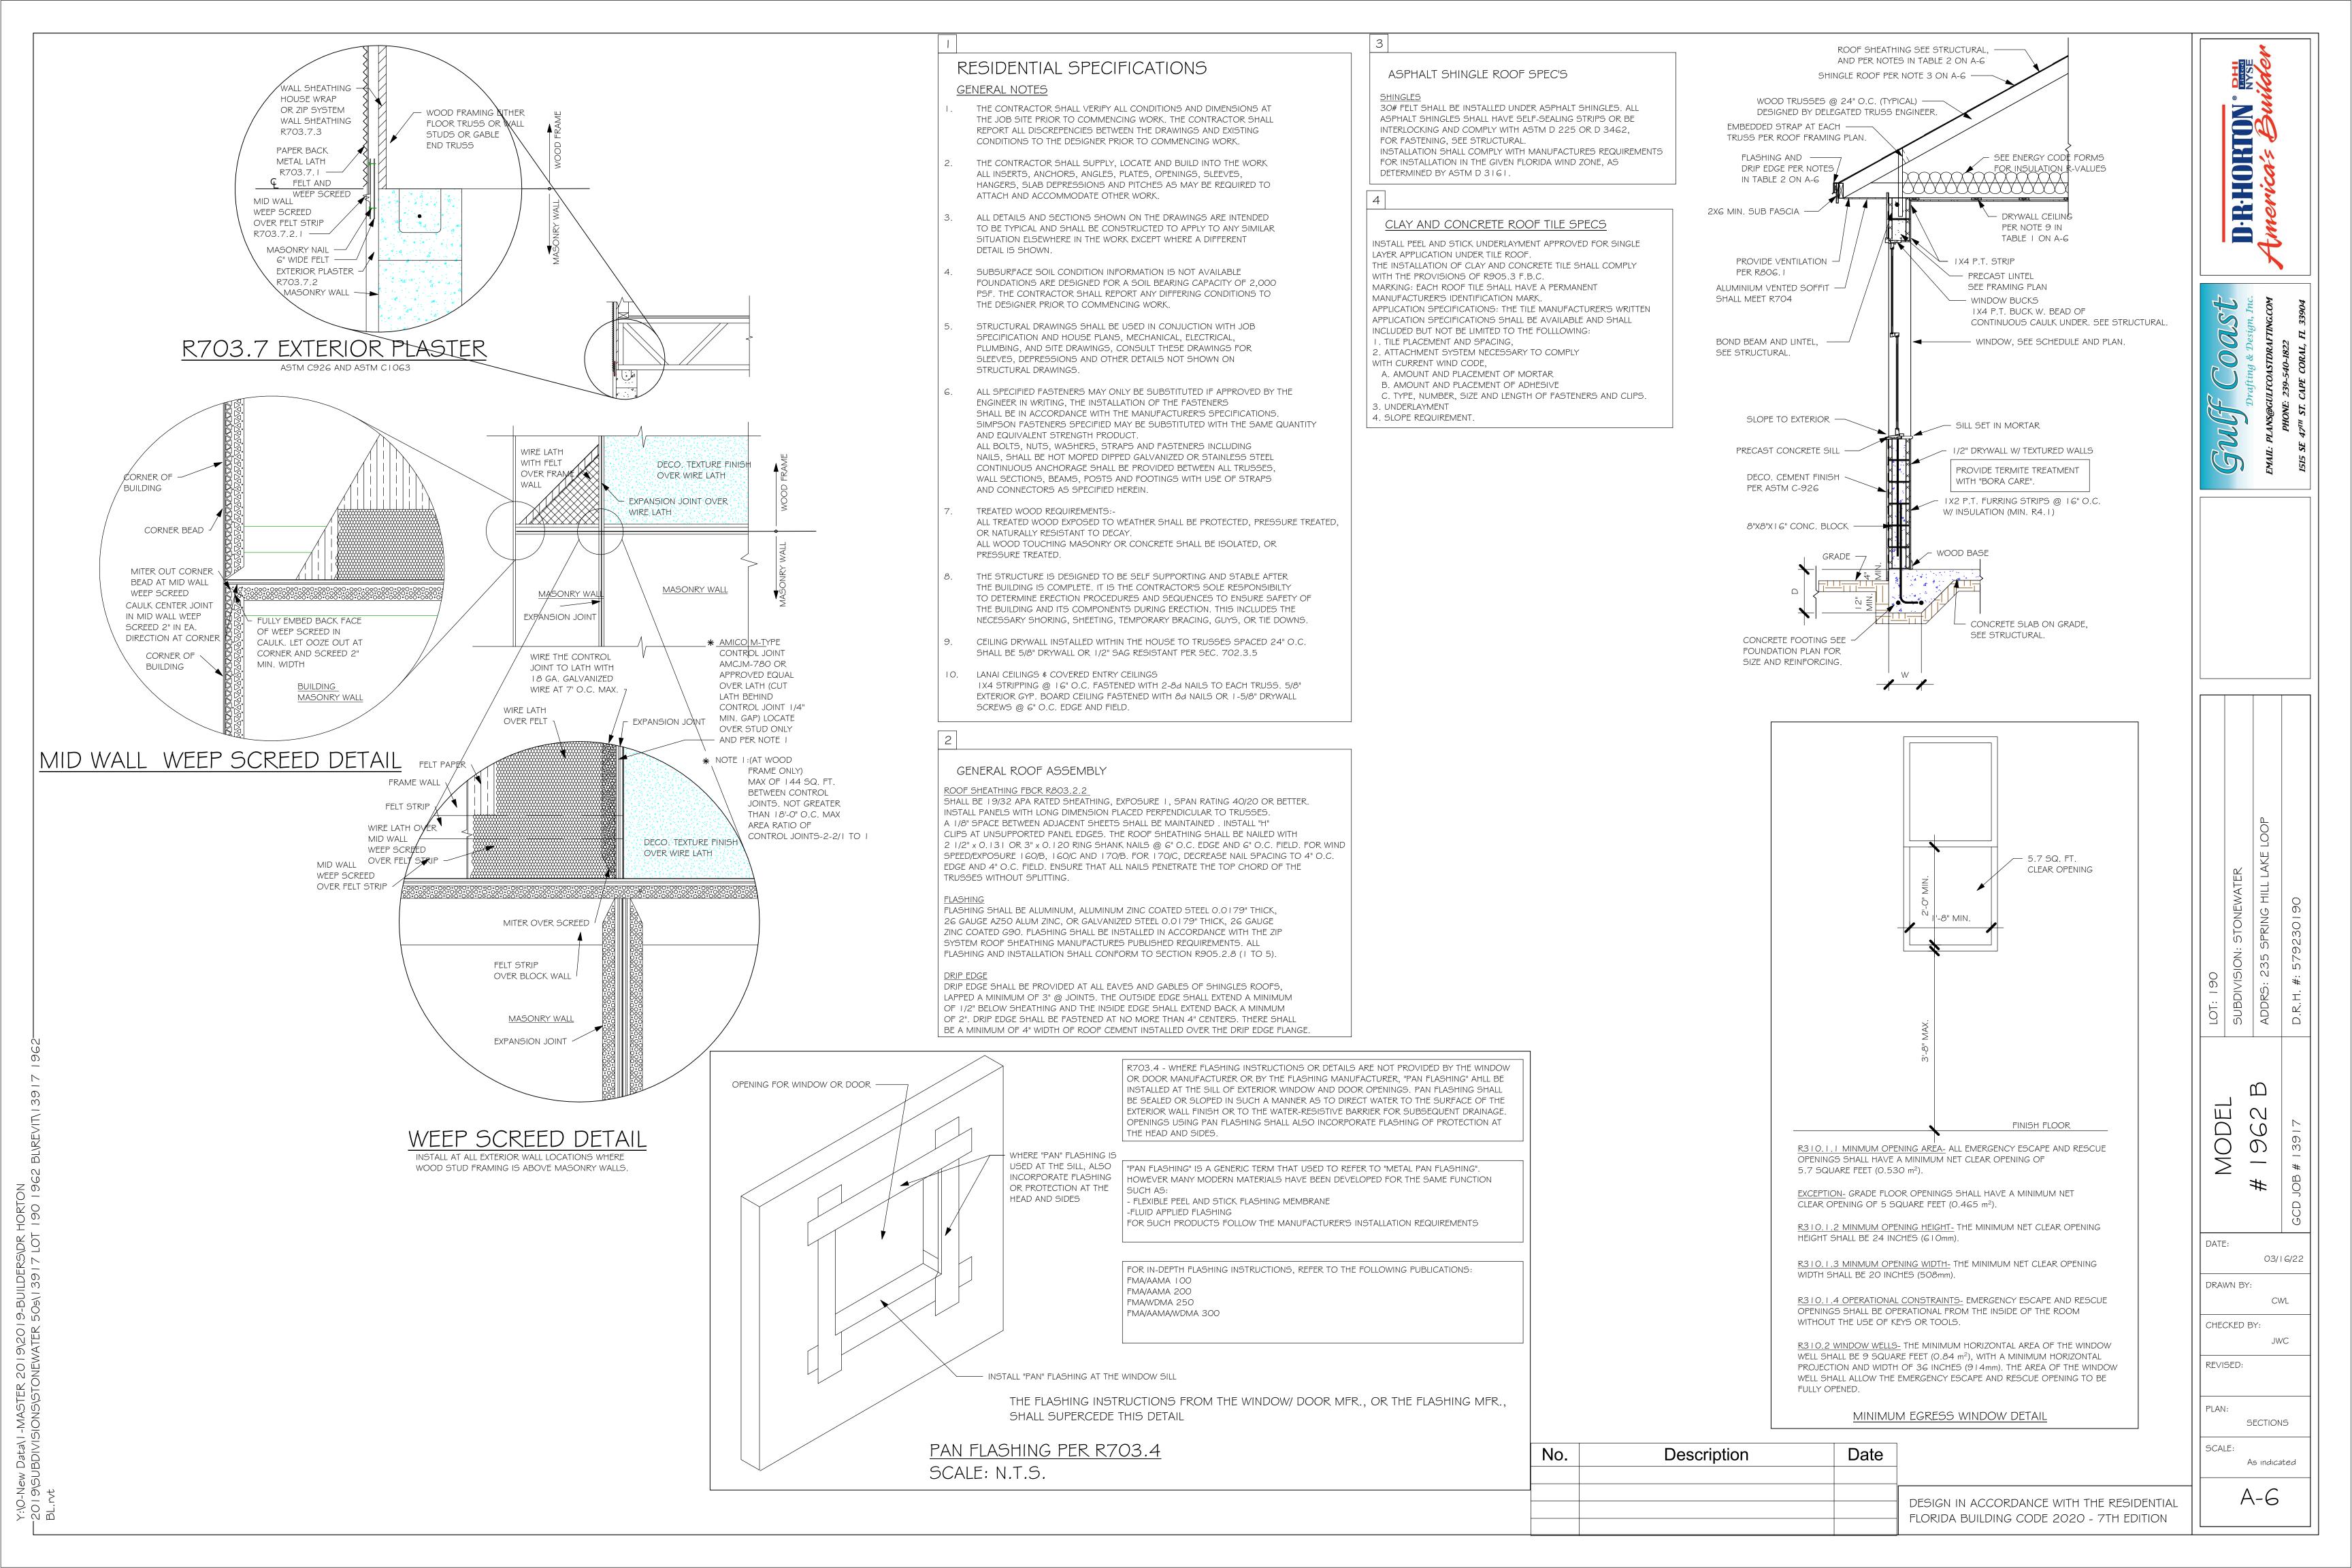

JOB No.	MASTER
DATE DRAWN	2/1/2022
DATE PRINTED	3/2/2022

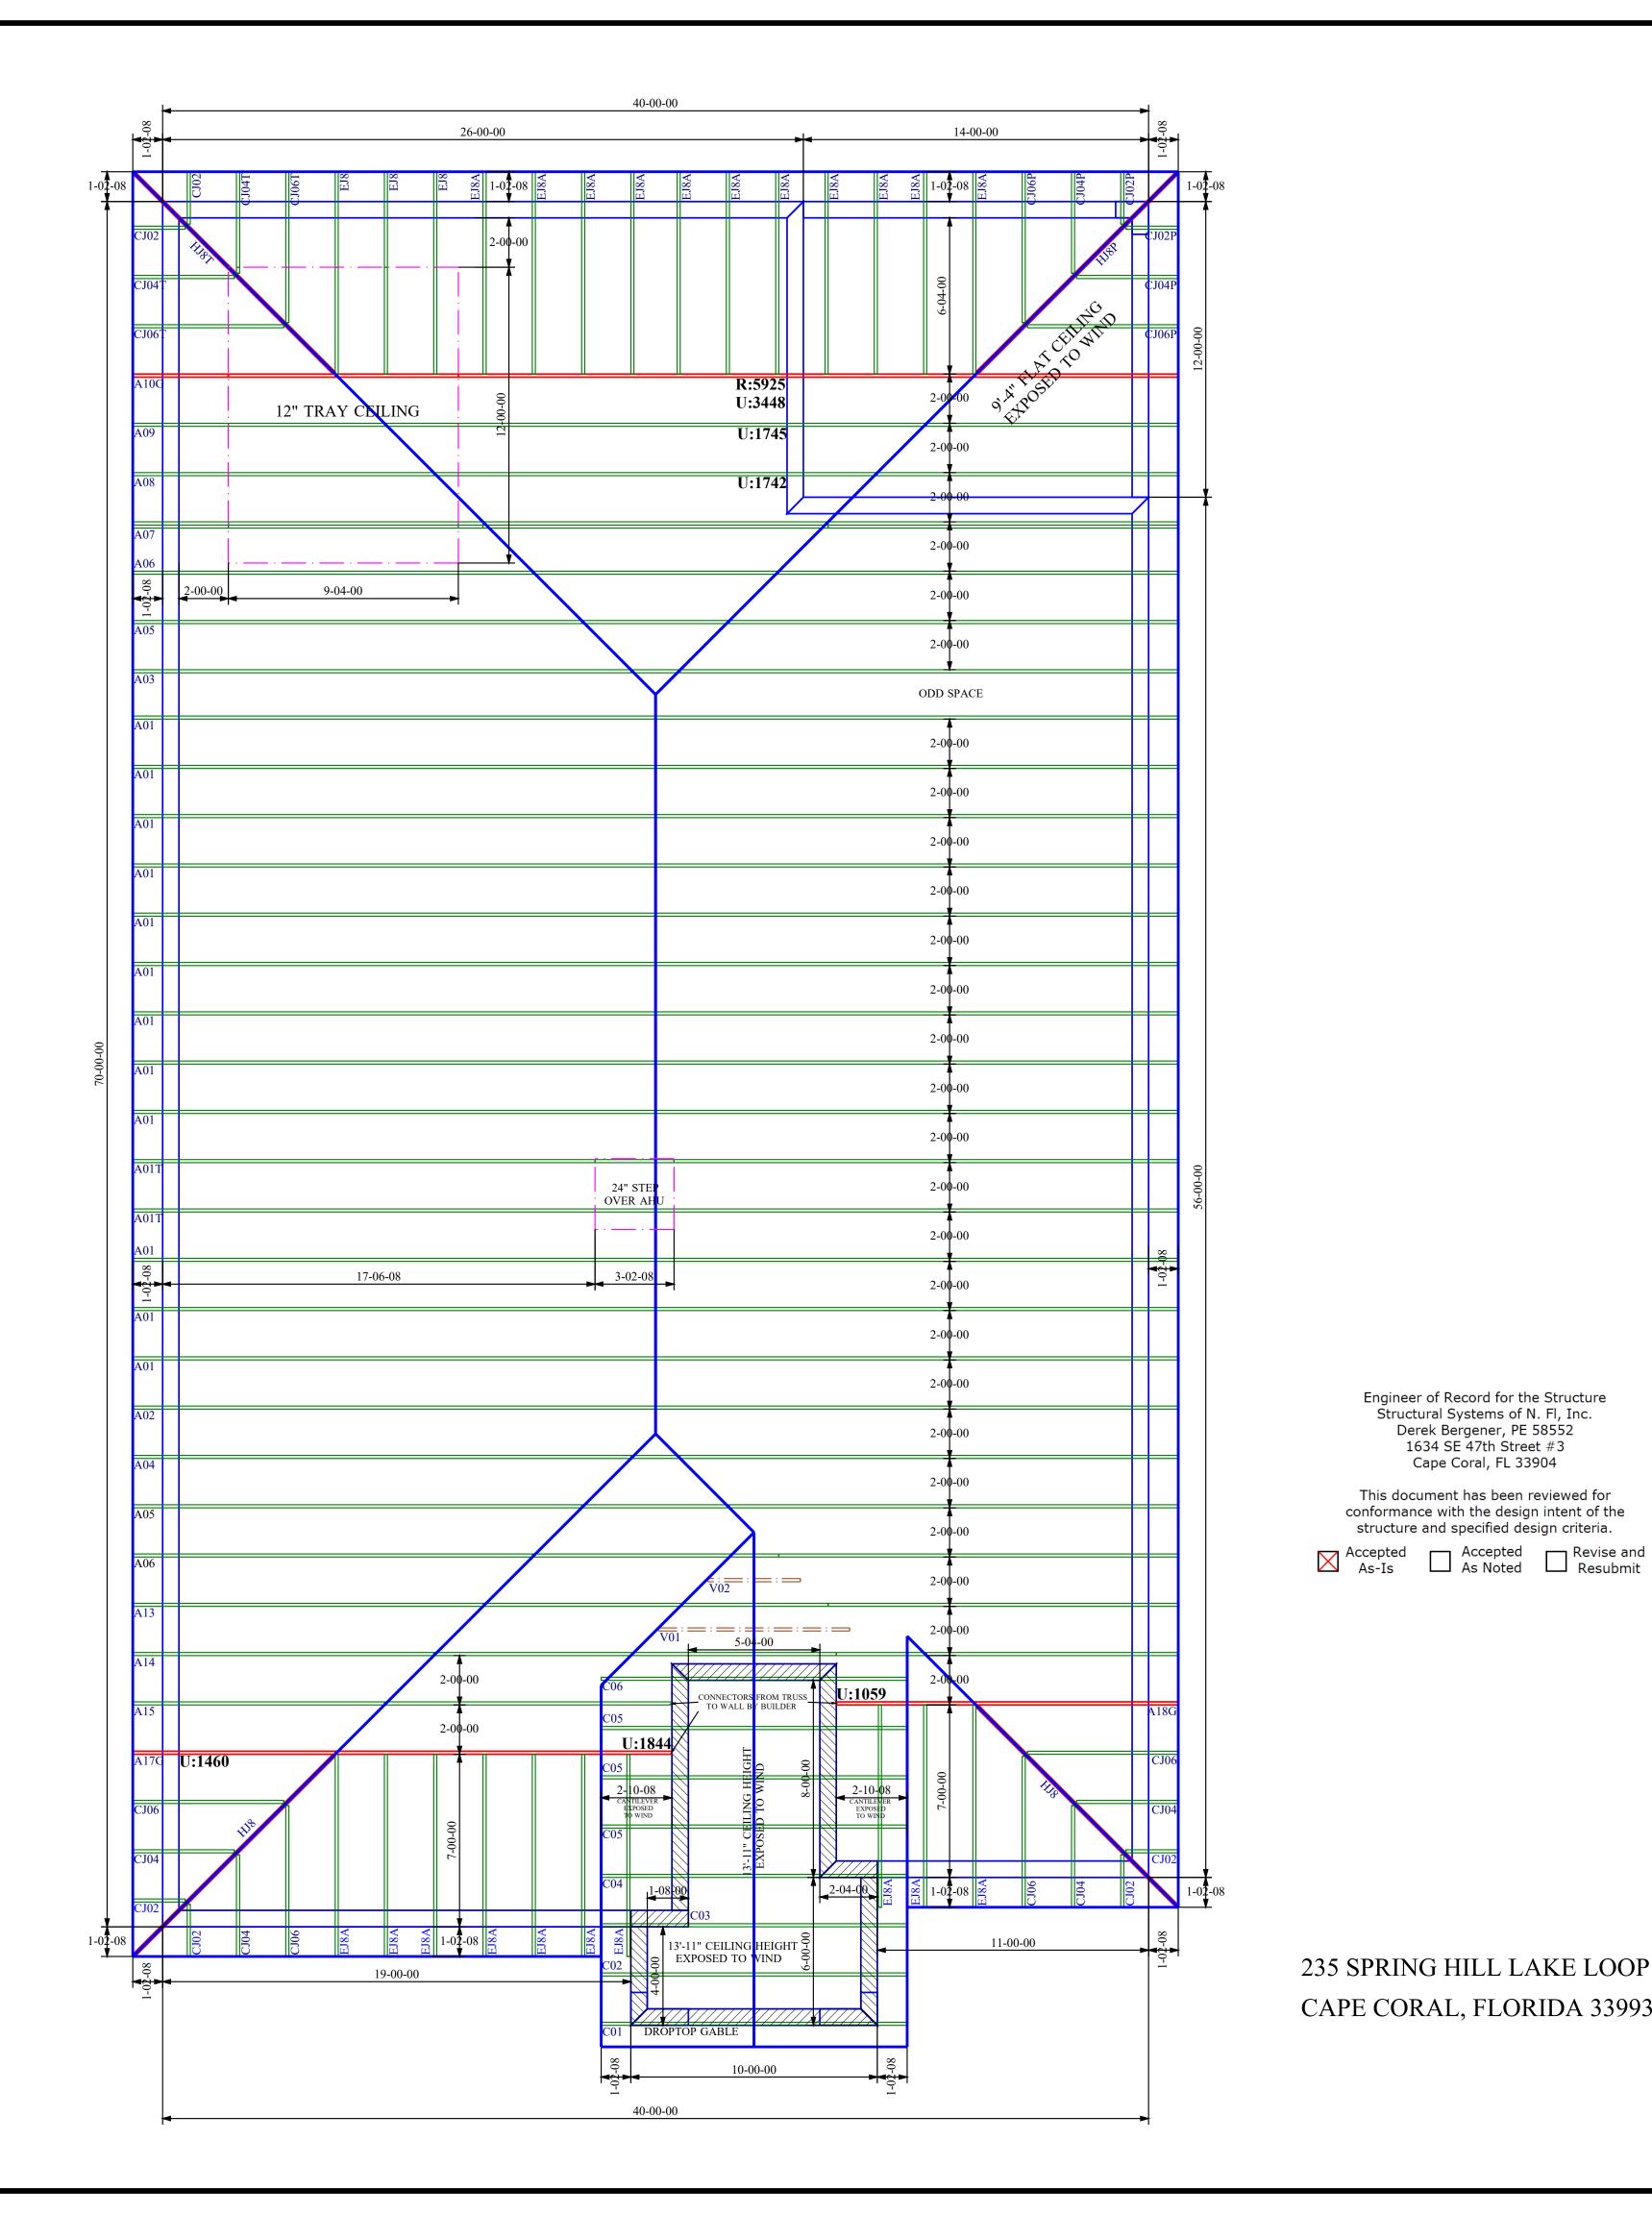

GENERAL TRUSS ENGINEERING CRITERIA & DESIGN LOADS MWFRS (Directional)/C-C HYBRID WIND ASCE 7-16 160 MPH ENCLOSED LIVE LOAD NONCONCURRENT WITH ANY OTHER LIVE LOADS ROOF DURATION OTHER THAN TRUSS TO TRUSS, GABLE SHEAR WALL, AND CONNECTIONS. TCDL / TO RESIST UPLIFT TEMPORAY AND PERMANENT BRACING, AND CEILING AND ROOF DIAPHRAM BCDL / TO RESIST UPLIFT CONNECTIONS. ROOF PITCH CEILING PITCH


SHINGLE ROOF— 2x4 T.C. MIN.— 8" BRG.

235 SPRING HILL LAKE LOOP CAPE CORAL, FLORIDA 33993

Engineer of Record for the Structure Structural Systems of N. Fl, Inc.

Derek Bergener, PE 58552 1634 SE 47th Street #3 Cape Coral, FL 33904

This document has been reviewed for conformance with the design intent of the structure and specified design criteria.

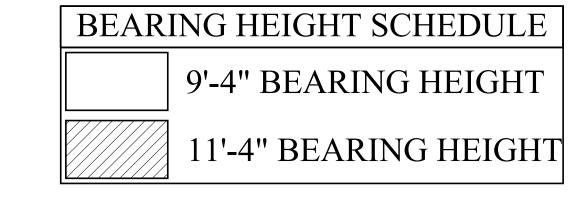

TYP. ROOF TRUSS END DETAIL

N.T.S.

) ALL DIMENSIONS ARE FEET-INCHES-SIXTEENTHS.

2) DO NOT CUT OR ALTER TRUSSES IN ANY WAY.) ALL REACTIONS ARE UNDER 5000 LBS. UNLESS NOTE OTHERWISE.

ALL UPLIFTS ARE UNDER 1000 LBS. UNLESS NOTED OTHERWISE.

FRAMING REQUIRED BELOW TRUSSES TO GET DESIRED CEILING CONDITIONS. 6) ONLY TRUSS TO TRUSS CONNECTIONS SUPPLIED W/ TRUSS PACKAGE.

CAUTION!!! DO NOT ATTEMPT TO ERECT TRUSSES DESIGN CODE | FBC2020/TPI2007 WITHOUT REFERRING TO THE ENGINEERING DRAWINGS AND BSCI-B1 SUMMARY SHEETS. WIND CODE ALL PERMANENT BRACING MUST BE IN WIND LOAD PLACE PRIOR TO LOADING TRUSSES. (ie. SHEATHING, SHINGLES, ETC.) EXPOSURE CATEGORY ALL INTERIOR BEARING WALLS MUST BE IN OCCUPANCY CATEGORY PLACE PRIOR TO INSTALLING TRUSSES. REFER TO FINAL ENGINEERING SHEETS FOR IMPORTANCE FACTOR THE FOLLOWING. WIND DURATION FACTOR 1) NUMBER OF GIRDER PLIES AND NAILING SCHEDULE. **OPENING CONDITIONS** 2) BEARING BLOCK REQUIREMENTS. TRUSSES HAVE BEEN DESIGNED FOR A 10.0 PSF BOTTOM CHORD 3) SCAB DETAILS (IF REQUIRED) 4) UPLIFT AND GRAVITY REACTIONS. TRUSS LOADING TCLL WARNING BACK CHARGES WILL NOT BE **TCDL** ACCEPTED REGARDLESS OF FAULT WITHOUT PRIOR NOTIFICATION BY BCLL CUSTOMER WITHIN 48 HOURS AND INVESTIGATION BY Builders FirstSource. **BCDL** NO EXECPTIONS. **TOTAL** THE GENERAL CONTRACTOR IS RESPONSIBLE FOR ALL CONNECTIONS

> CANTILEVER 14 1/2" PLUMB END CUT FLOOR TRUSS SPACING N/A ROOF TRUSS SPACING BUILDER DR Horton PROJECT MODEL 1962 B LH ADDRESS CITY, STATE --, FL. COUNTY DRAWN BY D.W. D.W. ENG. BY

TOP CHORD SIZE

BOTTOM CHORD SIZE

OVERHANG LENGTH

FLAT

2 x 4 MIN.

2 x 4 MIN.

N/A

DATE NOTES

REVISIONS


IMPORTANT

This Drawing Must Be Approved And Returned Before Fabrication Will Begin. For Your Protection Check All Dimensions And Conditions Prior To Approval Of Plan. SIGNATURE BELOW INDICATES ALL NOTES


AND DIMENSIONS HAVE BEEN ACCEPTED.

6850 Taylor Road Punta Gorda, Fl. 33950 Phone: 941-575-2250 / Fax:941-575-0319




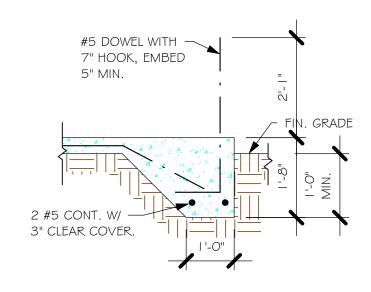


 $\frac{\text{"F3" FOOTING}}{1/2\text{"} = 1\text{'-0"}}$

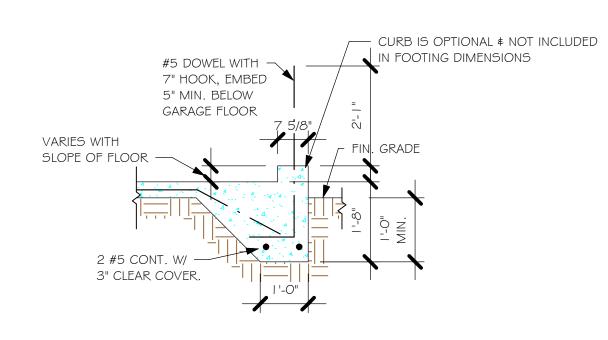


 $\frac{\text{"F3" WITH CURB AT GARAGE}}{1/2\text{"} = 1\text{'-0"}}$

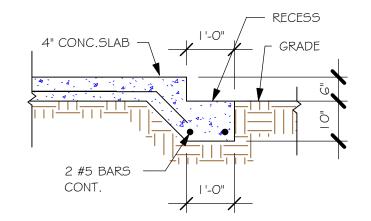

 $\frac{\text{"GARAGE DOOR RECESS}}{1/2\text{"} = 1\text{'-0"}}$

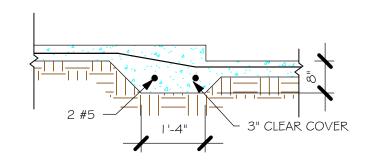

 $\frac{\text{"F6" STEP DOWN}}{1/2\text{"} = 1\text{'-0"}}$

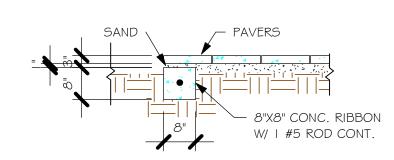



"P" PAVERS DETAIL ENTRY/ LANAI 1/2" = 1'-0"

	W						
USED	TYPE	LENGTH	WIDTH	DEPTH	BOTTOM REINFORCING	SHAPE	
	F1	CONT.	1'-4"	0'-8"	2-#5		
	F2	CONT.	1'-8"	0'-10"	2-#5		
X	F3	CONT.	1'-0"	1'-8"	2-#5	₩	ADD CURB TO GARAGE, SEE DETAIL
	F4	CONT.	1'-4"	1'-8"	2-#5		DETAIL
	F5	CONT.	1'-4"	1'-0"	2-#5	—	
	F6	CONT.	1'-4"	1'-0"	2-#5	-	
X	F6A	CONT.	0'-8"	0'-8"	1-#5		
	TE	CONT.	0'-8"	0'-8"	1-#5	P	
					-		

PROVIDE CORNER BARS PER 6/5-3

	PAD FOOTING SCHEDULE							
TYPE	LENGTH	WIDTH	DEPTH		OM REINF.	REMARKS		
5				LONG WAY	SHORT WAY			
$\langle \mathbf{A} \rangle$	2'-6"	2'-6"	1'-0"	3-#5	3-#5	-		
B	3'-0"	3'-0"	1'-0"	4-#5	4-#5	-		
(C)	3'-6"	3'-6"	1'-0"	4-#5	4-#5	-		
(D)	4'-0"	4'-0"	1'-2"	5-#5	5-#5	-		
(E)	5'-0"	5'-0"	1'-2"	6-#5	6-#5	-		
⟨F ⟩	3'-0"	2'-6"	1'-0"	3-#5	4-#5	-		

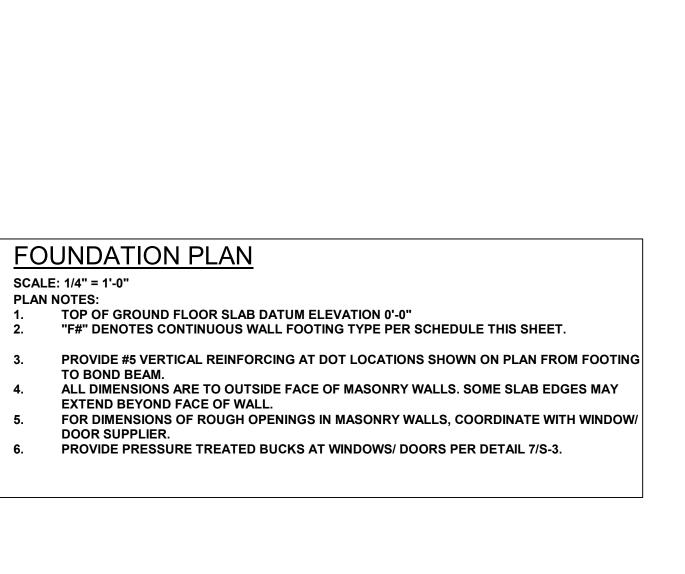

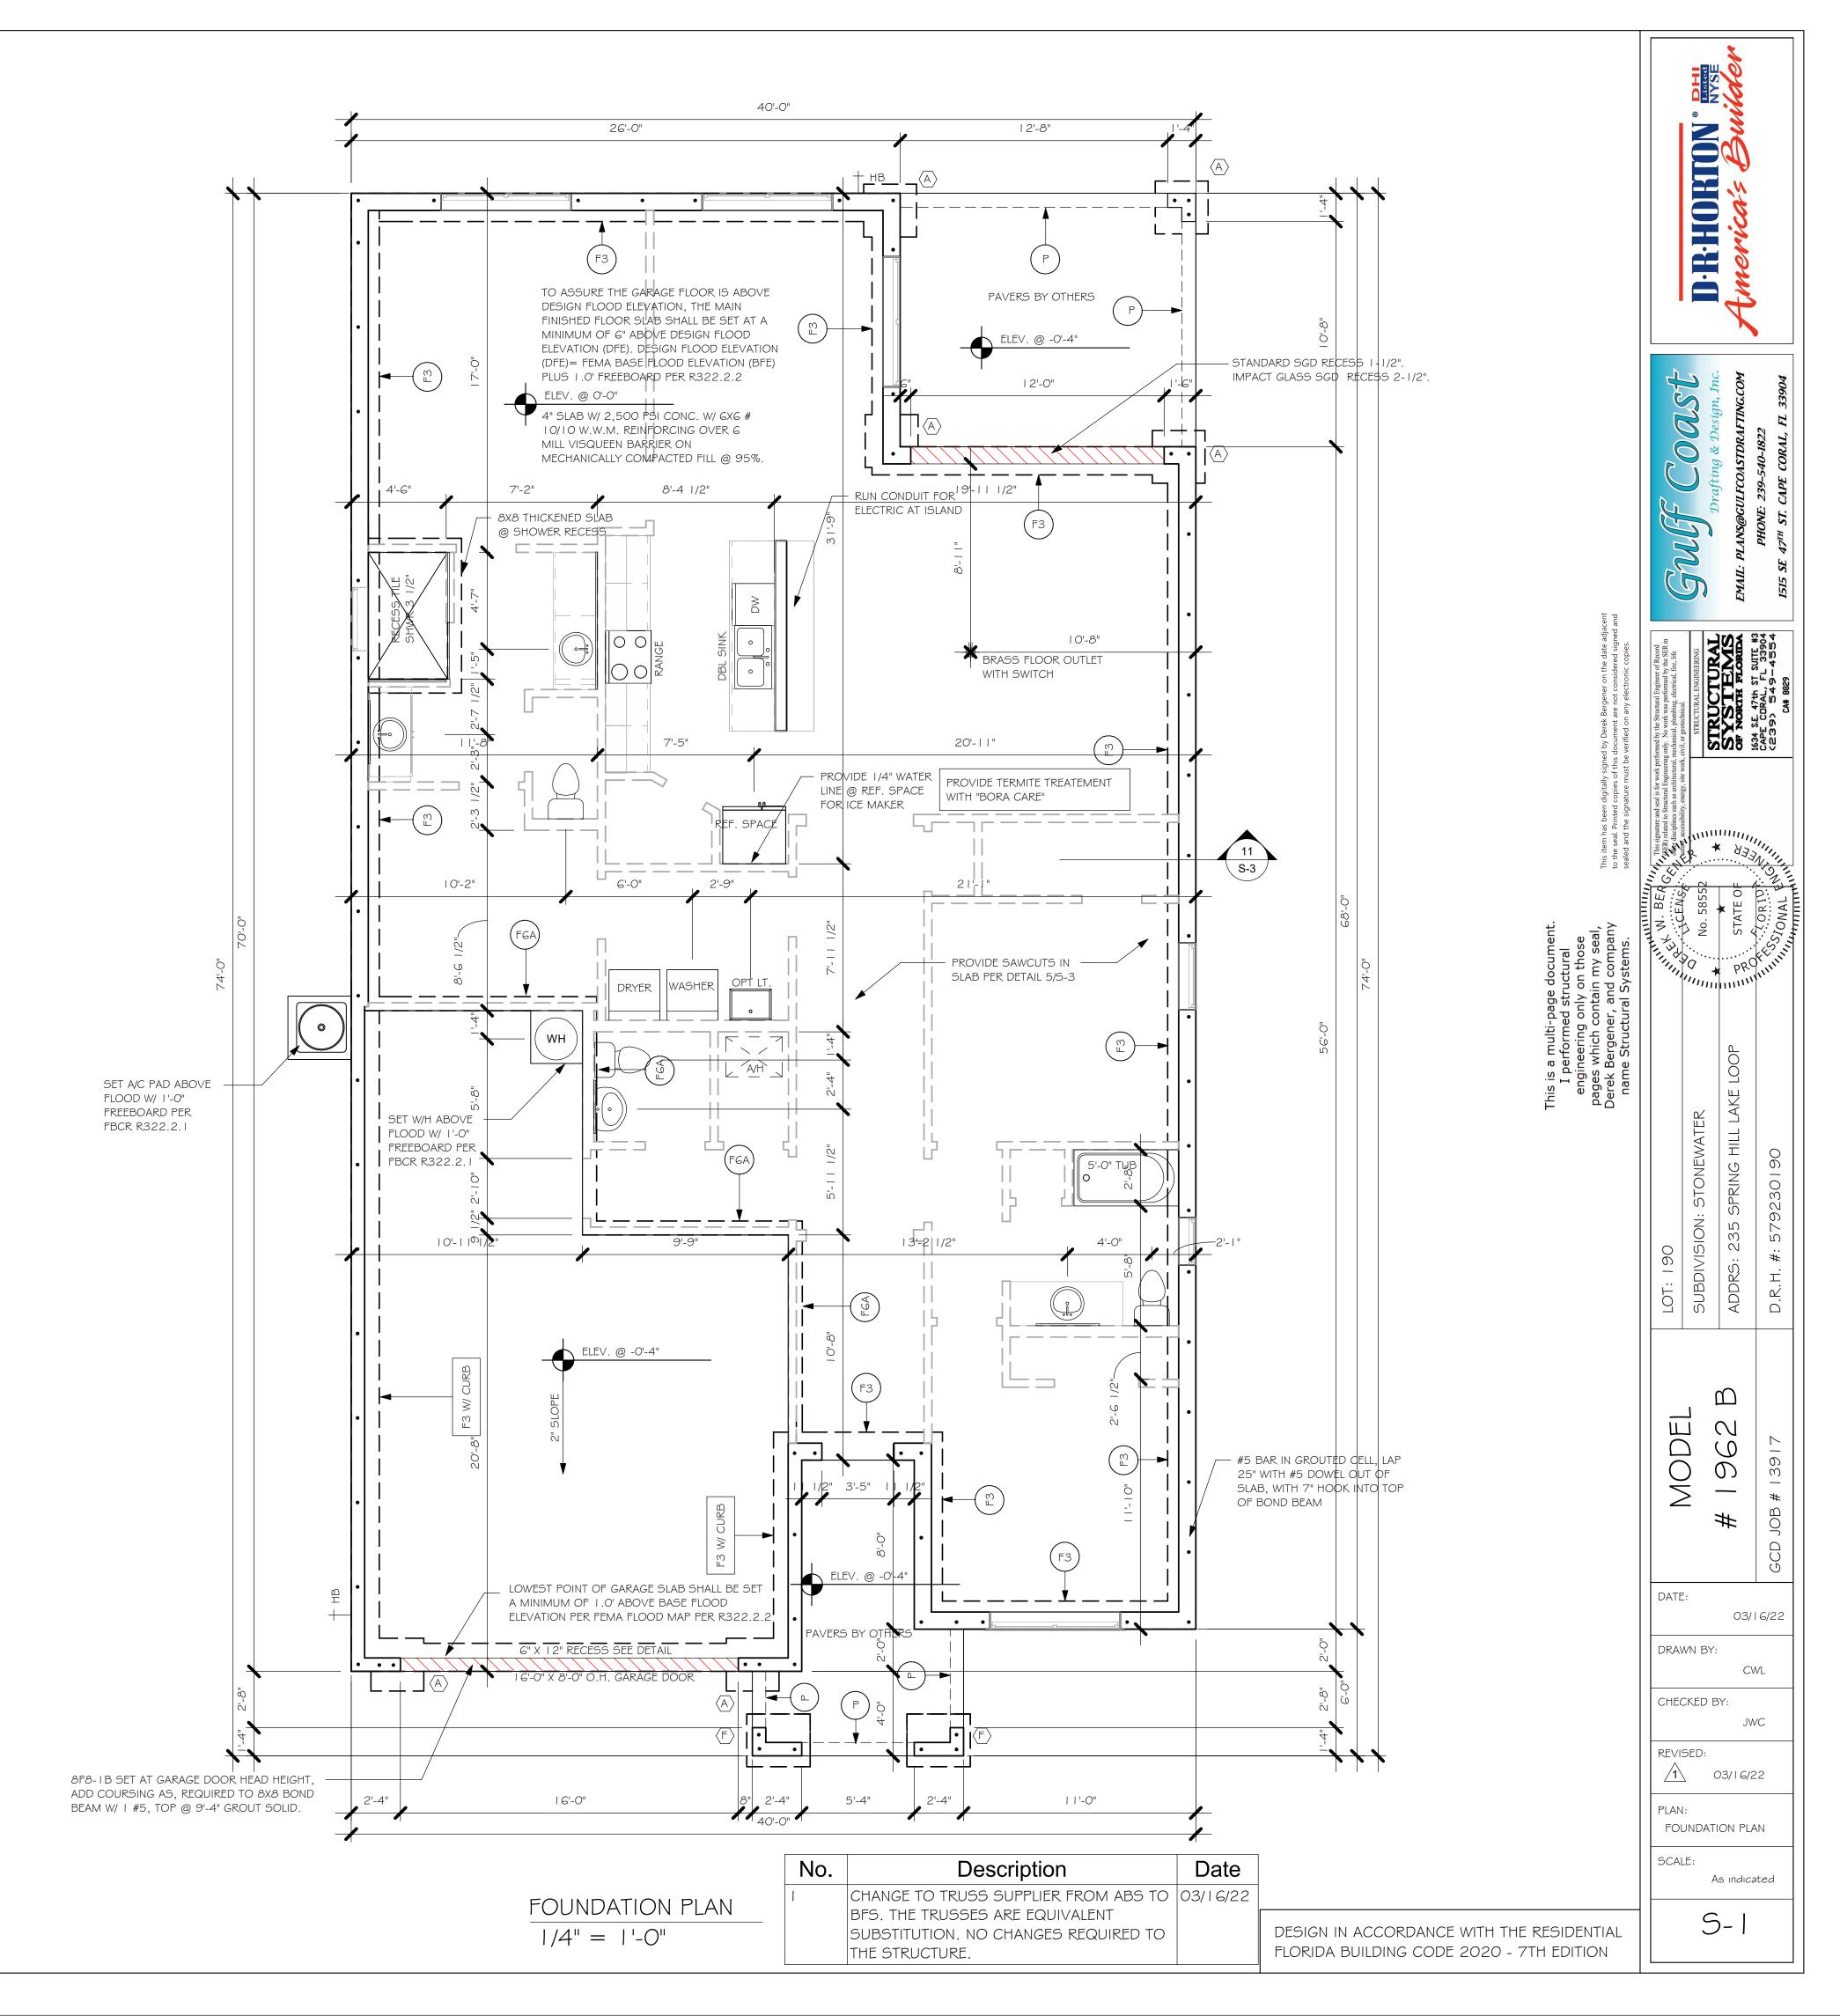

NOTES:

PROVIDE A STRAP FROM THE ABOVE LIST AT EACH ROOF TRUSS BEARING POINT, BASED ON THE TRUSS UPLIFT VALUES IN THE SIGNED AND SEALED TRUSS DESIGN PACKAGE AND SUITABLE FOR THE GEOMETRY. EMBED STRAP ON CENTERLINE OF WALL.

ANY OF THE VALID LENGTHS SHOWN MAY BE USED IN PLACE OF THE LENGTH SPECIFIED ON PLAN.

CONNECTORS ARE SIMPSON STRONG TIE. ALL CONNECTORS SHALL BE INSTALLED IN STRICT ACCORDANCE WITH SIMPSON PRINTED INSTUCTIONS. SUBSTITUTIONS MUST BE APPROVED IN WRITING BY THE ENGINEER OF RECORD.

WHERE EMBEDDED STRAPS ARE MISSING, OR MIS-LOCATED, INSTALL RETROFIT STRAP PER 10/S-3. PER UPLIFT IN TRUSS ENGINEERING.

SIMPSON CATALOG C-C- 2021

INSTALL AT ALL	TRUSS STRAPPING TO STUDWALL/ WOOD BEAM					
TRUSSES TO 850 Ib UPLIFT.	MAX TRUSS UPLIFT (LBS)	STRAP(S) Valid lengths x/x/x	FASTENER			
FOR HIGHER - UPLIFTS, SEE NOTES ON	►850 1700 2550	(1)MT5 6/20/30 (2) MT5 6/20/30 (3) MT5 6/20/30	(14) 0.148x1-1/2" or 3" EACH STRAP			
PLAN.	1125 2250 3375 4500	(1) HTS20/24/30 (2) HTS20/24/30 (3) HTS20/24/30 (4) HTS20/24/30	(24) 0.148x1-1/2" OR (20) 0.148x3" EACH STRAP			

NOTES:

PROVIDE A STRAP FROM THE ABOVE LIST AT EACH ROOF TRUSS BEARING POINT, BASED ON THE TRUSS UPLIFT VALUES IN THE SIGNED AND SEALED TRUSS DESIGN PACKAGE.

2. ANY OF THE VALID LENGTHS SHOWN MAY BE USED IN PLACE OF THE

LENGTH SPECIFIED ON PLAN.

1-1/2" NAIL SHALL BE USED IN 1 PLY LUMBER, 2 PLY LUMBER IS REQUIRED

FOR 3" NAILS.
CONNECTORS ARE SIMPSON STRONG TIE. ALL CONNECTORS SHALL BE

INSTALLED IN STRICT ACCORDANCE WITH SIMPSON PRINTED INSTUCTIONS.

SIMPSON CATALOG C-C- 2021

PLAN NOTES:

ROOF AND FLOOR TRUSS BEARING ELEVATION VARIES, SEE LEGEND.

ROOF AND FLOOR FRAMING SHALL BE WOOD TRUSSES DESIGNED BYA DELEGATED TRUSS ENGINEER PER DESIGN CRITERIA ON SHEET S-3.

. PROVIDE STRAPPING AT TRUSSES PER NOTES ON THIS SHEET.


FOR NAILING OF ROOF AND FLOOR DECK, SEE | AND 2 ON 5-3.


8F8-1B etc., DENOTES PRECAST LINTEL ABOVE DOORWINDOW OPENING PER SCHEDULE THIS SHEET.

6. AT TRUSS BEARING, PROVIDE 8x8 MASONRY BOND BEAM W/ I #5 CONTINUOUS, SEE DETAIL I I/S-3.
7. "SW" DENOTES PLYWOOD SHEARWALL PER SCHEDULE


THIS SHEET.




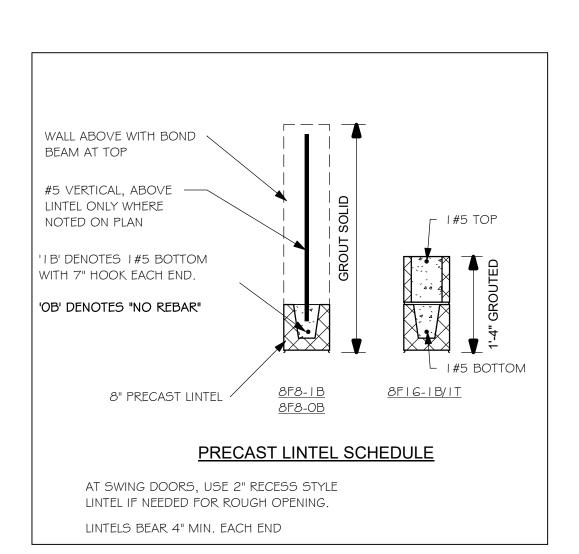


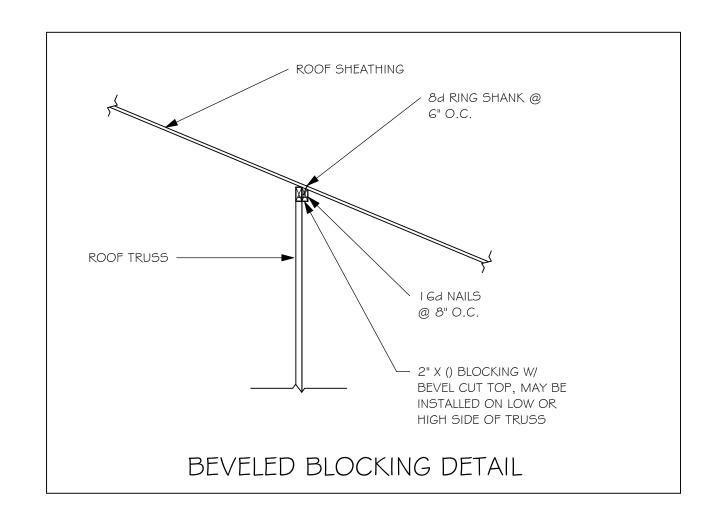

TRUSS BEARING CONDITIONS AND STRAPPING IS BASED ON TRUSS LAYOUT PREPARED BY BUILDERS FIRST SOURCE JOB# MASTER DATED 02/01/22 REVISED: 03/02/22

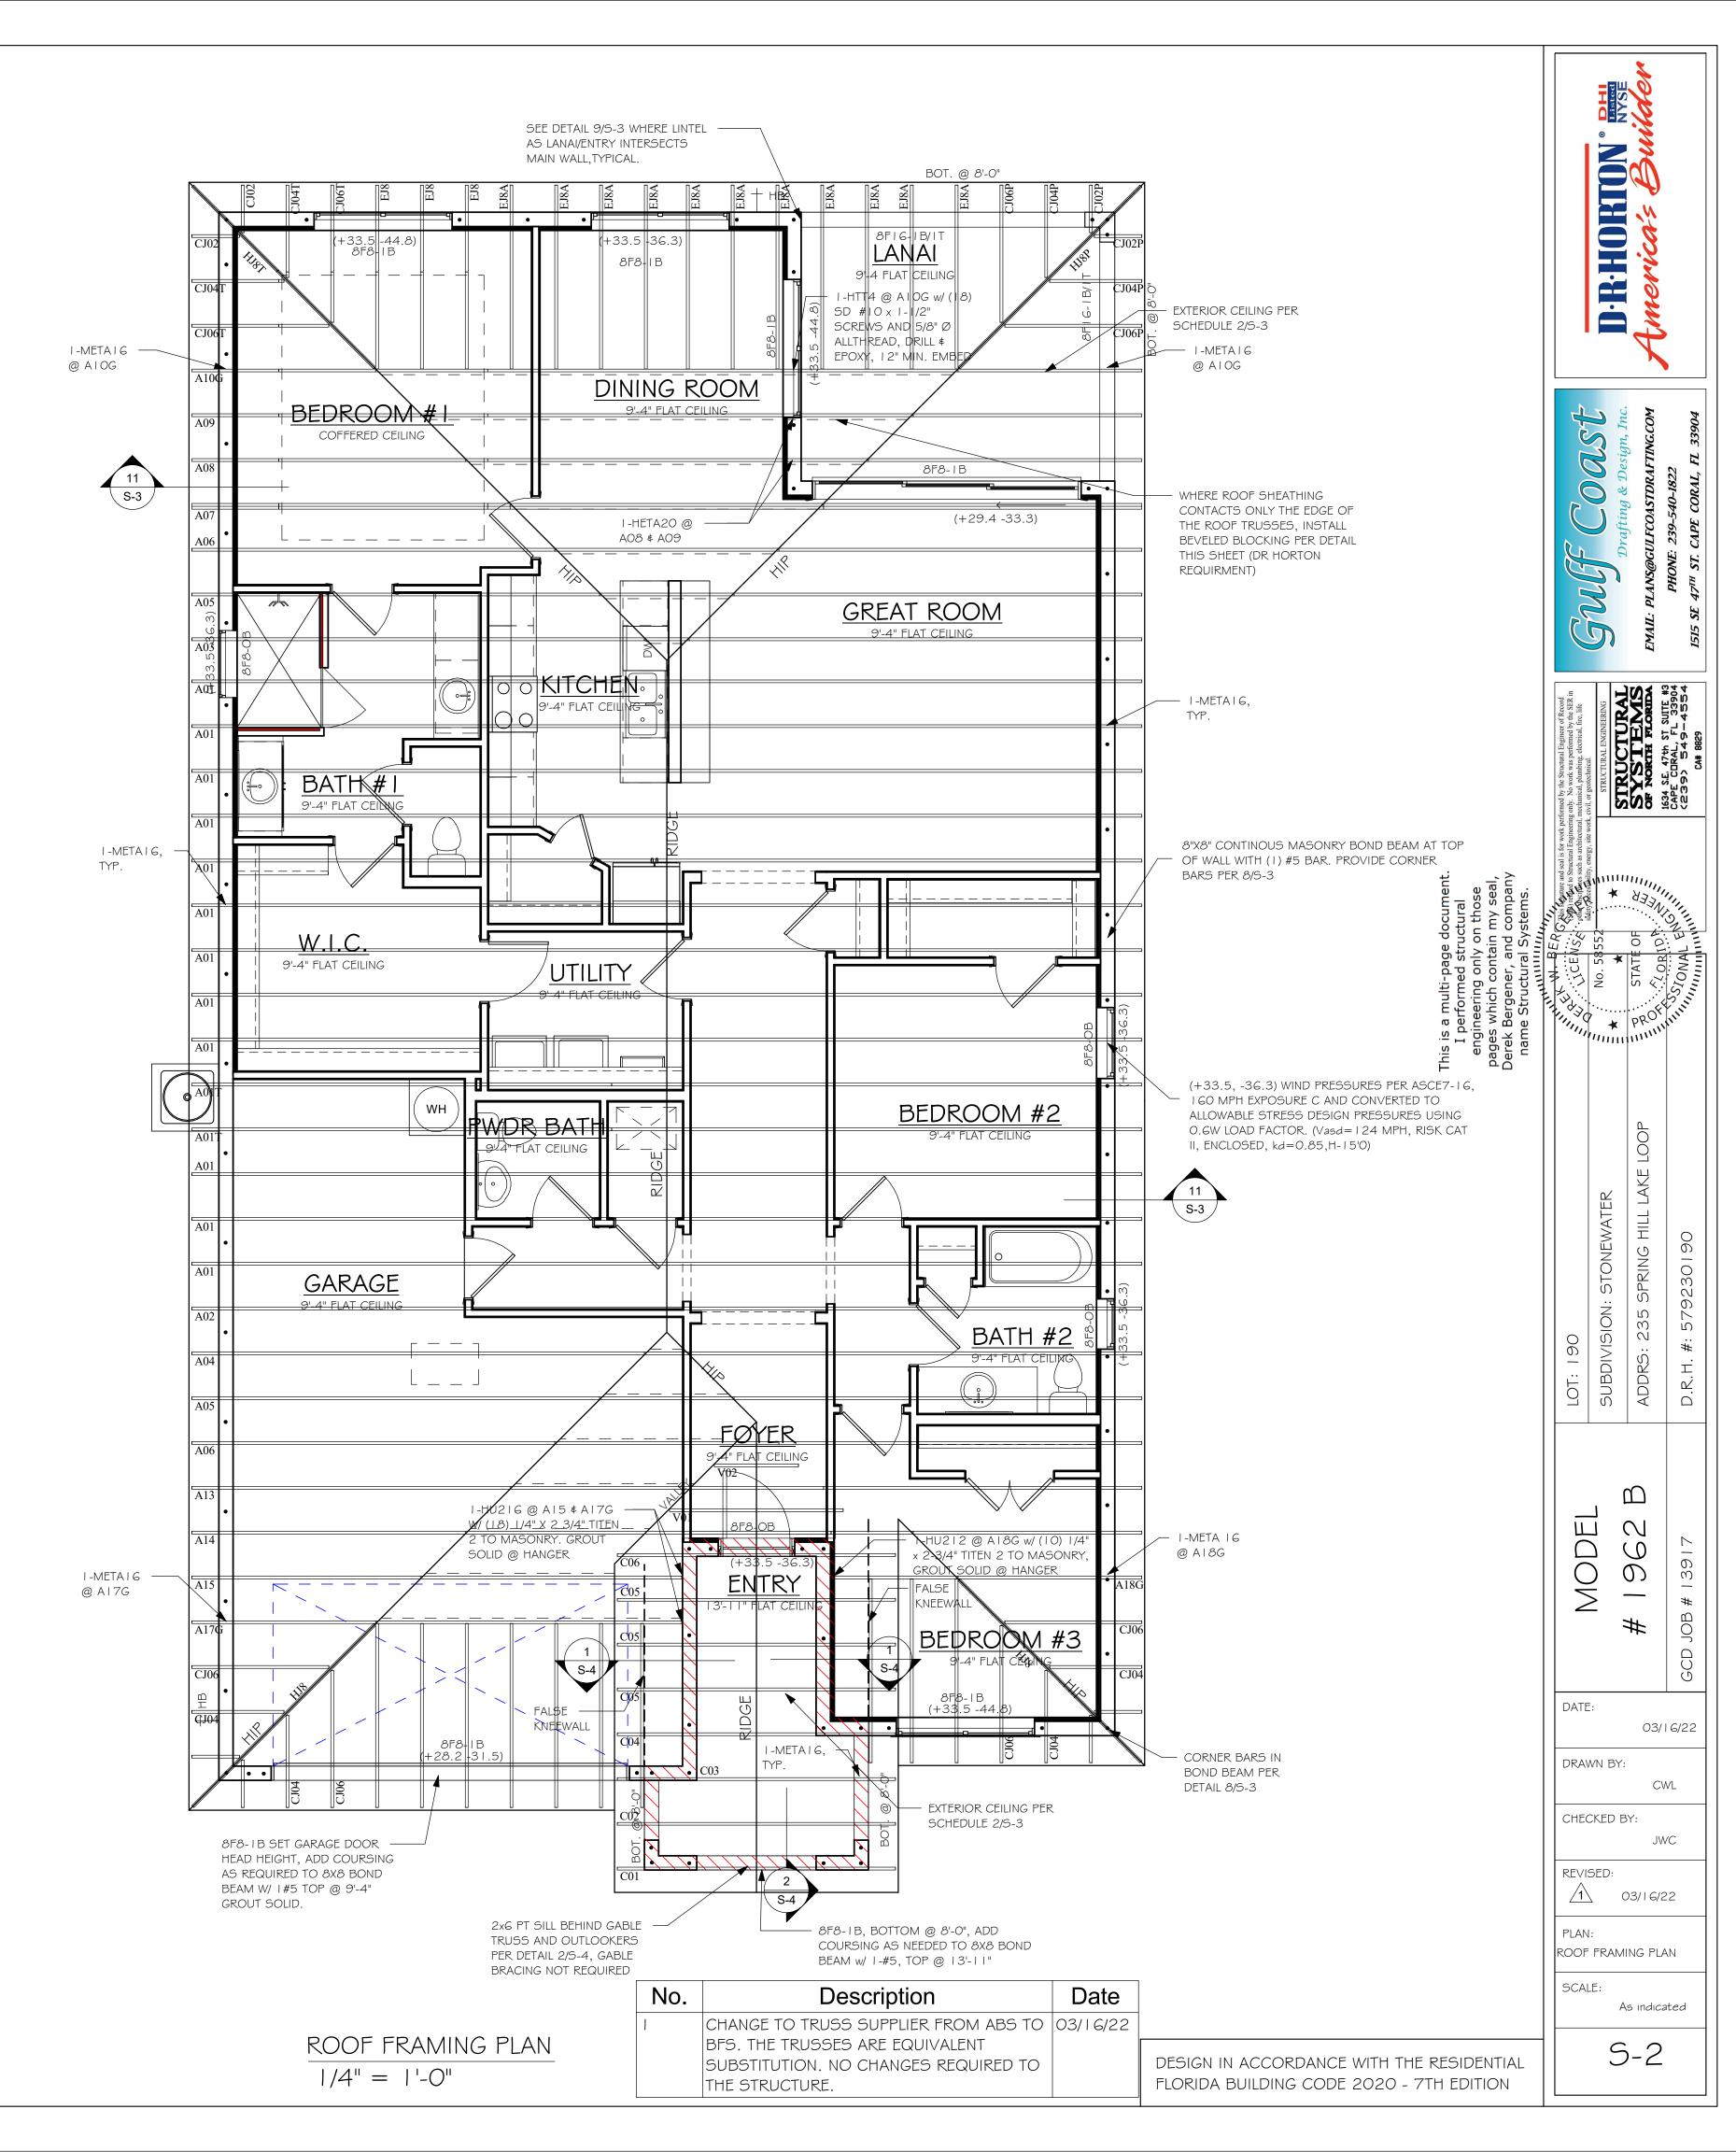

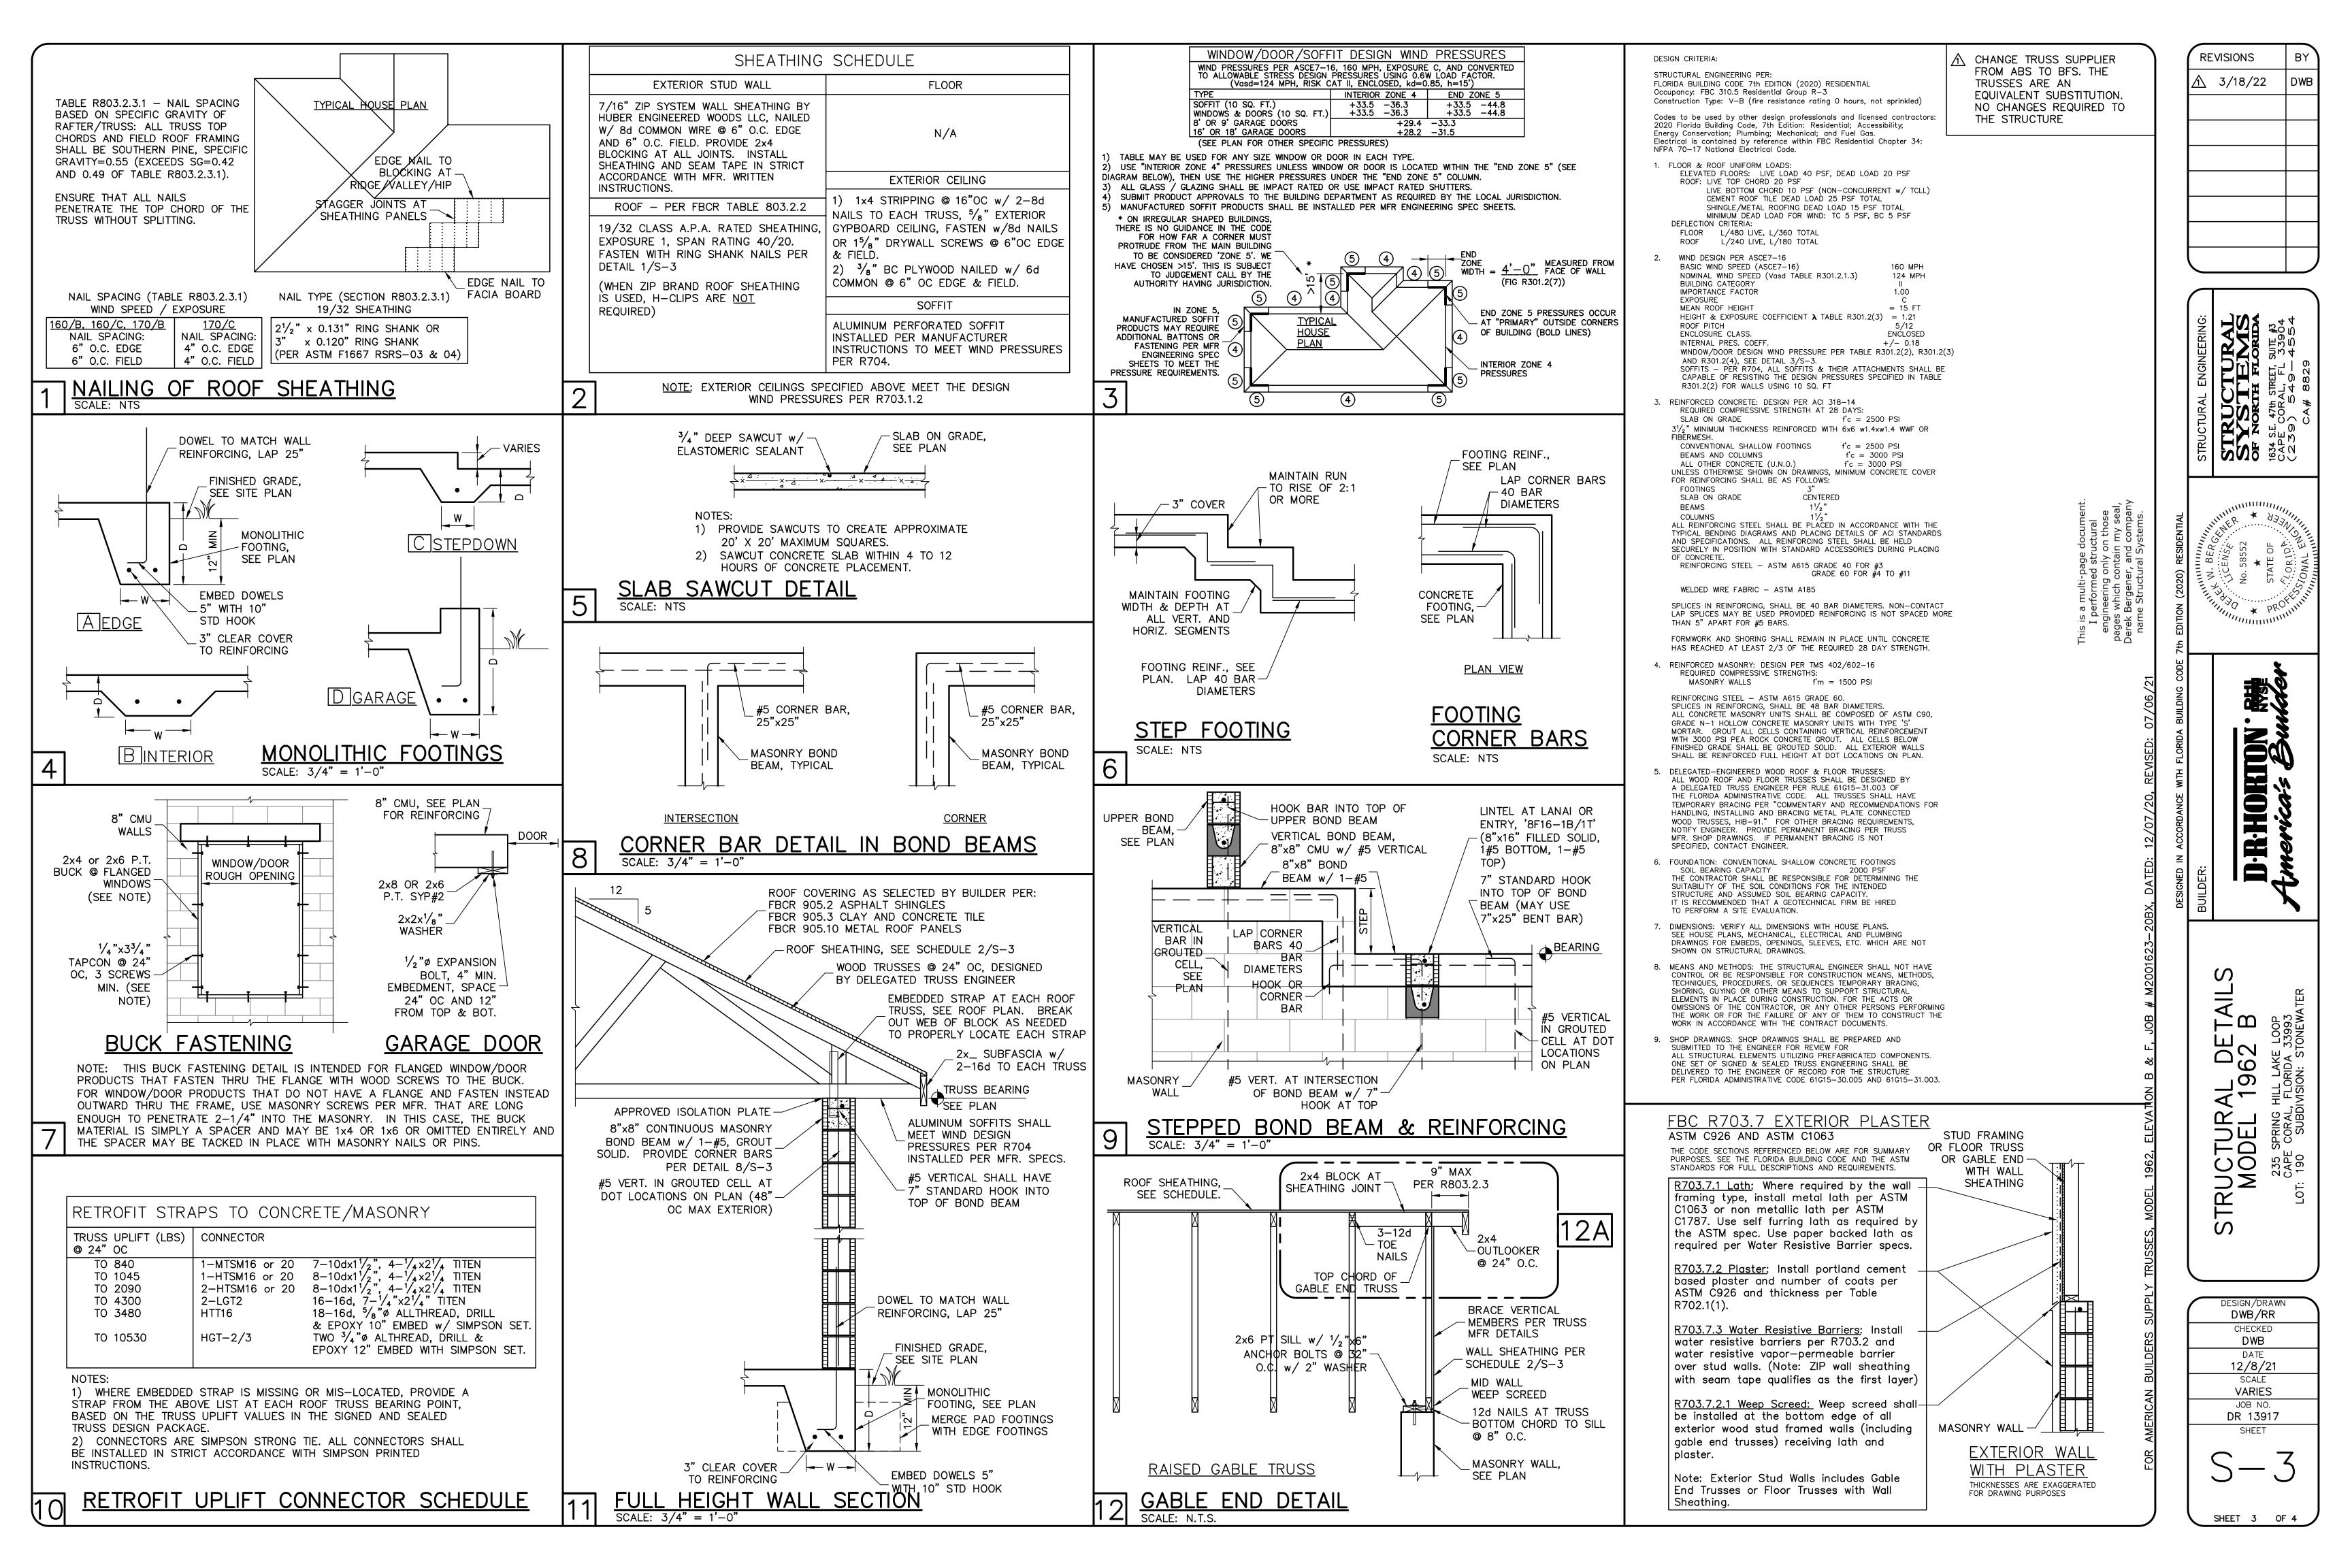

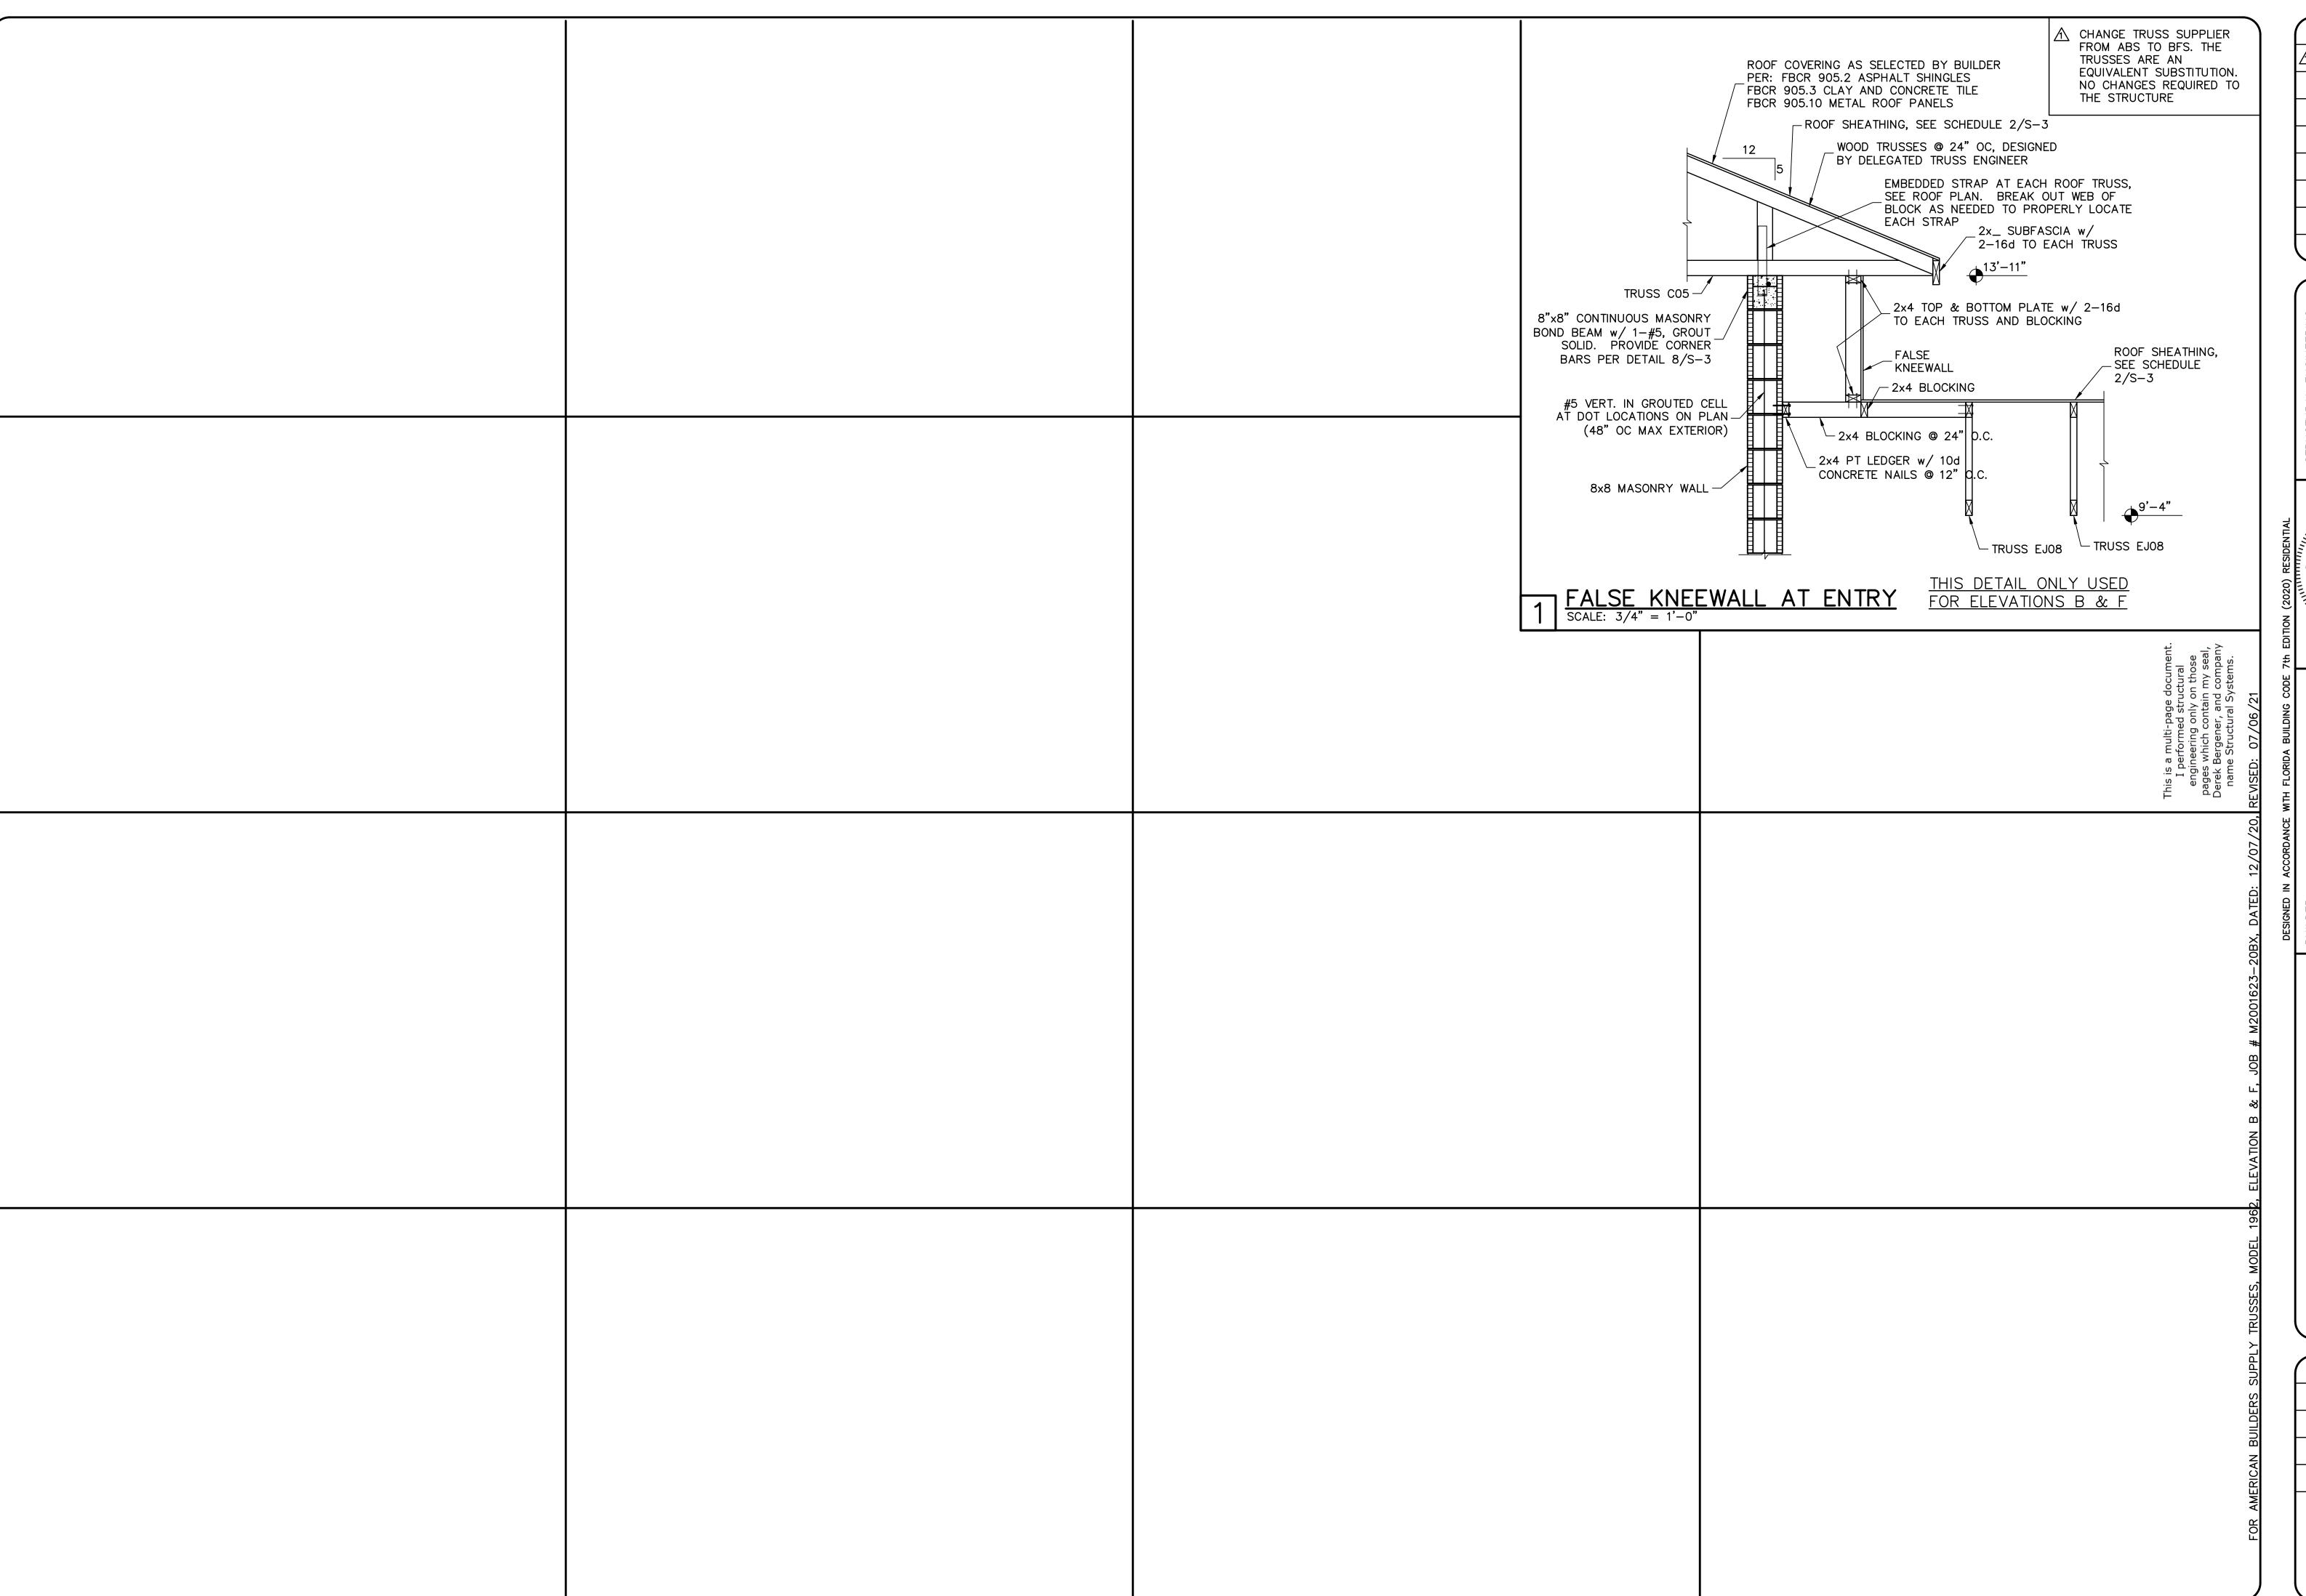

REVISIONS BY

3/18/22 DWB

STRUCTURAL SYSTEMS OF NORTH FLORIDA 1634 S.E. 47th SIRET, SUITE #3 CAPE CORAL, FL 33904 (239) 549-4554 CA# 8829

NO. 58552

STATE OF

STATE

D-R-HORMON |

BUILDER:

STRUCTURAL DETAILS MODEL 1962 B

DESIGN/DRAWN
DWB/RR

CHECKED
DWB

DATE
12/8/21

SCALE
VARIES
JOB NO.
DR 13917

SHEET

S-4

SHEET 4 OF 4