

Community Development Department


18400 Murdock Circle, Port Charlotte, FL 33948 Building Phone: 941.743.1201 | Building Fax: 941.764.4907 Zoning Phone: 941.743.1964 | Zoning Fax: 941.743.1598 BuildingSvcs@CharlotteCountyFL.gov www.CharlotteCountyFL.gov


Fo	r Office Use Only
	Permit Number
20	
	Application Date
CSRI	nitials

ONE AND TWO FAMILY DWELLING DATA SUMMARY SHEET Florida Building Code 7th Edition (2020)

OWNER'S NAME: D. I	R. Horton, Inc	CONTRACTOR'S NAM	D. R. Horton, Inc
PROJECT ADDRESS: 9661 MIAMI CIR			T CHARLOTTE 33981
• •	Number & Street uilding, Mechanical, Plumbing, ential Volume. Electrical Code		odes - <u>7th Edition (2020) Florida</u>
Manufacturer's Product	Approvals		
Doors: See Attached	Overhead Doors:	See Attached Wind	lows: See Attached
Mitered Glass: See Attach	ed Roof Coverings: Se	ee Attached Pro	etection of Openings:
Soffit: See Attached	Siding: See Attac	ched Shu	ters: See Attached
Method of Design per	Florida Building Code (FBC) R301:	:	
X Florida Building Cod	e, 7th Ed (2020)	Other:	
Designer's Name:	structural Systems of N. Florida Inc.		
		ood Design Data <u>N/A</u>	Final Floor Elevation See Site Plan ng Value2000 PSF
Floor Design: Live Lo	pad 20 p.s.f	Dead Load Slab on Gra Dead Load TC=20 BC=10 n roof height 15	de p.s.f
Windows +33.5/-44.8			Garage Doors+29.4/-33.3 p.s.f
	ding Design Pressures: HIP ROOF o.s.f Zone 2: +24.9/-61.7 p.s.f Zone	e 3: <u>+24.9/-61.7</u> p.s.f Zone 4	l: <u>33.5/-36.3</u> p.s.f Zone 5: <u>33.5/-44.8</u> p.s.f
Area Tabulation: To	OTAL (Sq. Ft): 2,973		WILL REYES
Living (Sq. Ft.) 2,	96 Garage (Sq. Ft.) 446	 Lanai (Sq. Ft) ₂₁₀	LANT CENSE
Entry (Sq. Ft.) 12	1 Storage (Sq. Ft.)	Other (Sq. Ft.)	No. 88925
designed to comply with loads as amended and e	r knowledge and belief that these plant the structural portion of the Buildin Inforced by the permitting jurisdictio	g Code for wind, flood and g n.	
Signature:		Oate:	- ONAL ENGINE
Designer's Printed Name: This ite	em has been digitally signed by Ra	oul Reves on the date adiac	ent Architect / Engineer Seal

This item has been digitally signed by Raul Reyes on the date adjacent to the seal. Printed copies of this document are not considered signed and sealed and the signature must be validated on any electronic copies.

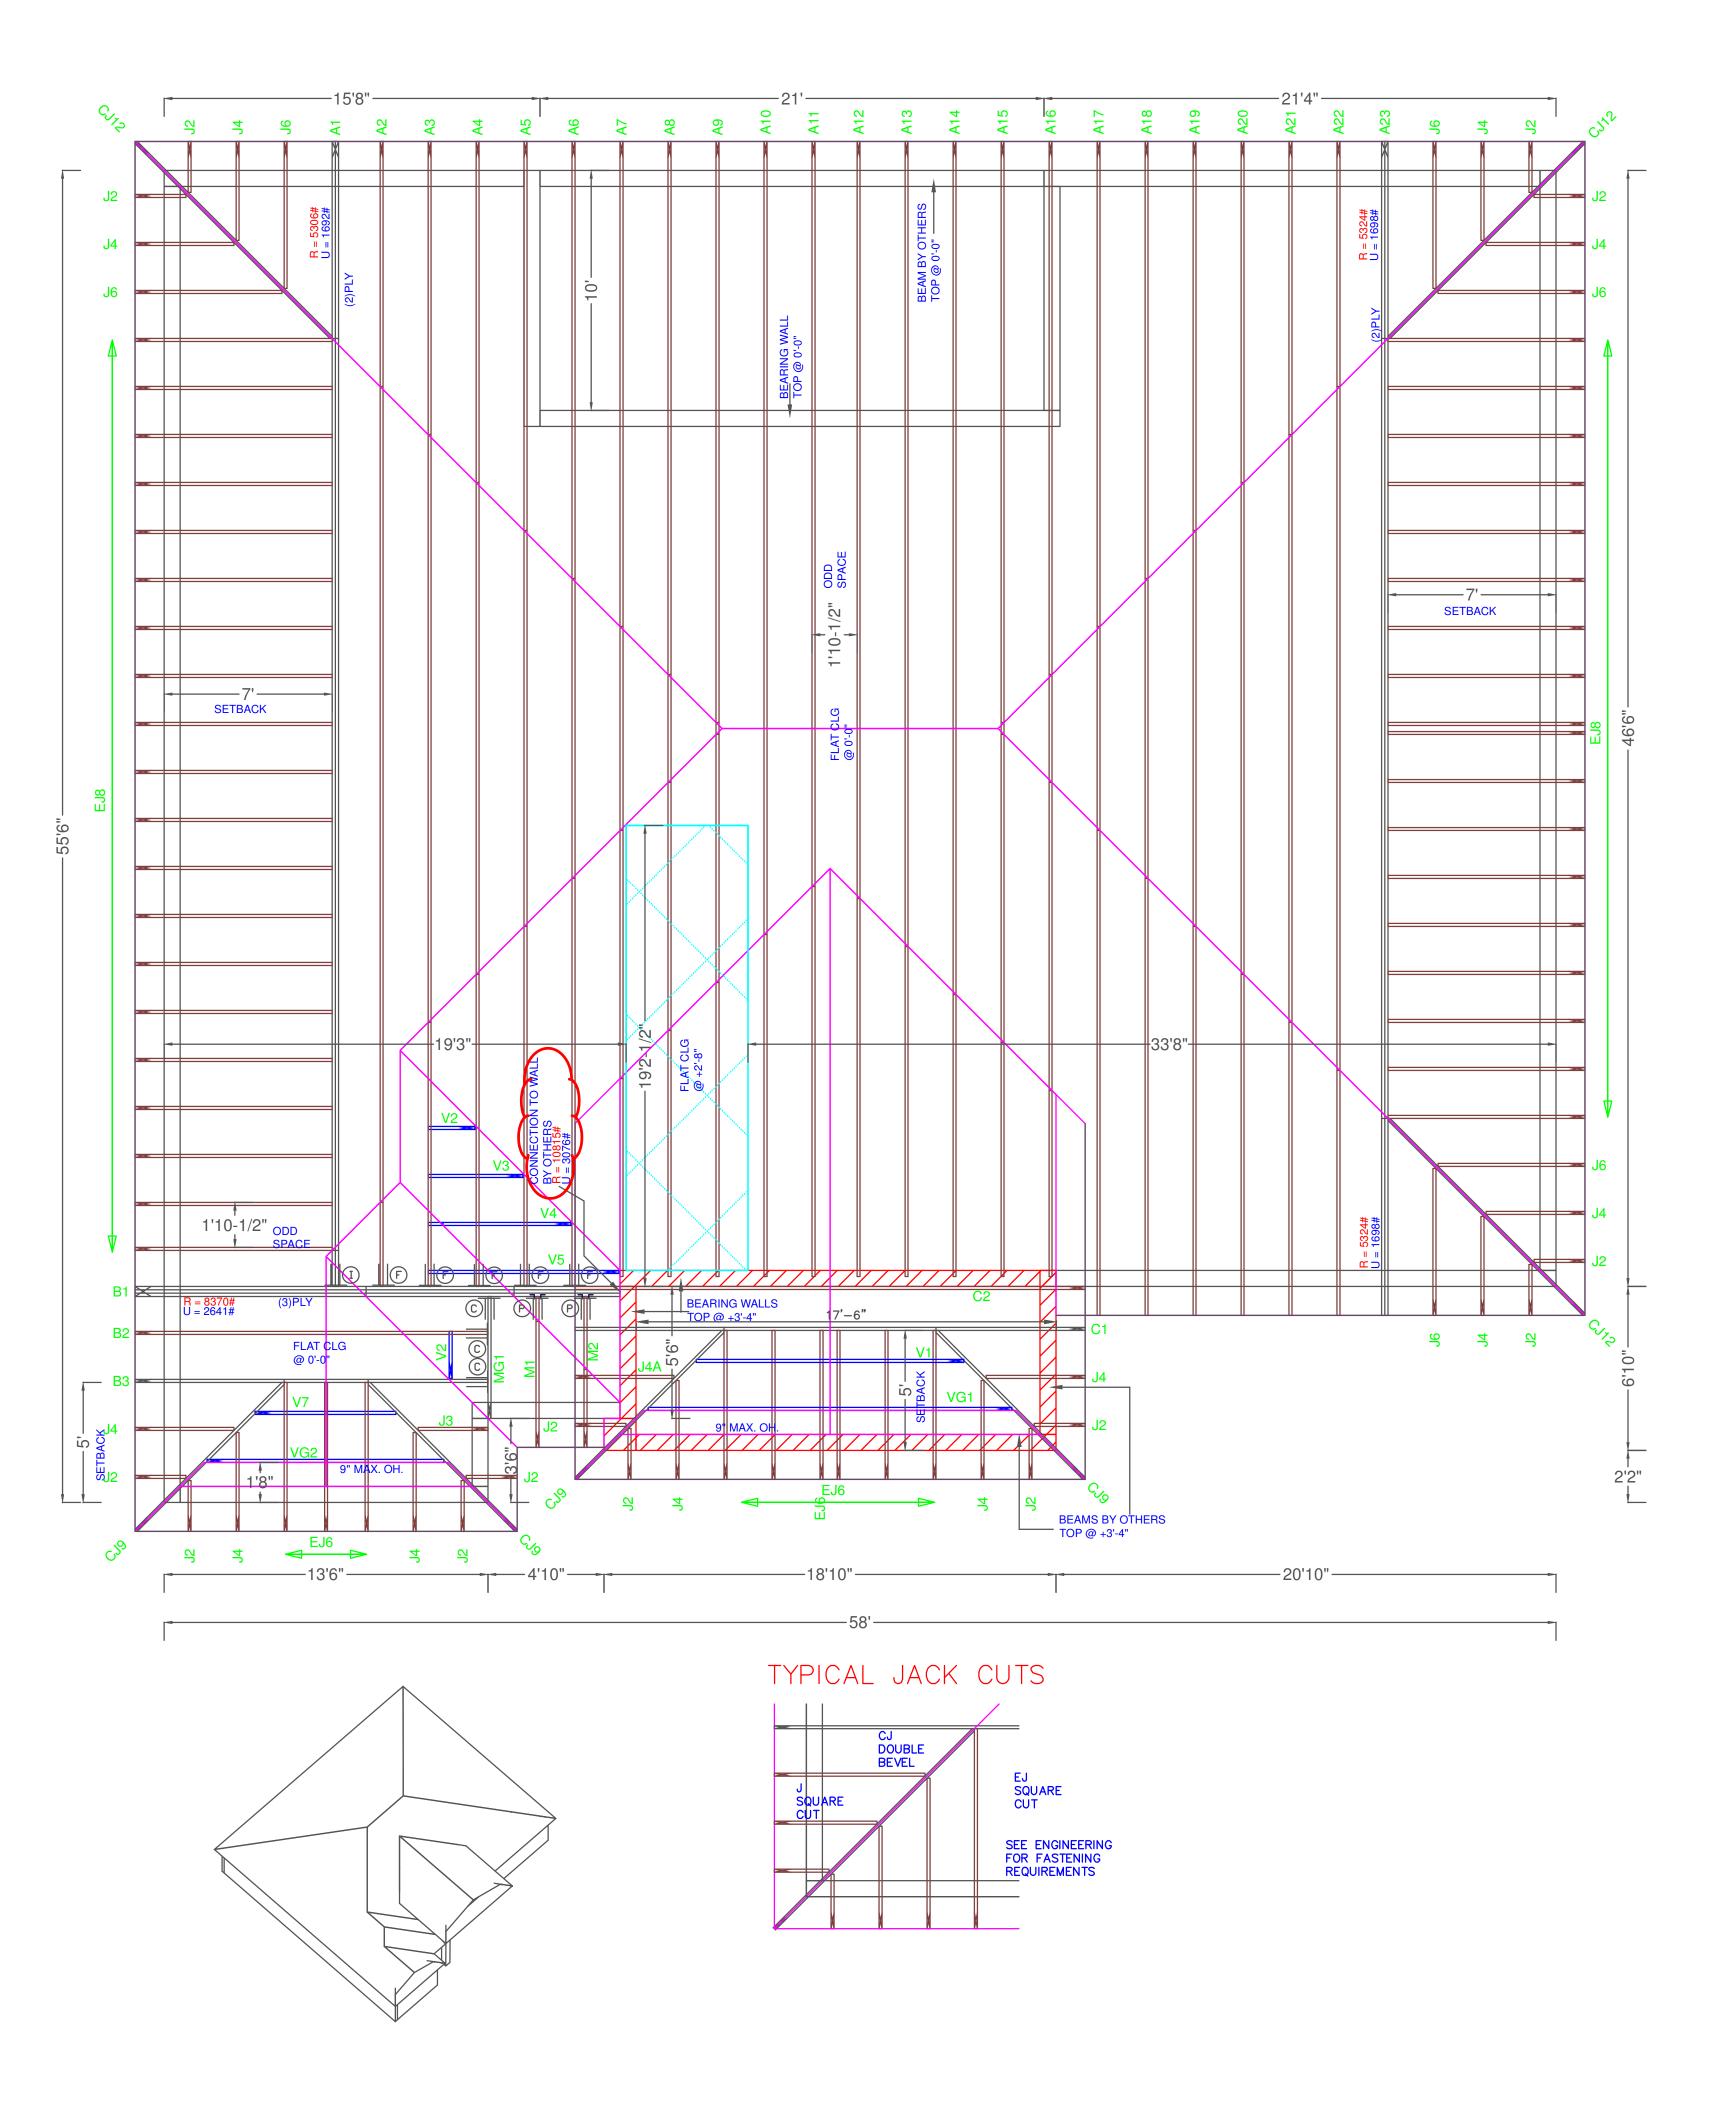

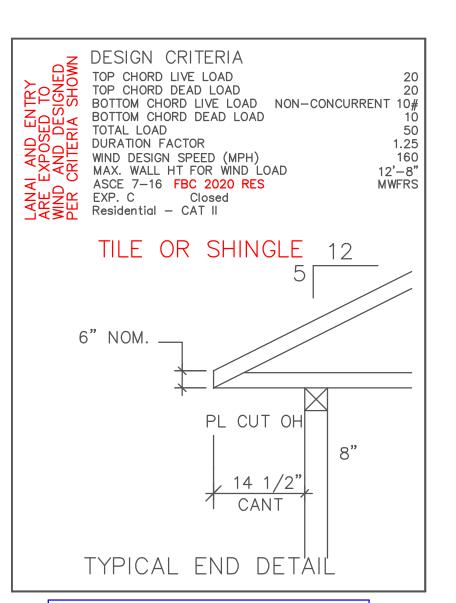

UNLESS NOTED

REACTION VALUES ARE UNDER 5000# UPLIFT VALUES ARE UNDER 1000#

ALL TRUSSES 24"o.c. UNLESS NOTED OTHERWISE *******CAUTION*****

DO NOT ATTEMPT TO ERECT TRUSSES WITH-OUT REFERRING TO THE ENGINEERING DWGS.

IT IS NECESSARY TO REFER TO THE ENGINEERING DRAWINGS FOR NUMBER OF MEMBERS, BEARING LOCATION, ORIENTATION AND WEB BRACING

REFER TO WTCA/TPI BSCI-B1 SUMMARY SHEET FOR HANDLING METHODS & TEMPORARY BRACING, WHICH IS ALWAYS REQUIRED BEARING HEIGHTS BASED ON PLANS PROVIDED TO SCOSTA

CORP. "+/-" BEARING DIFFERENCES SHOWN ARE CRITICAL. IF ANY HEIGHTS DEVIATE - INFORM SCOSTA CORP.

BEARING WALL & BEAM HEIGHTS

9'-4" A.F.F.		_	0'-0"	ELEV.
12'-8" A.F.F.	7//////	Z	+3'-4"	ELEV.
		$\overline{\Sigma}$		ELEV.
		#		ELEV.
	HAMMANA	<u> </u>		ELEV.
	755555555555	X		ELEV.
		<u> </u>		ELEV.
	TYPICAL	HANGER	SCHEDULE	-


- C SIMPSON HUS 26 M SIMPSON HGUS 28-3 (F) SIMPSON HUS 28 (N) SIMPSON HHUS 48 (H) SIMPSON HGUS 28 (P) SIMPSON LUS 24
- I SIMPSON HGUS 28-2 B SIMPSON THA 422 W SIMPSON THJA26 X
- HANGER VALUES HAVE BEEN BASED ON 16D COMMON NAILS EXCEPT THE FOLLOWING LUS24 10D COMMON THJA26 10D x 1-1/2

******ATTENTION*****

APPROVAL OF THIS TRUSS LAYOUT IS NECESSARY BEFORE FABRICATION CAN BEGIN. VERIFY DIMENSIONS, PITCHES, OVERHANGS, ELEVATIONS, CEILING & BEARING CONDITIONS. SCOSTA CORPORATION IS RESPONSIBLE FOR ACCURACY IN ACCORDANCE WITH PLANS AND/OR INFORMATION PROVIDED BY CUSTOMER, WITH ANY DEVIATIONS NOTED HEREIN. CUSTOMER IS RESPONSIBLE TO VERIFY ACCURACY OF INFORMATION AND PLANS PROVIDED TO SCOSTA CORPORATION, AND TO VERIFY CONFORMANCE TO FIELD CONDITIONS, AND/OR OWNER CHANGES. TRUSSES WILL BE BUILT IN ACCORDANCE WITH THE APPROVED LAYOUT.

APPROVED BY: _____ DATE: _____ REQUESTED DELIVERY DATE: ____ JOBSITE CONTACT NAME: _____ PHONE #: _____


SCOSTA CORP

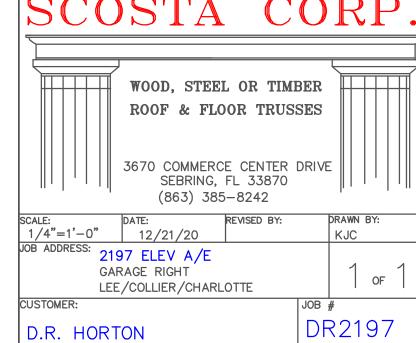

Engineer of Record for the Structure Structural Systems of N. Fl, Inc. Raul Reyes, PE 88925 1634 SE 47th Street #3 Cape Coral, FL 33904

This document has been reviewed for conformance with the design intent of the structure and specified design criteria.

Accepted	Accepted	Revise and
Accepted As-Is	☐ As Noted	L Resubmit

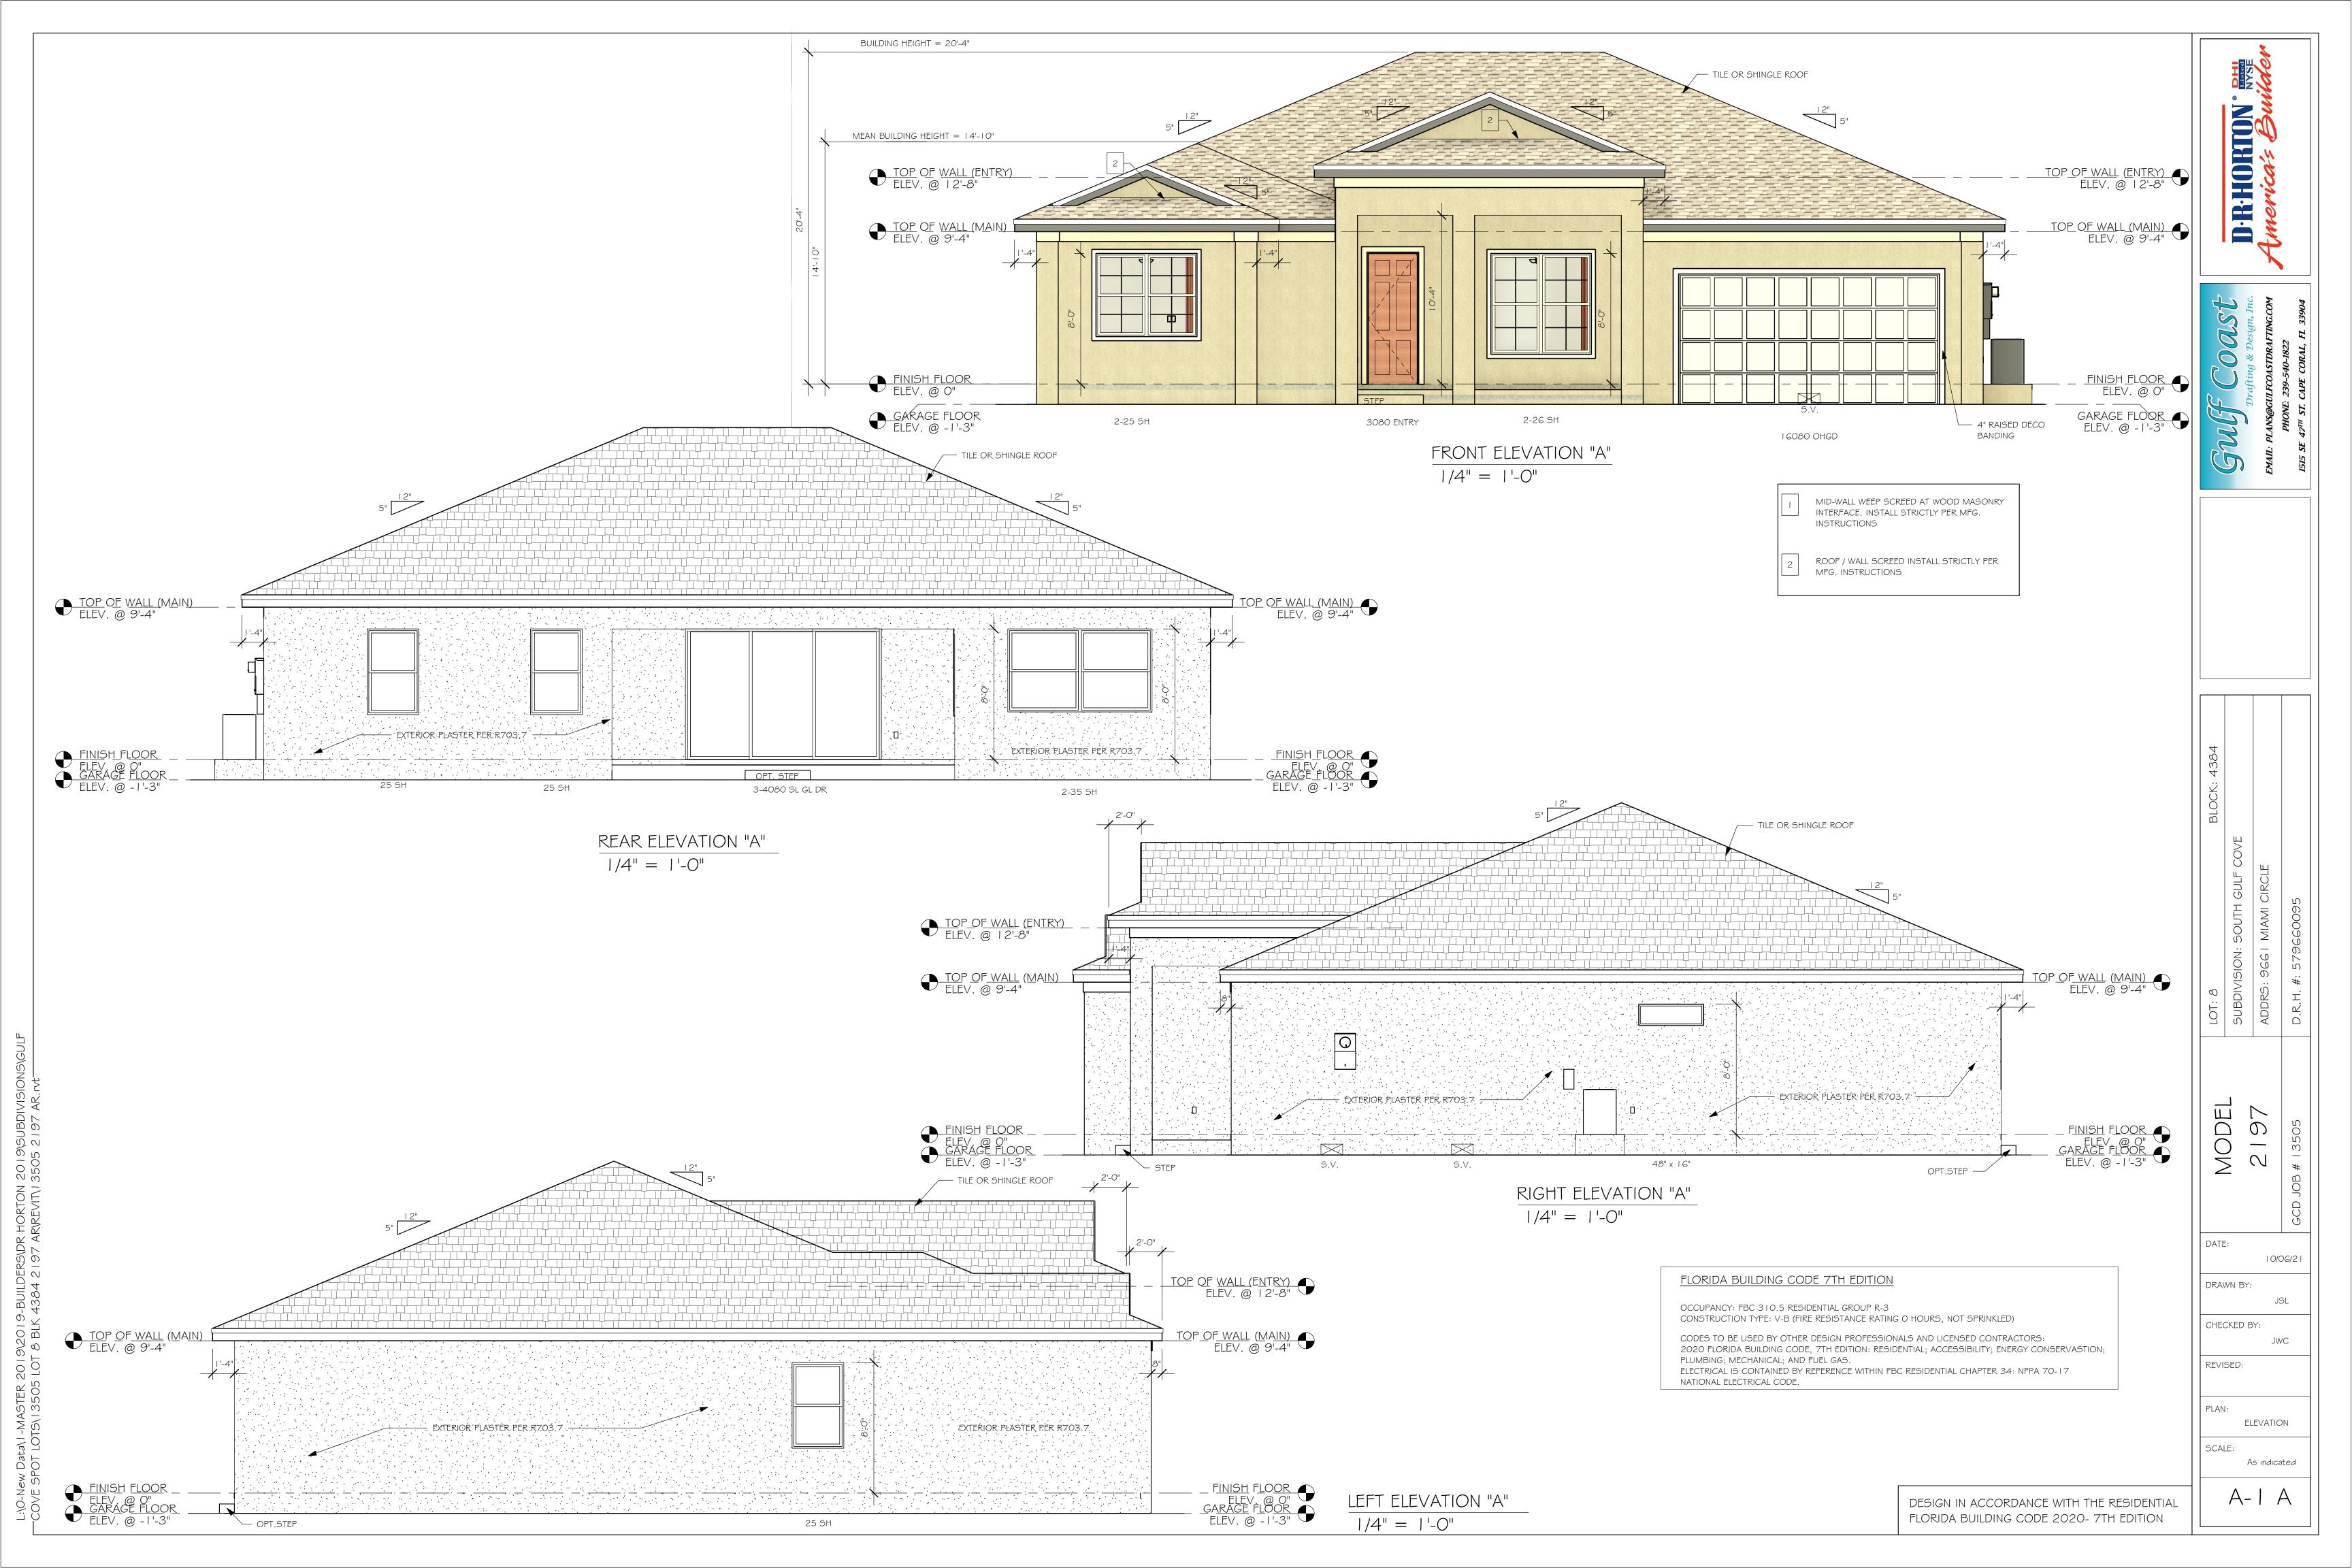


L:\O-New Data\I-MASTER 2019\2019-BUILDERS\DR HORTON 2019\SUBDIVISIONS\GULF COVE SPOT LOTS\13505 LOT 8 BLK 4384 2197 AR\REVIT\13505 2197 AR.rvt

1	16080 OHGD	16'-0"	8'-0"	1
2	3080 ENTRY	3'-0"	8'-0"	1
3	(3)-4080 SL. GL. DR.	12'-0"	8'-0"	Ī

WINDOW	SCHEDU	LE

ı							
	MARK	DESCRIPTION	MANUFACTURER	COMMENTS	HEIGHT	WIDTH	QTY

Α	2-25 SH		5'-3"	6'-4"	1
В	2-26 SH		6'-4"	6'-4"	1
С	48" X 16"	FIXED GLASS	1'-6"	4'-2"	1
D	25 SH		5'-5"	3'-4"	3
E	2-35 SH		5'-3"	9'-0"	1
F	35 SH		5'-5"	4'-8"	1

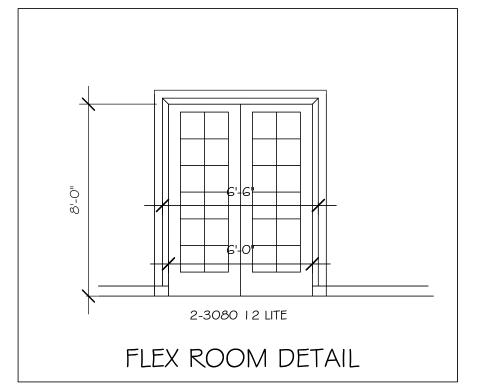

OPT IMPACT GLASS MAY BE INSTALLED IN LIEU OF SHUTTERS VERIFY W/ CONTRACT

ENTRY AREA	121 SF
LANAI AREA	210 SF
GARAGE AREA	446 SF
LIVING AREA	2196 SF
TOTAL AREA	2973 SF

INTERIOR DOOR SCHEDULE				
MARK	DOOR WIDTH	NOTES		
	3'-0"	P.K. = POCKET DOOR		
2	2'-10"	B.F. = BI-FOLD DOOR		
3	2'-8"	D.1 DI-1 OLD DOOK		
4	2'-6"	B.P. = BI-PASS DOOR		
5	2'-4"	L.V. = LOUVERED DOOR		
6	2'-0"			
7	1'-8"			
8	1'-6"			

DOOR HEADERS				
6'-8" BI-FOLD	HEADER HEIGHT	82" A.F.F.		
6'-8" SWING	HEADER HEIGHT	82 I/2" A.F.F.		
8'-0" SWING	HEADER HEIGHT	98 I/2" A.F.F.		

PLAN NOTES

- VERIFY ALL ROUGH OPENING DIMENSIONS FOR
 ALL WINDOWS AND DOORS
- 2) PROVIDE SAFETY GLAZING WITHIN 24" FROM EXIT PER FLORIDA BUILDING CODE R 308.4.2.
- 3) PROVIDE SAFETY GLAZING AT BATH/ SHOWER PER FLORIDA BUILDING CODE R 308.4.5.
- 4) NON BEARING INTERIOR FRAME WALLS SHALL BE FRAMED W/ WOOD OR METAL STUDS. SPACING SHALL NOT EXCEED 24" O.C. (NON BEARING WALLS ONLY)
- 5) PROVIDE DEAD WOOD IN ATTIC FOR OVERHEAD GARAGE DOOR HARDWARE
- 6) KITCHEN KNEE WALL TO BE FRAMED W/ TOP @ 34 1/2" A.F.F.
- 8) WHERE DRYWALL CEILING IS APPLIED TO TRUSSES
 @ 24" O.C. USE 5/8" DRYWALL OR 1/2" SAG

INSTALL SMOOTH WALLS IN KITCHEN AND ALL

- PRESISTANT PER SEC. R702.3.5

 THE GARAGE SHALL BE SEPARATED FROM THE RESIDENCE & ATTIC BY NOT LESS THEN 1/2" GYPSUM BOARD APPLIED TO THE GARAGE SIDE. GARAGES BENEATH HABITABLE ROOMS SHALL BE SEPARATED WITH NOT LESS THAN 5/8" TYPE "X" GYPSUM BOARD OR EQUIVALENT. WHERE THE SEPARATION IS A FLOOR CEILING ASSEMBLY, THE STRUCTURE
- IO) INSTALL I 3/8" THICK SOLID WOOD DOOR BETWEEN LIVING AND GARAGE PER FLORIDA BUILDING CODE

SUPPORTING THE SEPARTION SHALL ALSO BE


PROTECTED BY NOT LESS THAN 1/2" GYPSOM BOARD


11) ALL WINDOWS INSTALLED 72" ABOVE GRADE MUST COMPLY WITH R312.2 MIN 24" SILL HEIGHT OR PROVIDED WITH AN APPROVED WINDOW FALL PREVENTION DEVICE

OR EQUIVALENT

- 12) ALL CLOSET SHELVES TO BE 12". ALL PANTRY \$
 LINEN TO BE (4)-16" SHELVES 18" O.F.F. W/ 15"
 INCREMENT.
- 13) ALL MECHANICAL AND ELECTRICAL EQUIPMENT TO BE INSTALLED AT OR ABOVE FLOOD PLUS 1'-0" FREEBOARD.


CA	BINET BACK	KING
KITCHEN	UPPER TOP @ 84"	BASE TOP @ 35"
MASTER BATH	UPPER	BASE TOP @ 35"
GUEST BATH	UPPER	BASE TOP @ 31"
LAUNDRY ROOM	UPPER TOP @ 84"	BASE

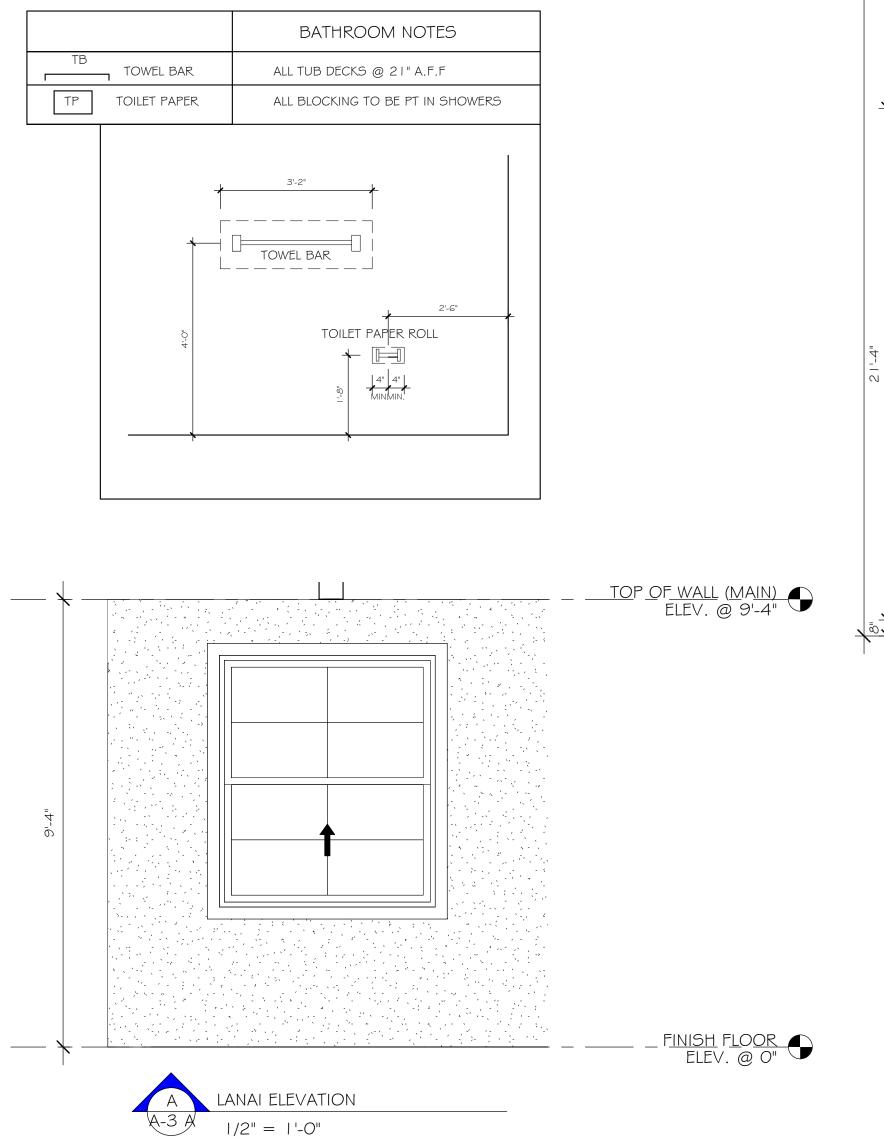

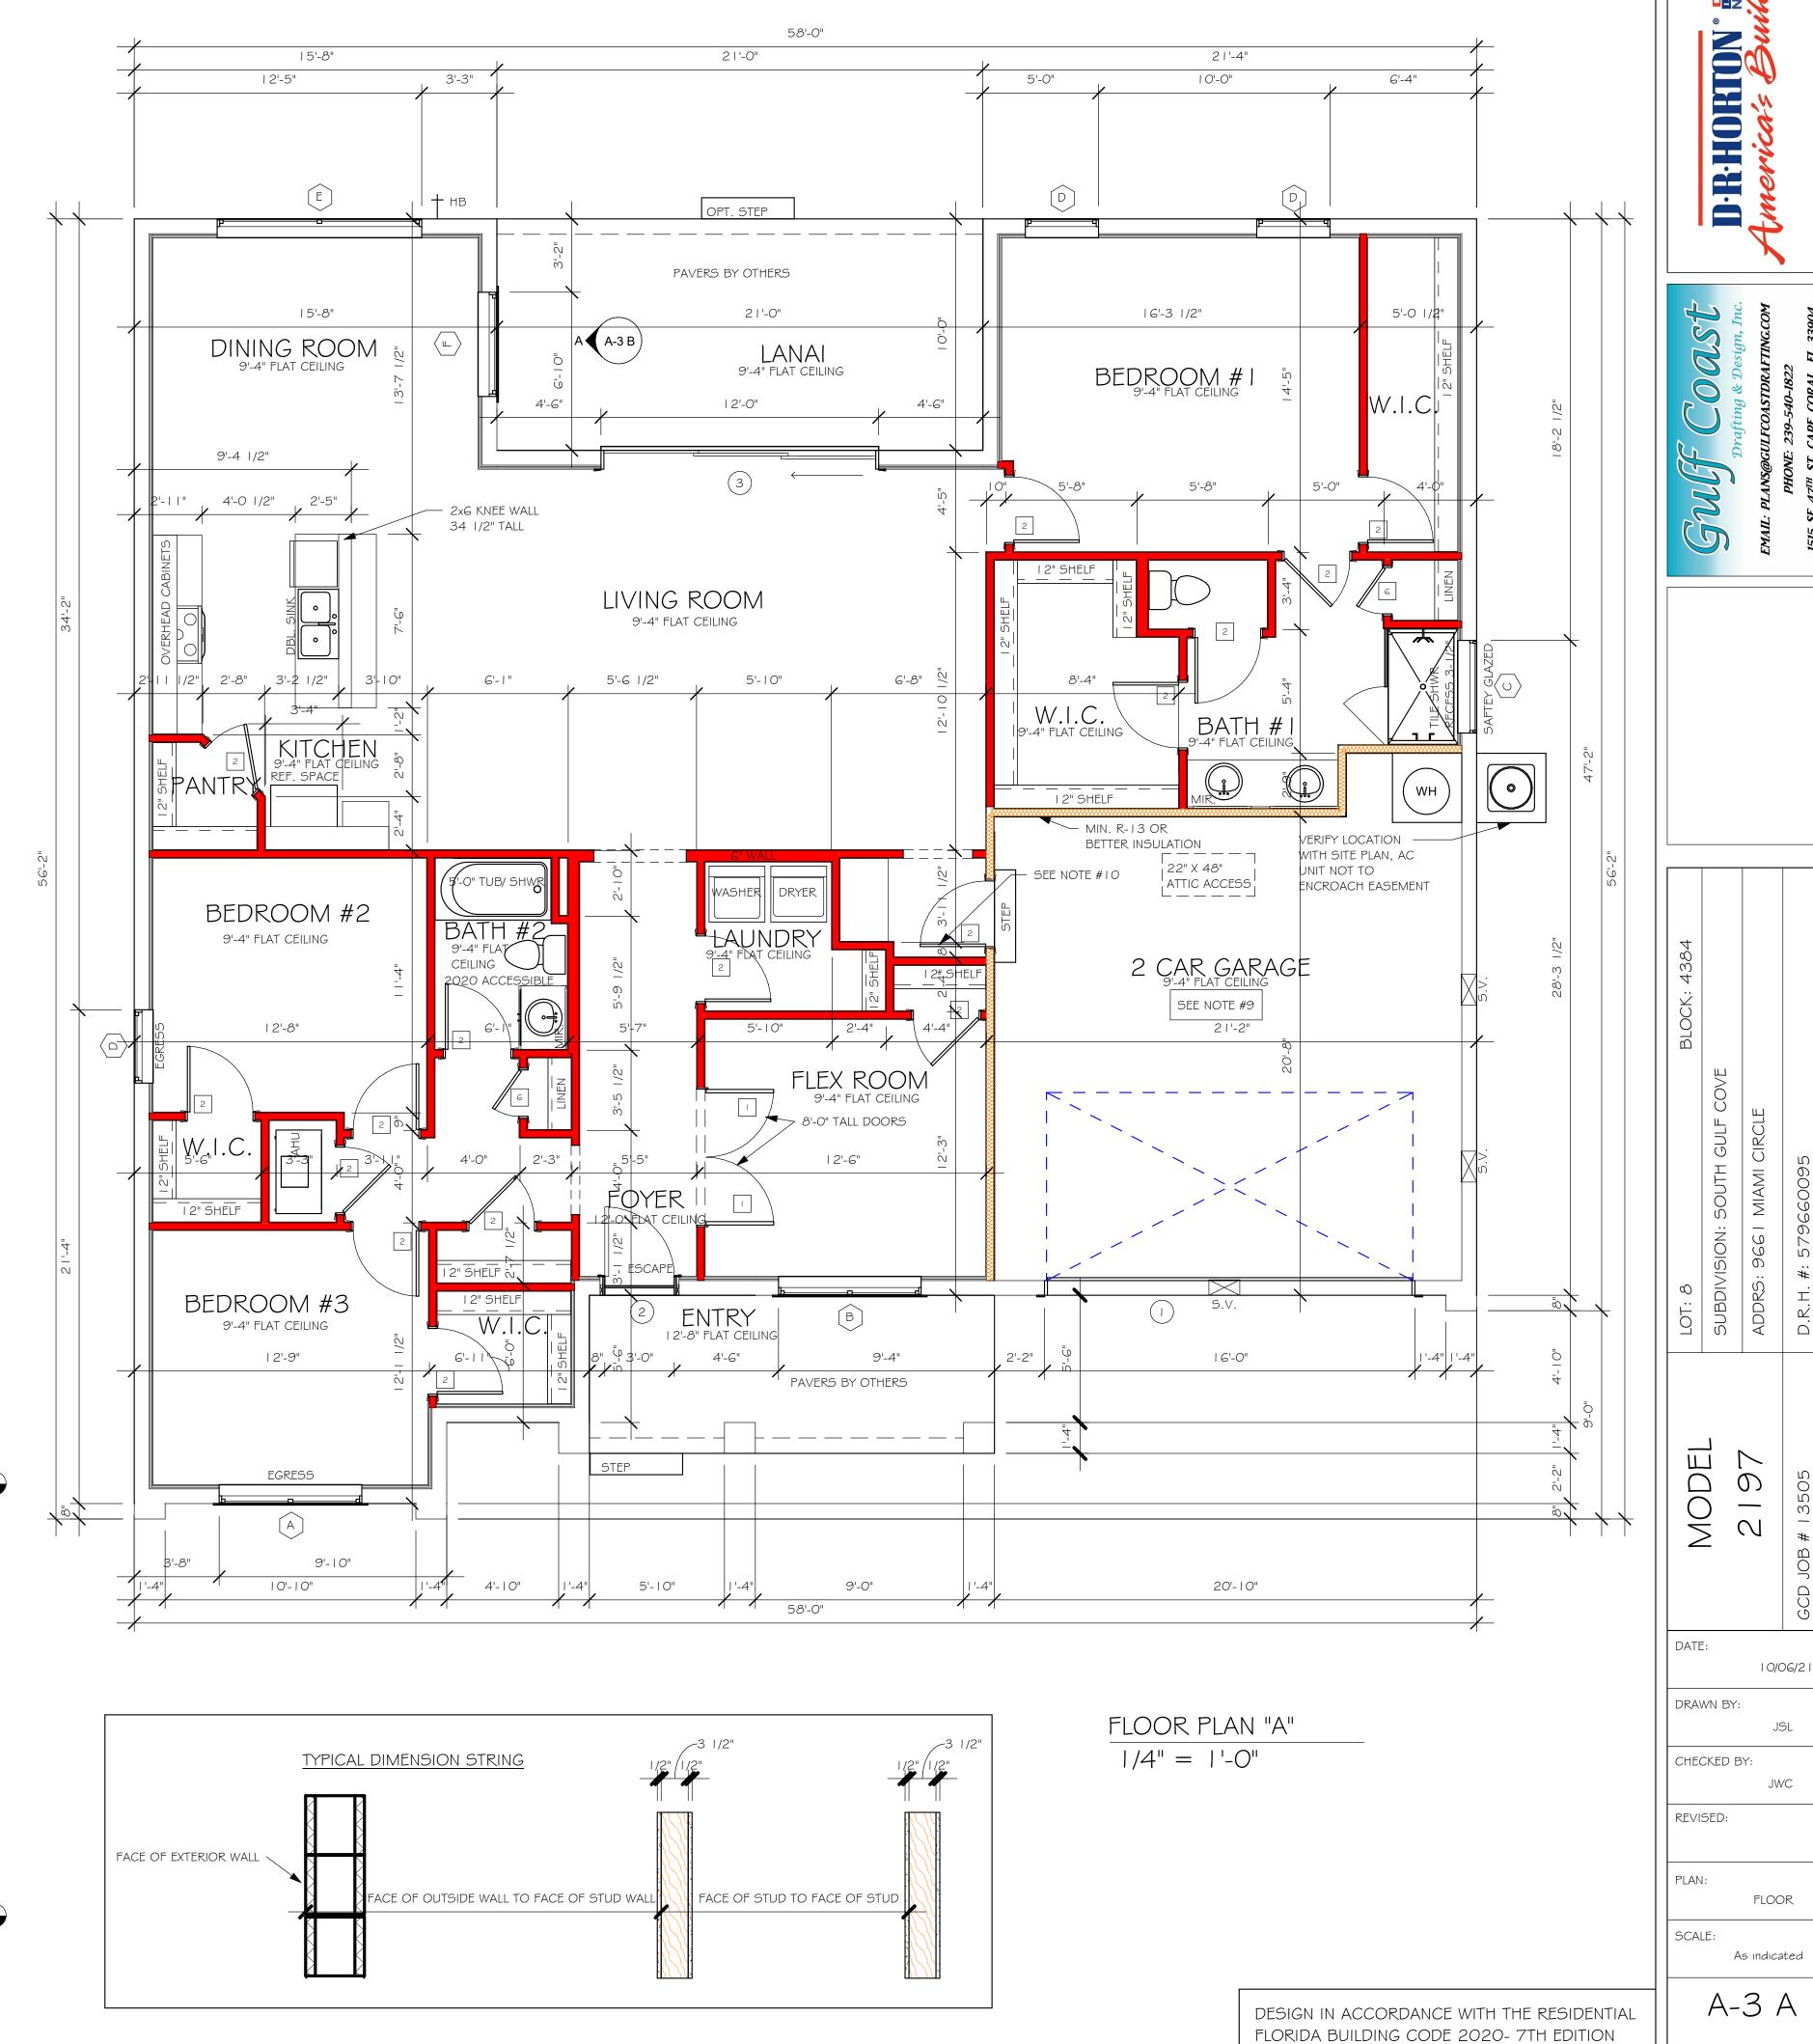

L:\O-New Data\I-MASTER 2019\2019-BUILDERS\DR HORTON 2019\SUBDIVISIONS\GULF -COVE SPOT LOTS\13505 LOT 8 BLK 4384 2197 AR\REVIT\13505 2197 AR.rvt 0.97 SQ. FT. FREE AIR

WALL HEIGHT = MAIN WALL @ 9'-4" = ENTRY WALL @ 12'-8"

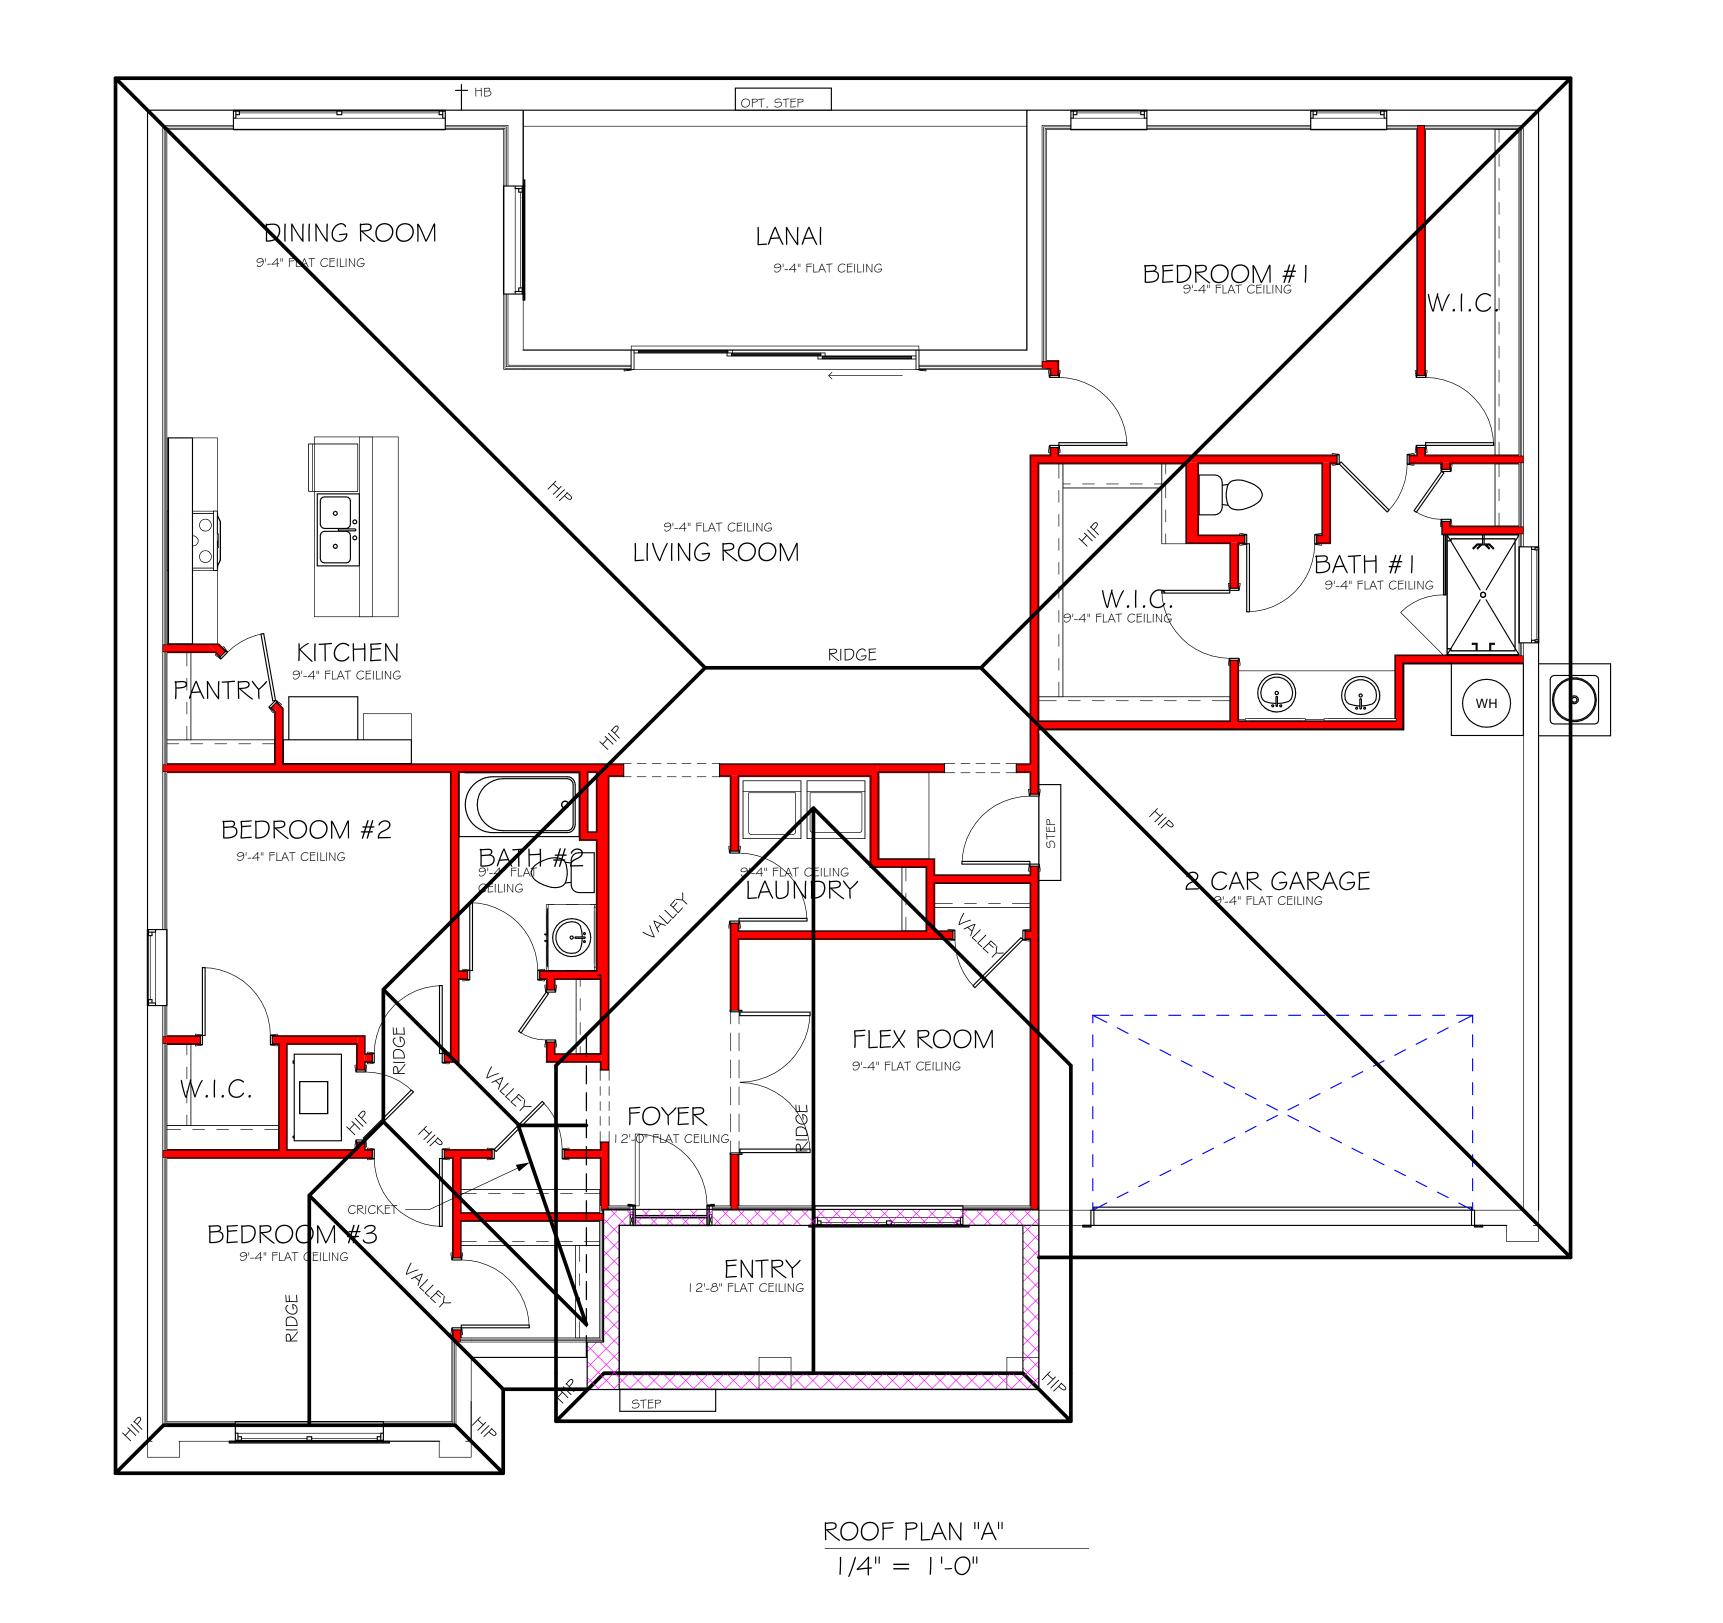

FLORIDA BUILDING CODE 2020- 7TH EDITION

DESIGN IN ACCORDANCE WITH THE RESIDENTIAL

MODEL

DATE:

DRAWN BY:

CHECKED BY:

REVISED:

PLAN:

SCALE:

10/06/21

JWC

ROOF


As indicated

A-4 A

El	LECTRICAL LEGEND
	ELECTRICAL METER
	ELECTRICAL PANEL
	I 20 V JUNCTION BOX
\bigcirc	SINGLE RECEPTACLE OUTLET
\bigoplus	220 V RECEPTACLE OUTLET
	4-PLEX RECEPTACLE OUTLET
	DUPLEX RECEPTACLE OUTLET
	1/2 SWITCHED DUPLEX OUTLET
AFF	DUPLEX RECEPTACLE AT ELEV. A.F.F.
	DUPLEX RECEPTACLE - ABOVE COUNTER
∨	SINGLE POLE SWITCH
(∕) 3	3 WAY SWITCH
(√) D	DIMMER SWITCH
₩ ^S	MOTION SENSOR SWITCH
Sp Scd	AC/DC SMOKE DETECTOR TO BE INTERCONNECTED ANY RESIDENT HAVING A FOSSIL-BURNING HEATER OR APPLIANCE, A FIREPLACE, OR AN ATTACHED GARAGE SHALL HAVE AN OPERATIONAL CARBON MONOXIDE ALARM INSTALLED WITHIN 10 FEET OF EACH ROOM USED FOR SLEEPING PERPOSES. PER RULE 9B-3.04.72 SD (SMOKE DETECTOR) SCD (CARBON MONOXIDE/ SMOKE DETECTOR)
-T	TELEPHONE OUTLET
-TV	TELEVISION RECEPTION OUTLET
<u></u>	SURFACE MOUNTED CEILING LIGHT
0	FLUSH MOUNTED LIGHT
Ю	WALL MTD. BRACKET LIGHT
46	DUPLEX FLOOD LIGHT
9	EXHAUST FAN
	TRACK MTD. LIGHTS
	A/C DISCONNECT
	PUSH BUTTON (PB) / DOOR BELL (DB)
(10)	INTERCOM
	KEYPAD
	4' FLUORESCENT LIGHT
	2' UNDER COUNTER LIGHT
	OT ALL SYMBOLS ARE USED FOR THIS
PROJECT	
ARC-FAUI RESISTAN IN DWELLI ALL ELECTOR ABOV	AL NOTES: LT CIRCUIT-INTERRUPTERS AND TAMPER IT RECEPTACLES SHALL BE INSTALLED ING UNITS PER N.E.C 210.12 AND 406.11 TRIC, ELECTRICAL EQUIPMENT AND APPLIANCES TO BE SET AT /E BASE FLOOD ELEVATIONS PLUS 1'-0" FREEBOARD. ETS IN WET AREAS AND ALL R OUTLETS TO BE GFIS.


INSTALL PHONE AND T.V PER CONTRACT.

INSTALL ALL ELECTRICAL PER NEC 2017

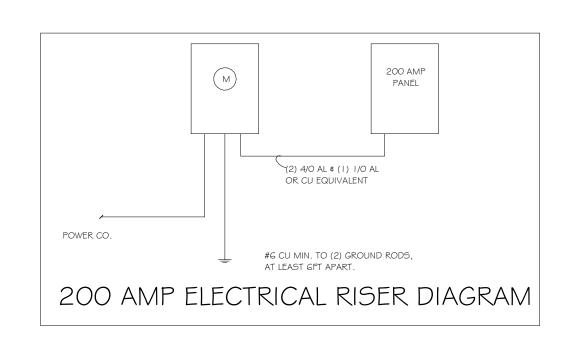

LIGHTING SCHEDULE


200	AMP SERVICE	
TAG	QUANTITY	PRODUCT
Α	(17)	(FLUSH MOUNTED LT)
В	(1)	(VAPORS)
С	(3)	(PENDANT LIGHT
D	(14)	(10" MUSHROOMS)
E	(3)	(24" 3 LT)
F	(X)	(36" 4 LT)
G	(X)	(NOT USED)
Н	(2)	(COACH LIGHTS)
ı	(X)	(COACH LIGHTS)
J	(1)	(J BOX)
K	(X)	(4' FLUORESCENT)
L	(X)	(2' FLUORESCENT)
М	(X)	(5LT CHANDELIER)
Ν	(X)	(3 LT)
0	(X)	(PENDANT/ NOOK)
Р	(X)	(X)
$\overline{\Omega}$	(X)	(X)

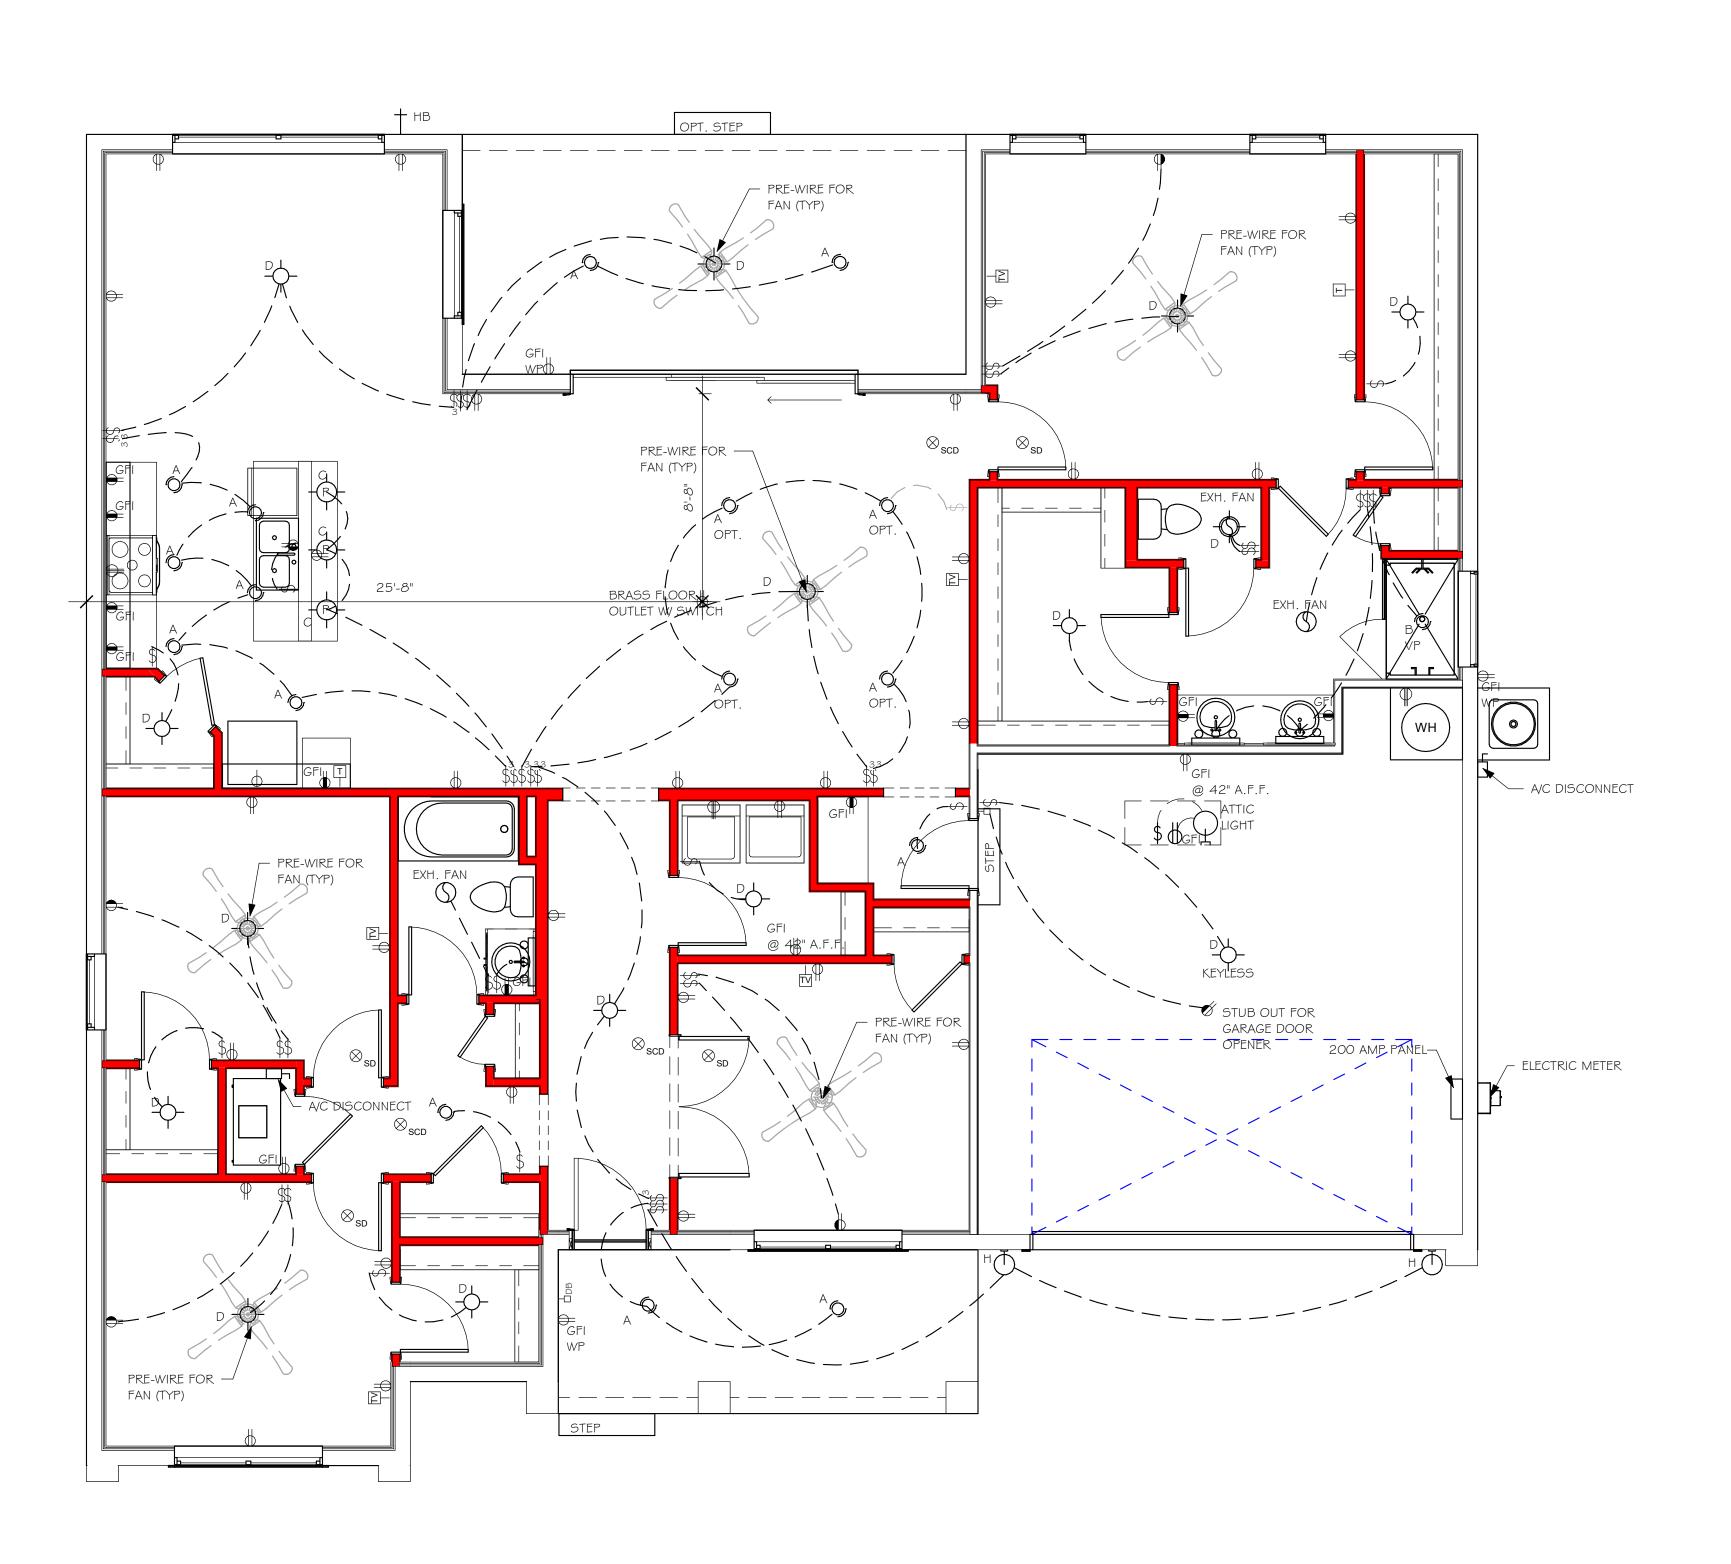

 $\frac{\text{ELECTRICAL PLAN "A"}}{1/4" = 1'-0"}$

MODEL DATE: 10/06/21 DRAWN BY: CHECKED BY: REVISED: ELECTRICAL SCALE: As indicated A-5 A

DESIGN IN ACCORDANCE WITH THE RESIDENTIAL FLORIDA BUILDING CODE 2020- 7TH EDITION

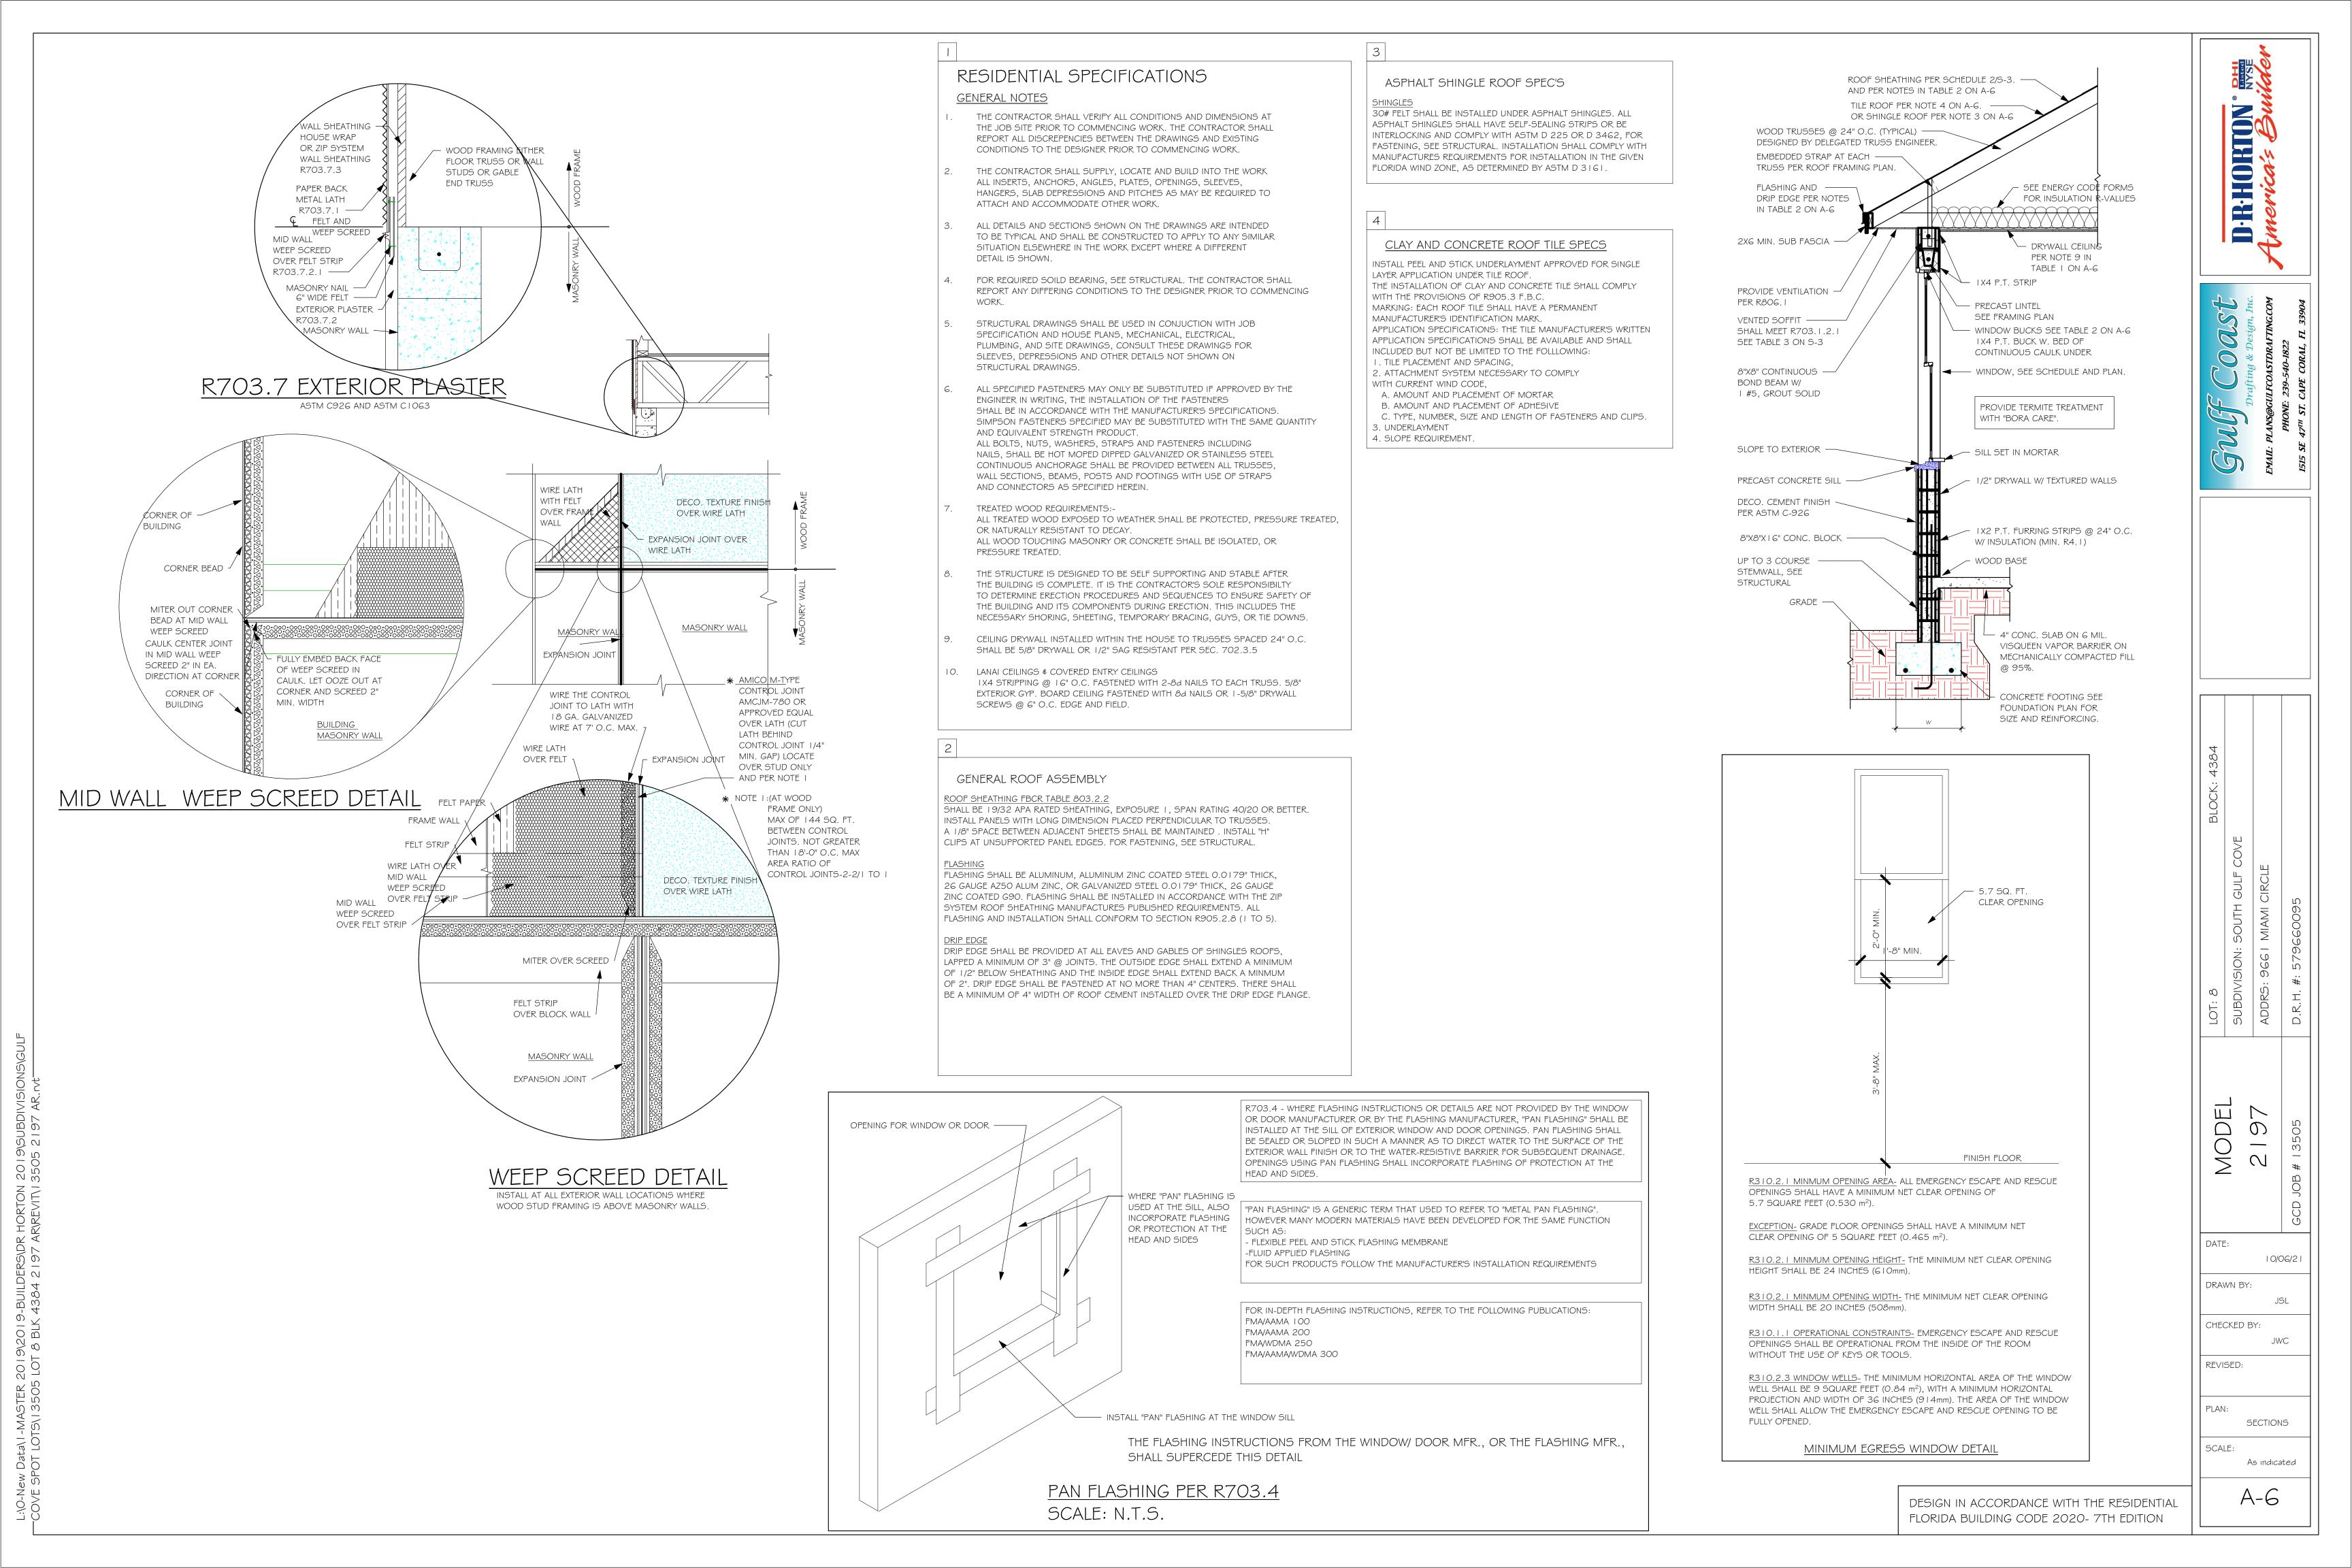

FOUNDATION PLAN

SCALE: 1/4" = 1'-0"

PLAN NOTES:


- 1. TOP OF GROUND FLOOR SLAB DATUM ELEVATION 0'-0"
 2. "F#" DENOTES CONTINUOUS WALL FOOTING TYPE BED SCHEDULE THIS S
- 2. "F#" DENOTES CONTINUOUS WALL FOOTING TYPE PER SCHEDULE THIS SHEET.
- 3. PROVIDE #5 VERTICAL REINFORCING AT DOT LOCATIONS SHOWN ON PLAN FROM FOOTING
- 4. ALL DIMENSIONS ARE TO OUTSIDE FACE OF MASONRY WALLS. SOME SLAB EDGES MAY
- EXTEND BEYOND FACE OF WALL.
- 5. FOR DIMENSIONS OF ROUGH OPENINGS IN MASONRY WALLS, COORDINATE WITH WINDOW/
- 6. PROVIDE PRESSURE TREATED BUCKS AT WINDOWS/ DOORS PER DETAIL 7/S-3.

	PAD FOOTING SCHEDULE							
8	TVDE	LENGTH	WIDTH	DEDTU	вотт	BOTTOM REINF.		
SI	ITPE	LENGIA	חוטוא	DEPIR	LONG WAY	SHORT WAY	REMARKS	
X	$\langle \mathbf{A} \rangle$	2'-6"	2'-6"	1'-0"	3-#5	3-#5	-	
X	(B)	3'-0"	3'-0"	1'-0"	4-#5	4-#5	-	
	(C)	3'-6"	3'-6"	1'-0"	4-#5	4-#5	-	
	(D)	4'-0"	4'-0"	1'-2"	5-#5	5-#5	-	
	(E)	5'-0"	5'-0"	1'-2"	6-#5	6-#5	-	

WALL FOOTING SCHEDULE


USED	TYPE	LENGTH	WIDTH	DEPTH	BOTTOM REINFORCING	SHAPE	
	F1	CONT.	1'-4"	0'-8"	2-#5		
X	F2	CONT.	1'-8"	0'-10"	2-#5		
	F3	CONT.	1'-0"	1'-8"	2-#5	₩	ADD CURB 1 GARAGE, SE DETAIL
	F4	CONT.	1'-4"	1'-8"	2-#5	\vdash	DETAIL
	F5	CONT.	1'-4"	1'-0"	2-#5	-	
	F6	CONT.	1'-4"	1'-0"	2-#5		
	F6A	CONT.	0'-8"	0'-8"	1-#5		
	TE	CONT.	0'-8"	0'-8"	1-#5	F	

PROVIDE CORNER BARS IN FOOTING PER 6/5-3

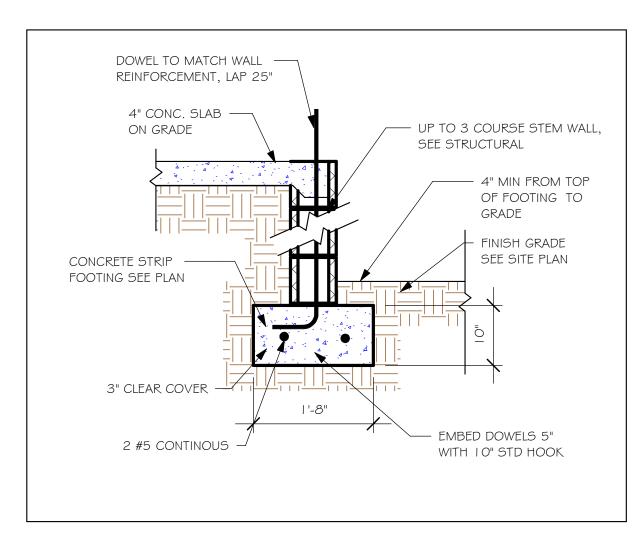


NOTE: REINFORCING IN FOOTINGS SHALL BE CONTINUOUS AT CORNERS AND INTERSECTIONS. ADD CORNER BAR 25" X 25" AT EACH LONGITUDINAL BAR.



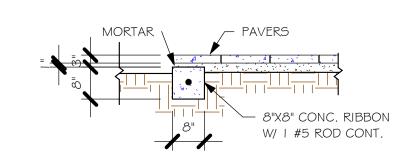



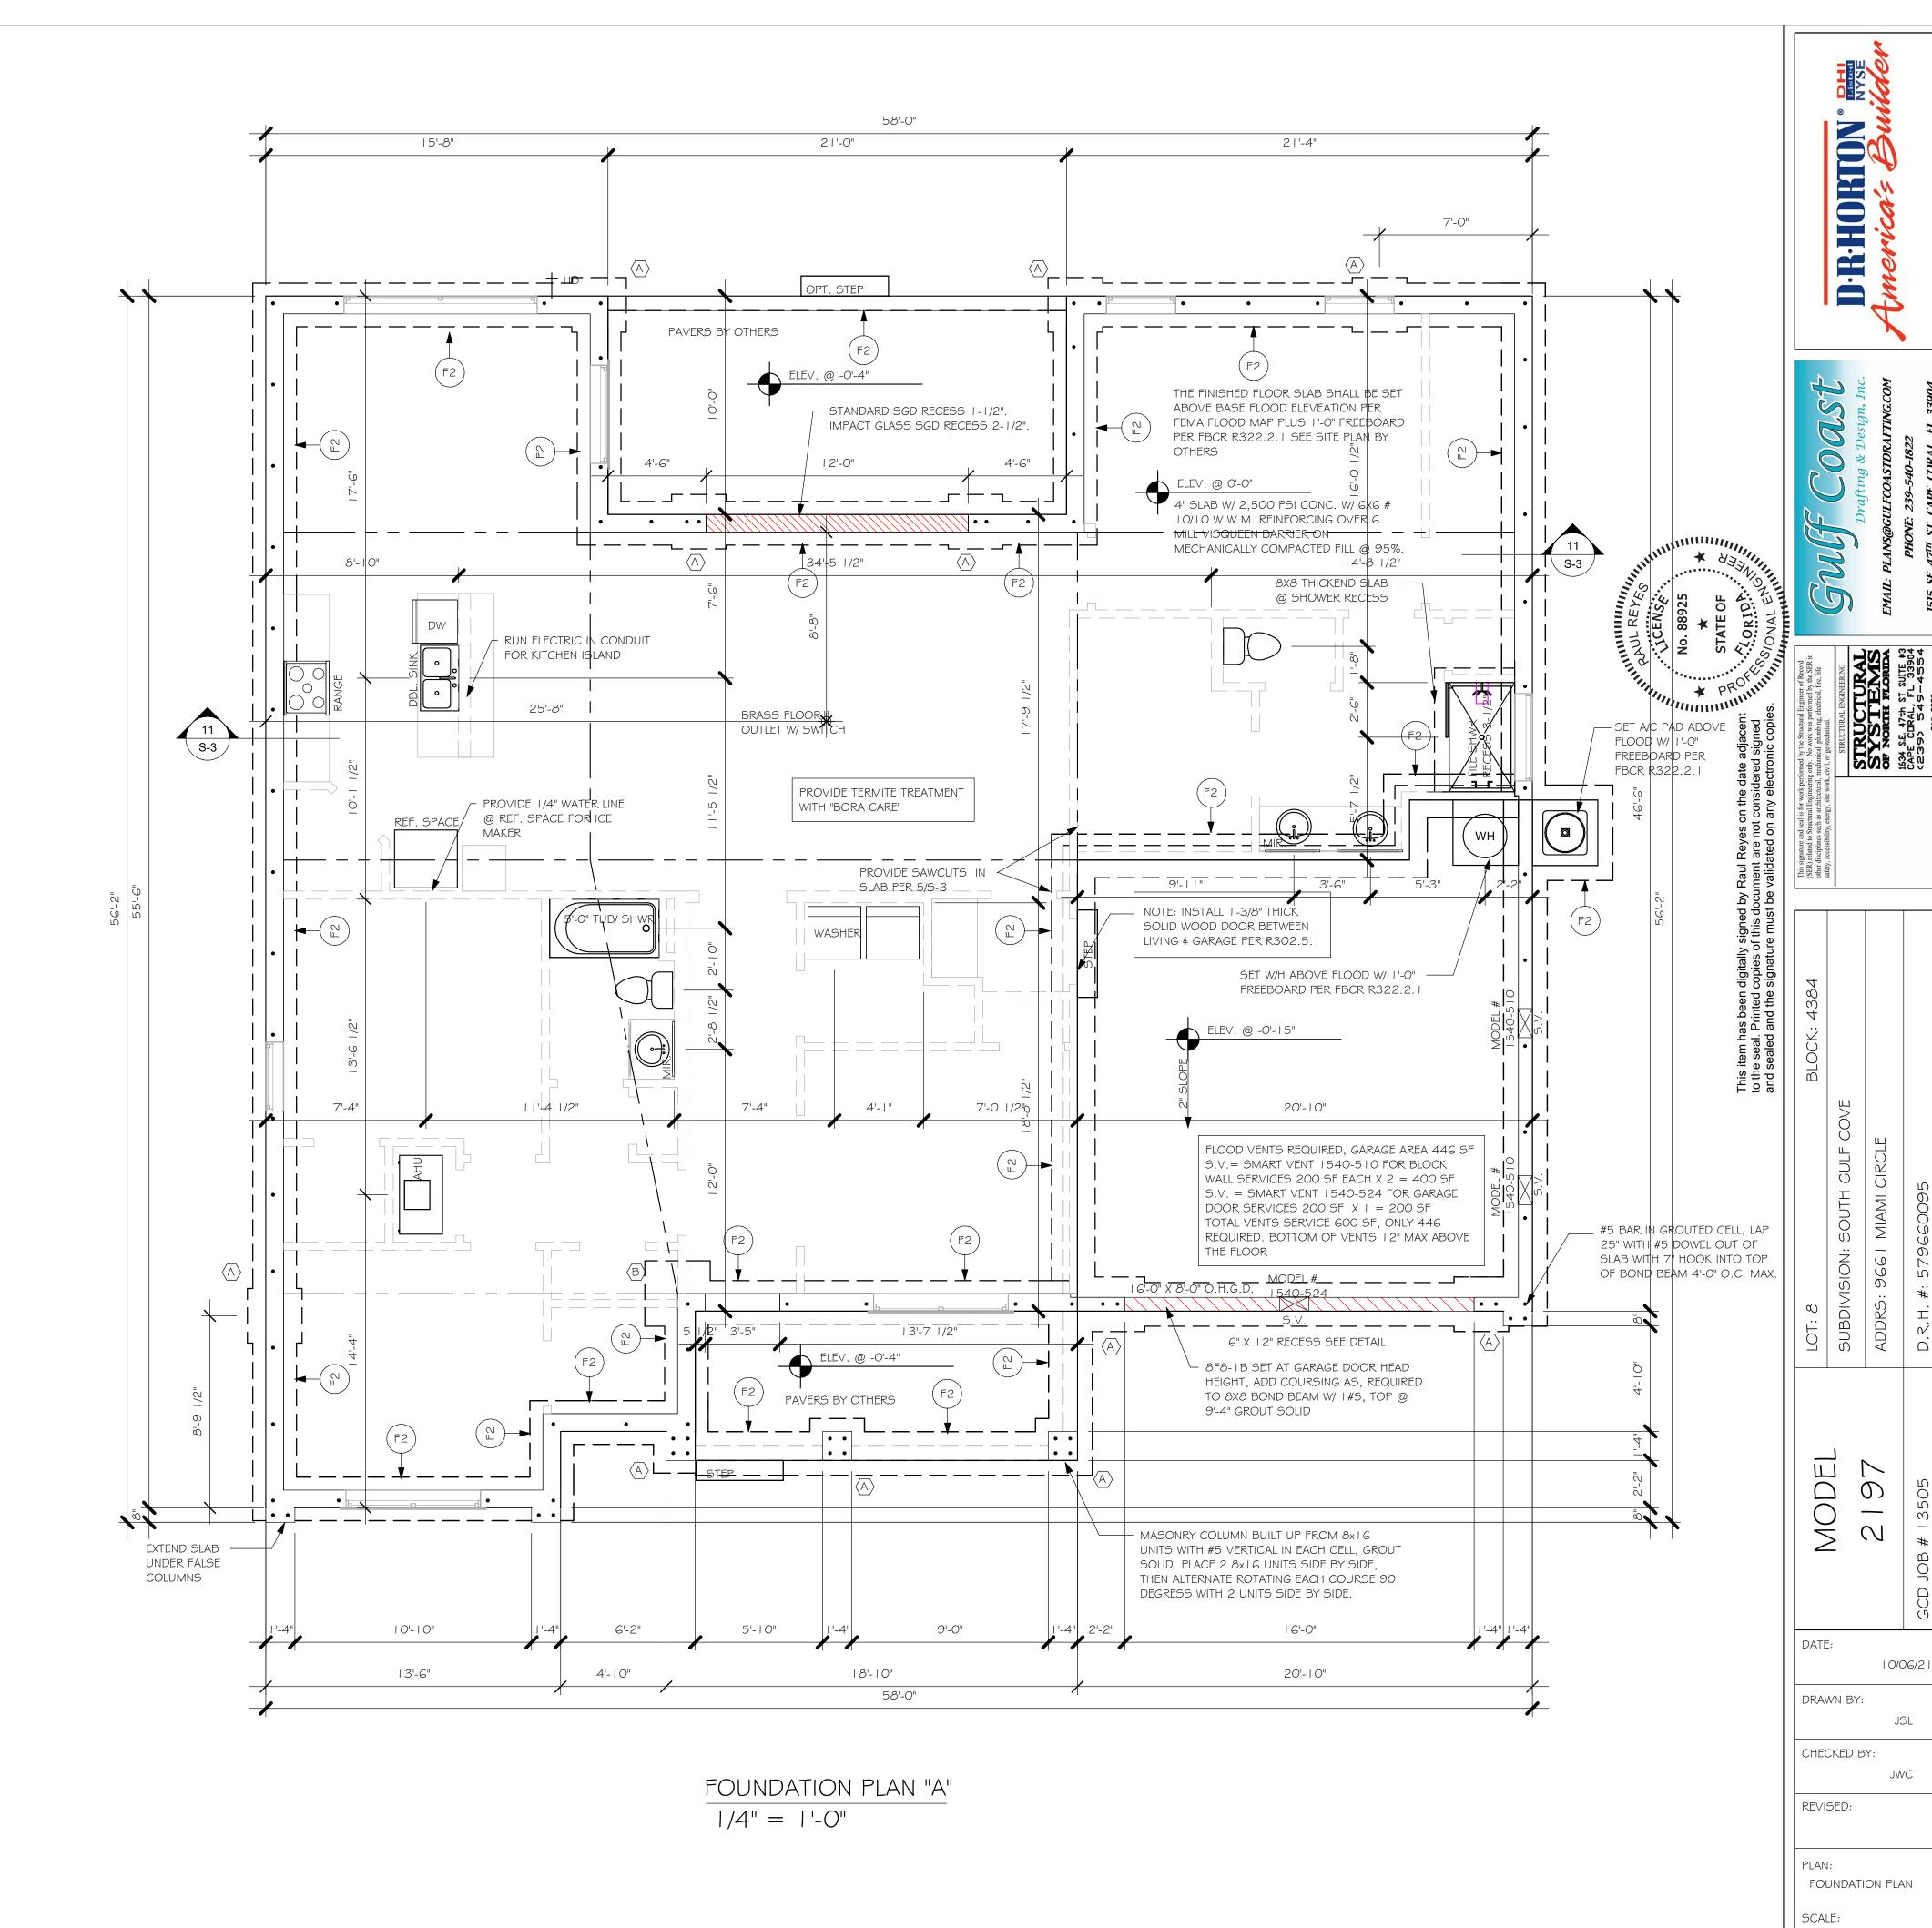

As indicated

DESIGN IN ACCORDANCE WITH THE RESIDENTIAL FLORIDA BUILDING CODE 2020- 7TH EDITION

I. PROVIDE A STRAP FROM THE ABOVE LIST AT EACH ROOF TRUSS BEARING POINT, BASED ON THE TRUSS UPLIFT VALUES IN THE SIGNED AND SEALED TRUSS DESIGN PACKAGE AND SUITABLE FOR THE GEOMETRY. EMBED STRAP ON CENTERLINE OF WALL.

ANY OF THE VALID LENGTHS SHOWN MAY BE USED IN PLACE OF THE LENGTH SPECIFIED ON PLAN. CONNECTORS ARE SIMPSON STRONG TIE. ALL CONNECTORS SHALL BE INSTALLED IN STRICT ACCORDANCE WITH SIMPSON PRINTED INSTUCTIONS. SUBSTITUTIONS MUST BE APPROVED IN

4. WHERE EMBEDDED STRAPS ARE MISSING, OR MIS-LOCATED, INSTALL RETROFIT STRAP PER 10/S-3. PER UPLIFT IN TRUSS ENGINEERING.

SIMPSON CATALOG C-C- 2019

INSTALL AT ALL	TRUSS STRAPPING TO STUDWALL/ WOOD BEAM				
TRUSSES TO 850 Ib UPLIFT.	MAX TRUSS UPLIFT (LBS)	STRAP(S) Valid lengths x/x/x	FASTENER		
FOR HIGHER - UPLIFTS, SEE NOTES ON	►850 1700 2550	(1)MT5 6/20/30 (2) MT5 6/20/30 (3) MT5 6/20/30	(14) 0.148x1-1/2" or 3" EACH STRAP		
PLAN.	1125 2250 3375 4500	(1) HTS20/24/30 (2) HTS20/24/30 (3) HTS20/24/30 (4) HTS20/24/30	(24) 0.148x1-1/2" OR (20) 0.148x3" EACH STRAP		

WRITING BY THE ENGINEER OF RECORD.


I. PROVIDE A STRAP FROM THE ABOVE LIST AT EACH ROOF TRUSS BEARING POINT, BASED ON THE TRUSS UPLIFT VALUES IN THE SIGNED AND SEALED TRUSS DESIGN PACKAGE.


ANY OF THE VALID LENGTHS SHOWN MAY BE USED IN PLACE OF THE LENGTH SPECIFIED ON PLAN.

I-I/2" NAIL SHALL BE USED IN I PLY LUMBER, 2 PLY LUMBER IS REQUIRED FOR 3" NAILS.

CONNECTORS ARE SIMPSON STRONG TIE. ALL CONNECTORS SHALL BE INSTALLED IN STRICT ACCORDANCE WITH SIMPSON PRINTED INSTUCTIONS.


SIMPSON CATALOG C-C- 2019

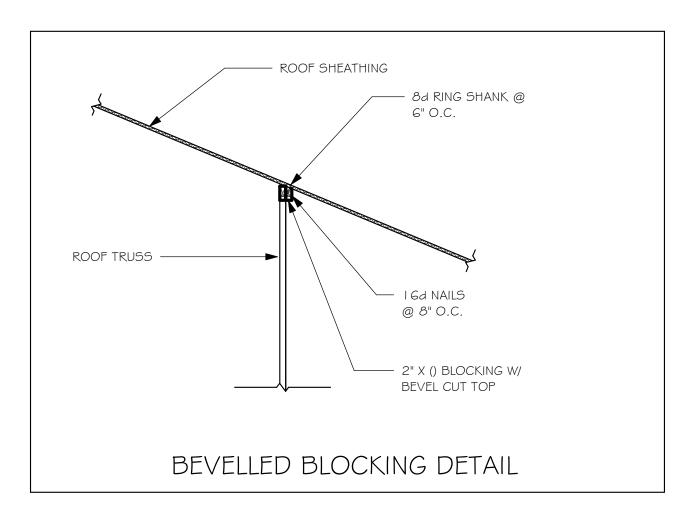


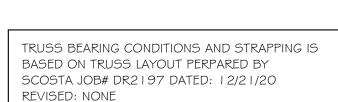



= MAIN WALL @ 9'-4" = ENTRY WALL @ 12'-8"

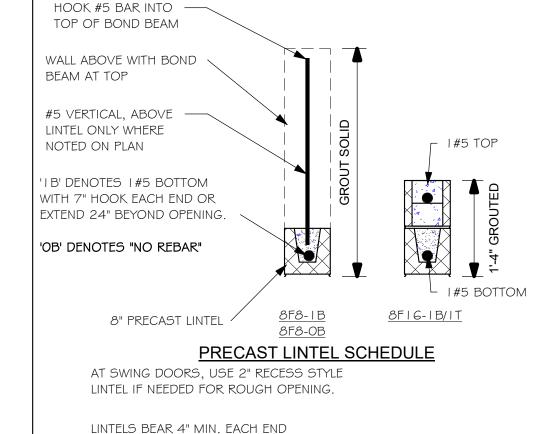

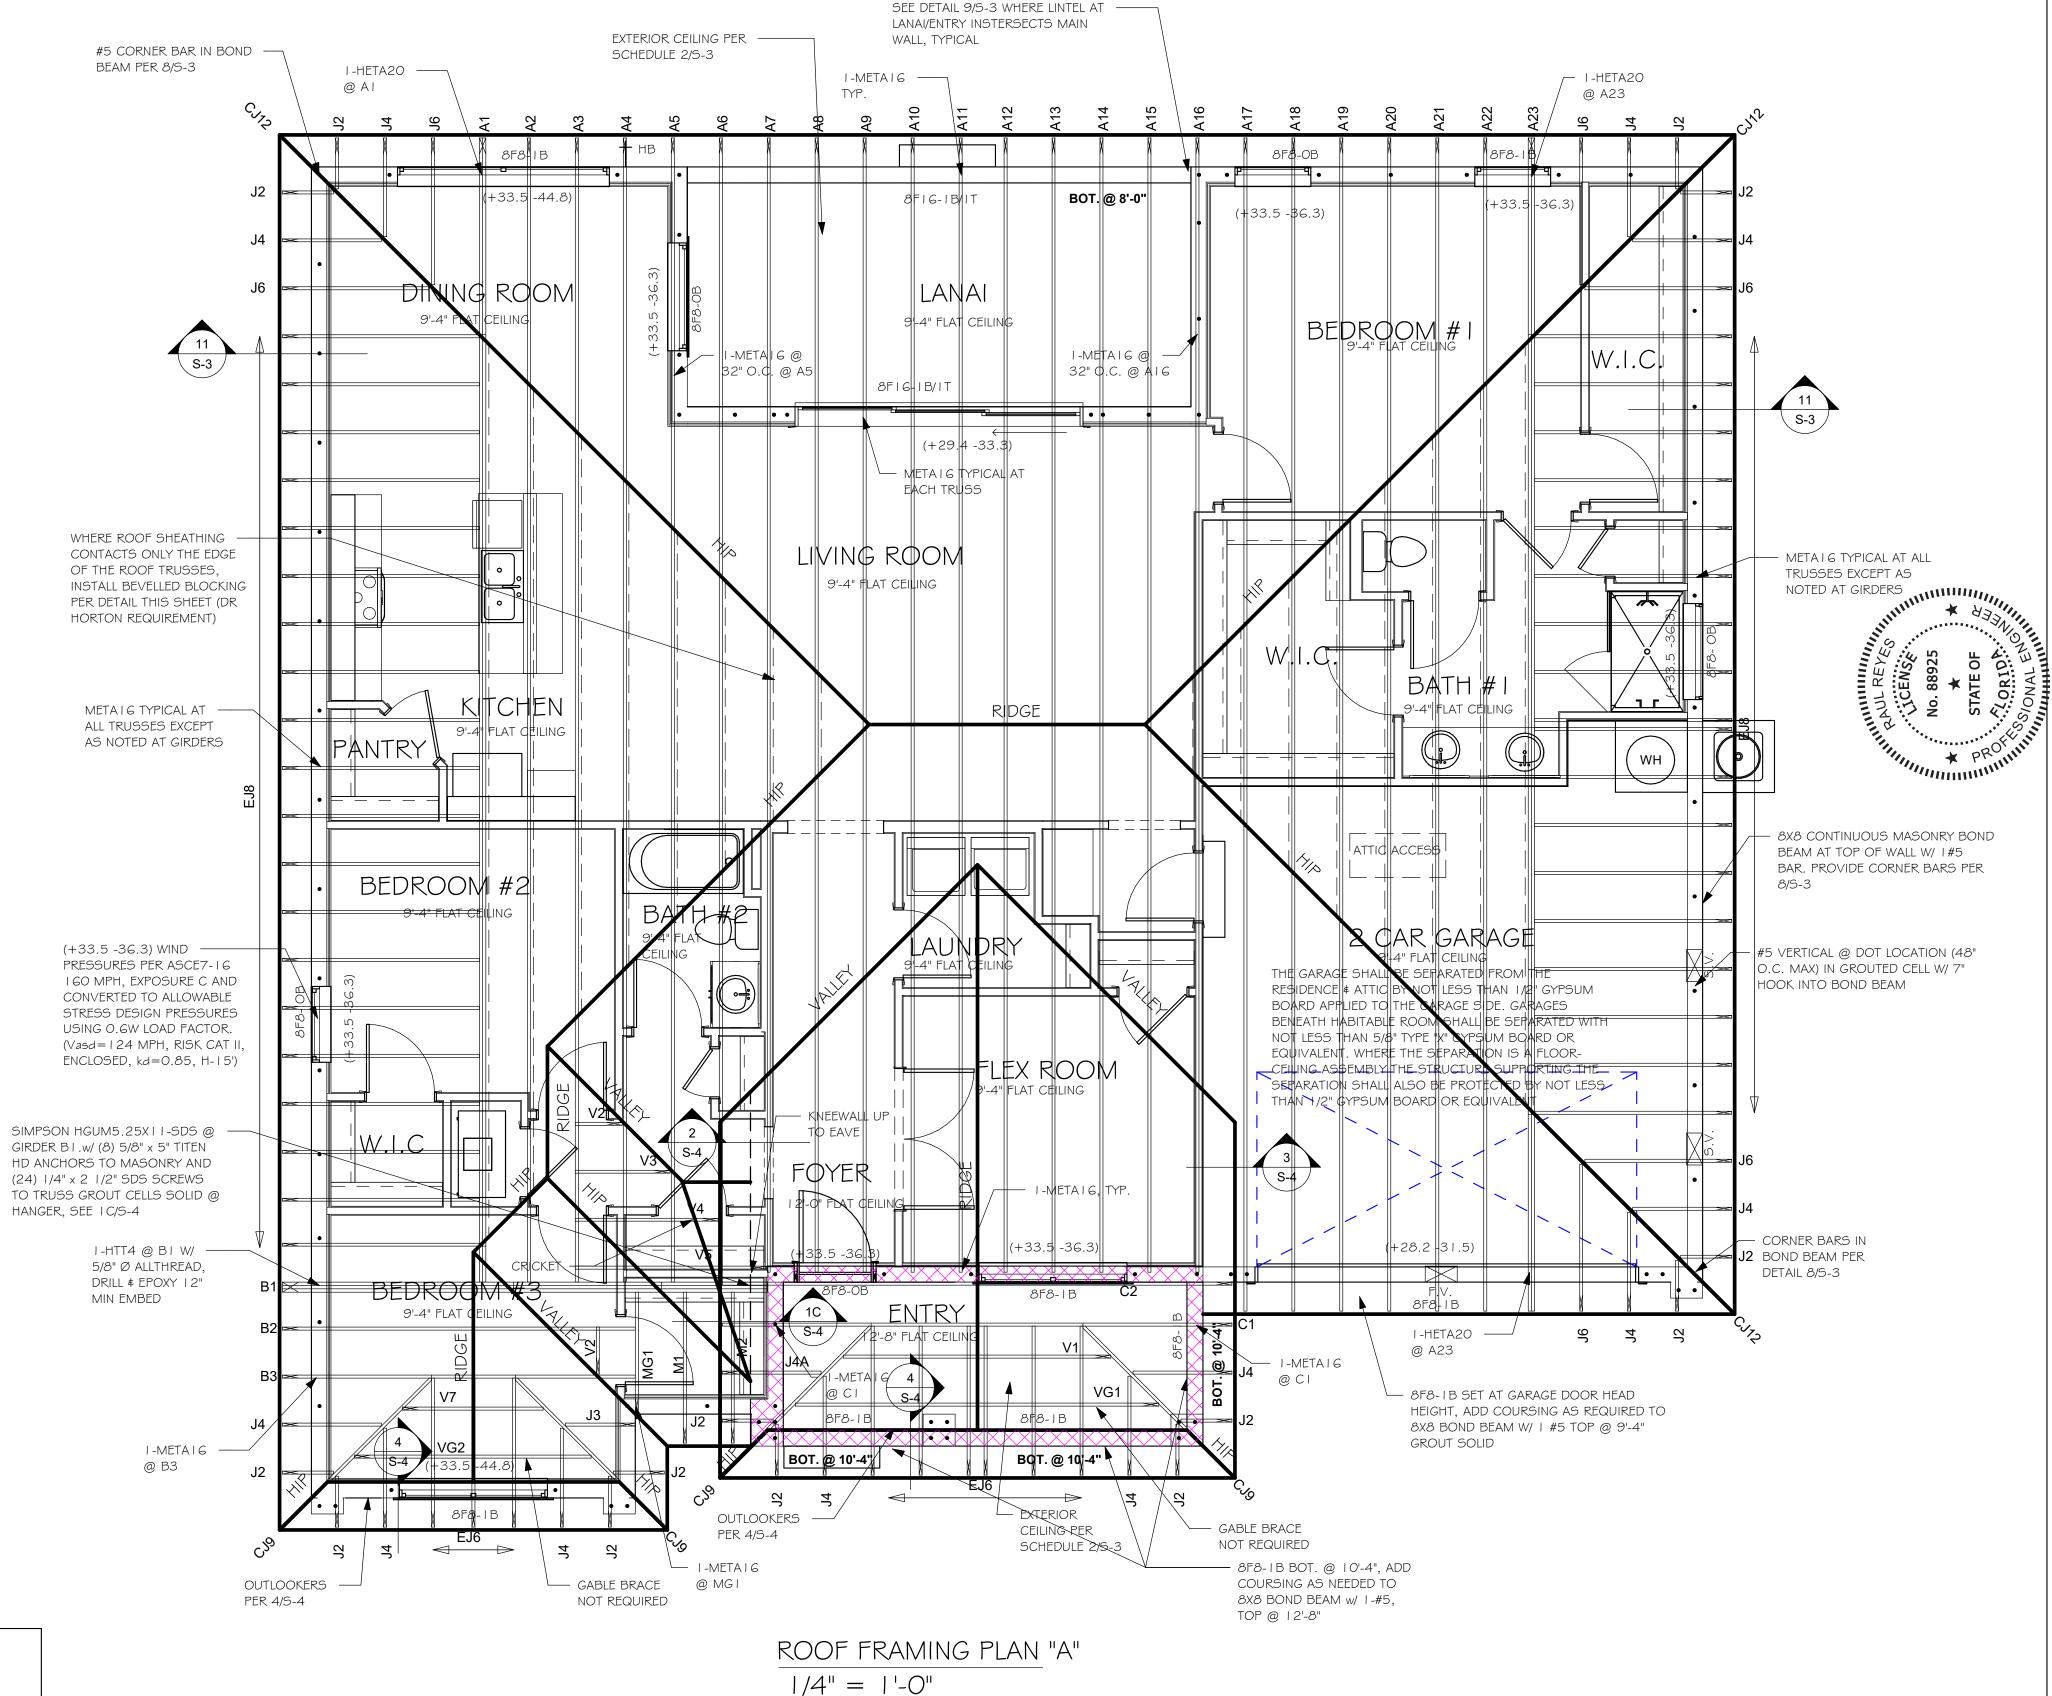

PLAN NOTES:

- ROOF TRUSS BEARING ELEVATION VARIES, SEE LEGEND.
- ROOF FRAMING SHALL BE WOOD TRUSSES DESIGNED BYA DELEGATED TRUSS ENGINEER PER DESIGN
- CRITERIA ON SHEET S-3. PROVIDE STRAPPING AT TRUSSES PER NOTES ON THIS
- FOR NAILING OF ROOF DECK, SEE I AND 2 ON S-3.
- 8F8-1B etc., DENOTES PRECAST LINTEL ABOVE DOORWINDOW OPENING PER SCHEDULE THIS SHEET.
- AT TRUSS BEARING, PROVIDE 8x8 MASONRY BOND BEAM W/ I #5 CONTINUOUS, SEE DETAIL I I/S-3.

DESIGN IN ACCORDANCE WITH THE RESIDENTIAL FLORIDA BUILDING CODE 2020- 7TH EDITION

DRAWN BY: CHECKED BY: JWC REVISED:


10/06/21


山

MODI

DATE:

ROOF FRAMING PLAN SCALE: As indicated

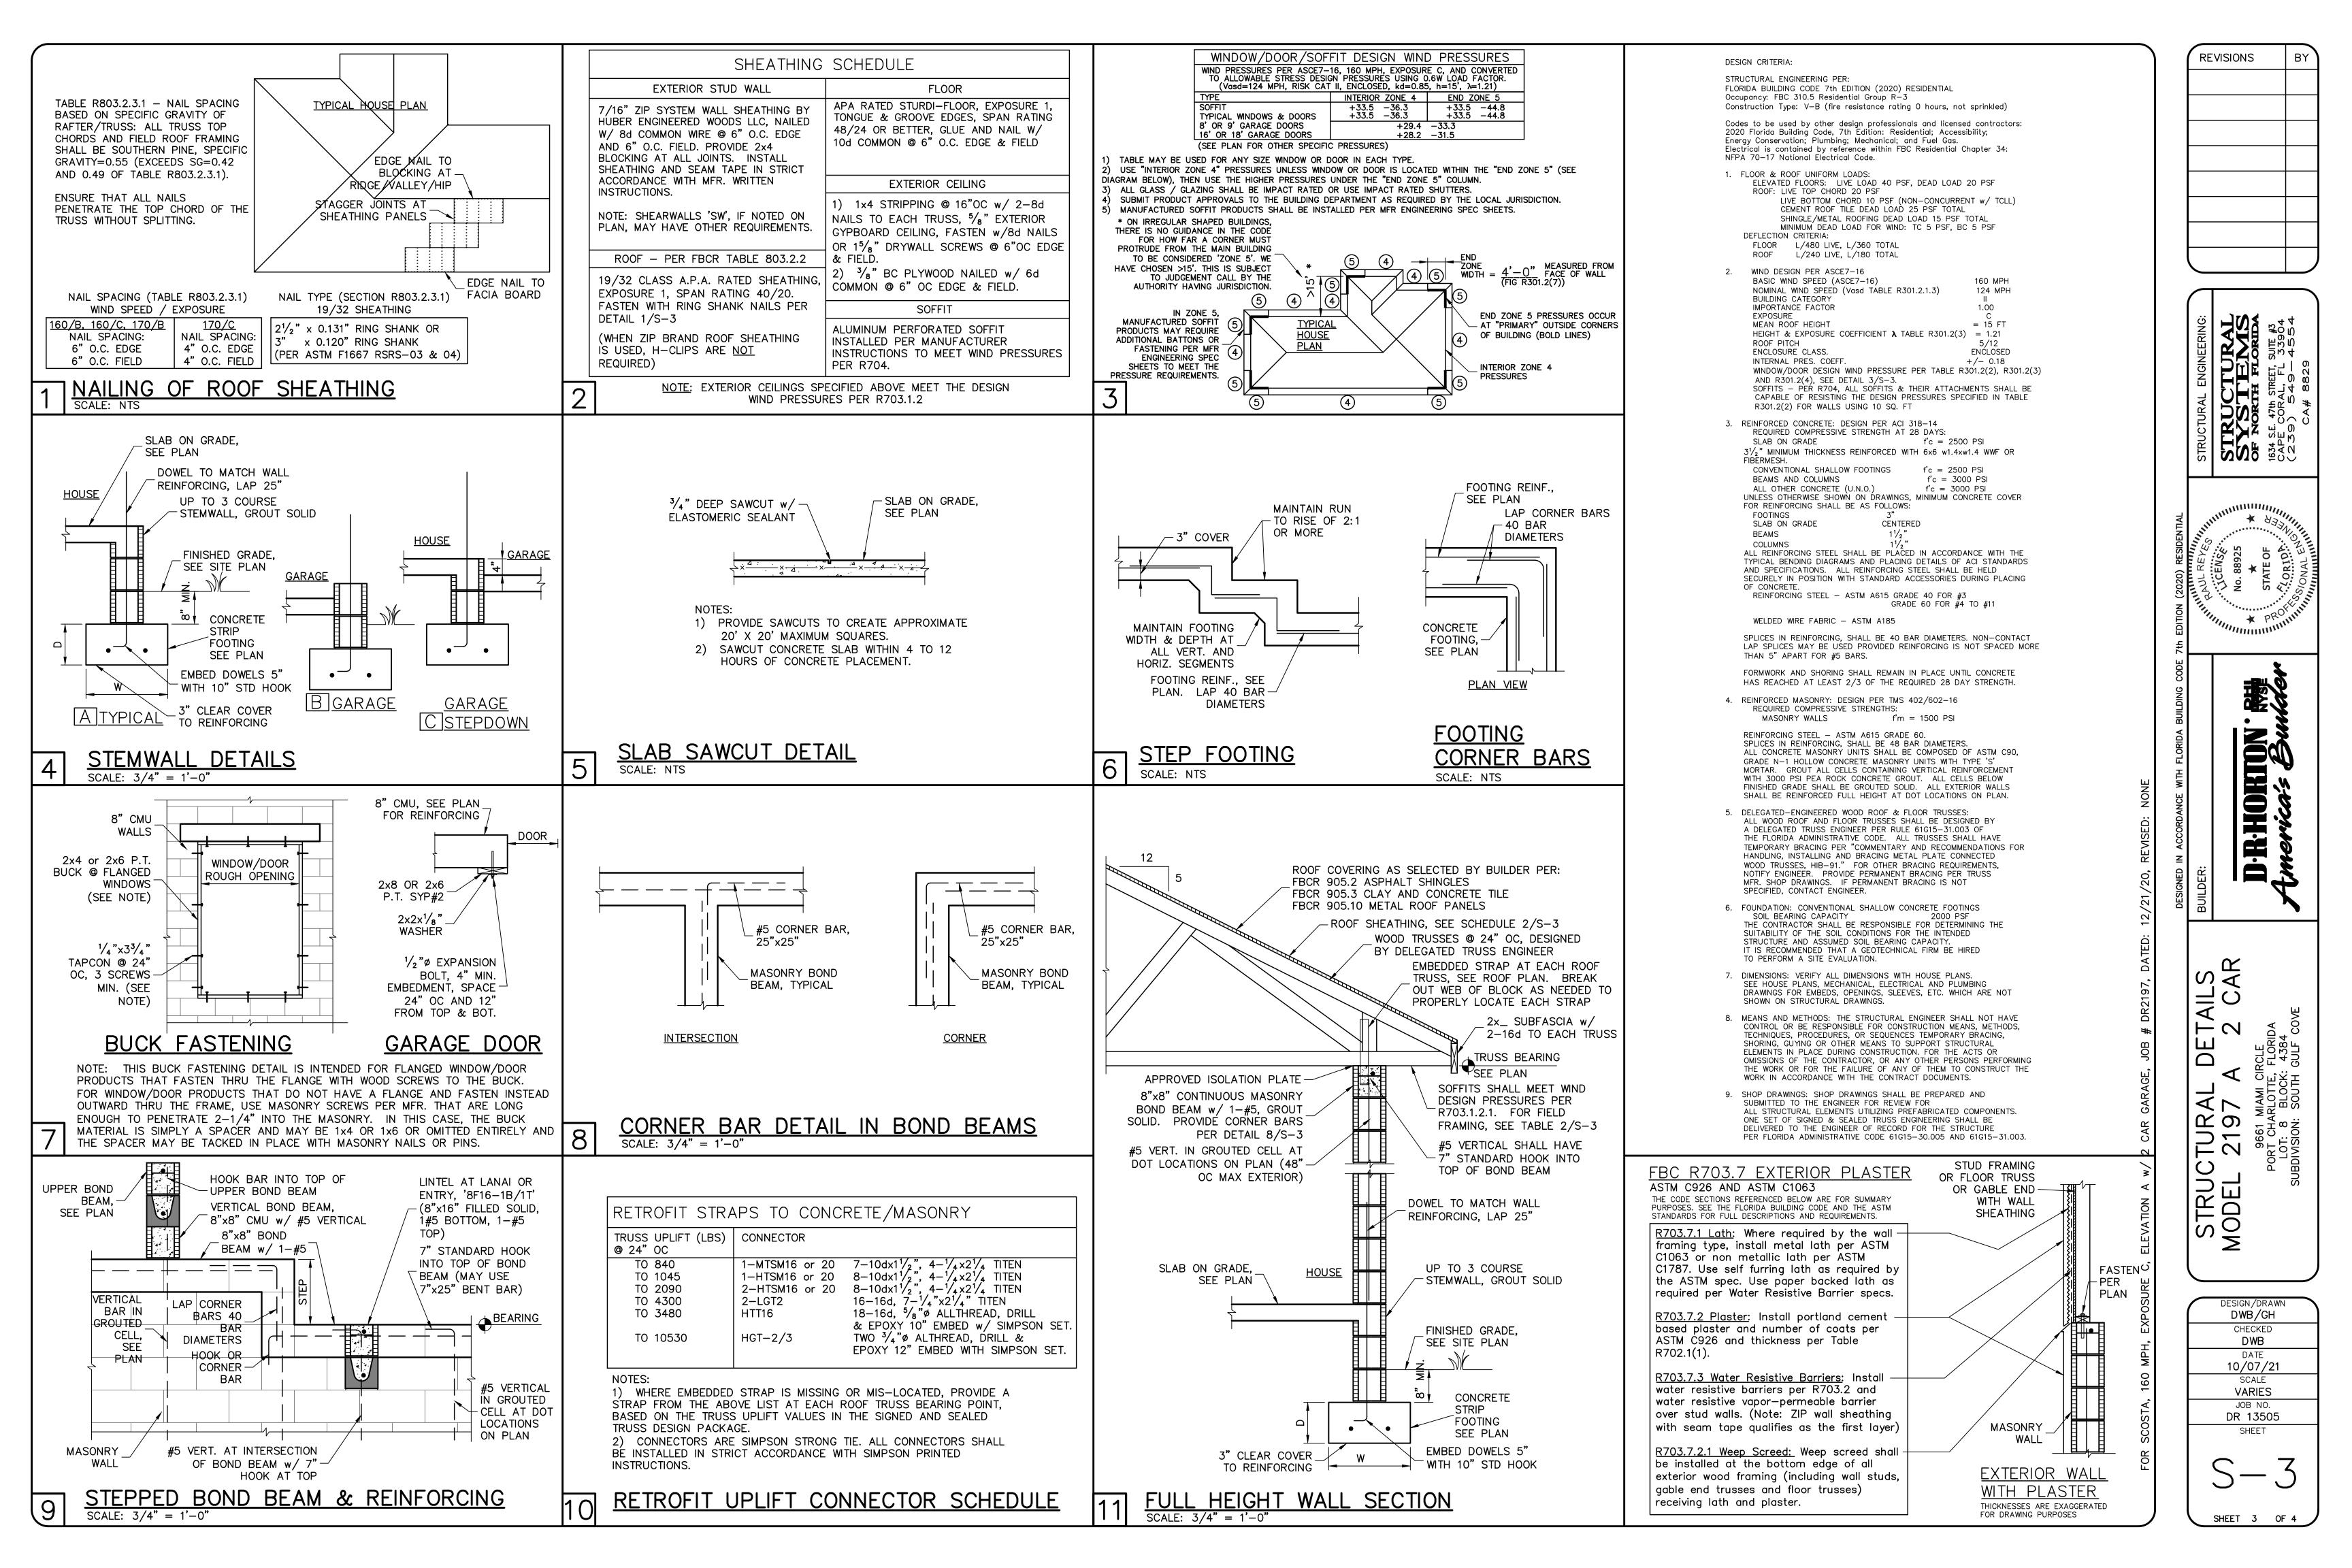

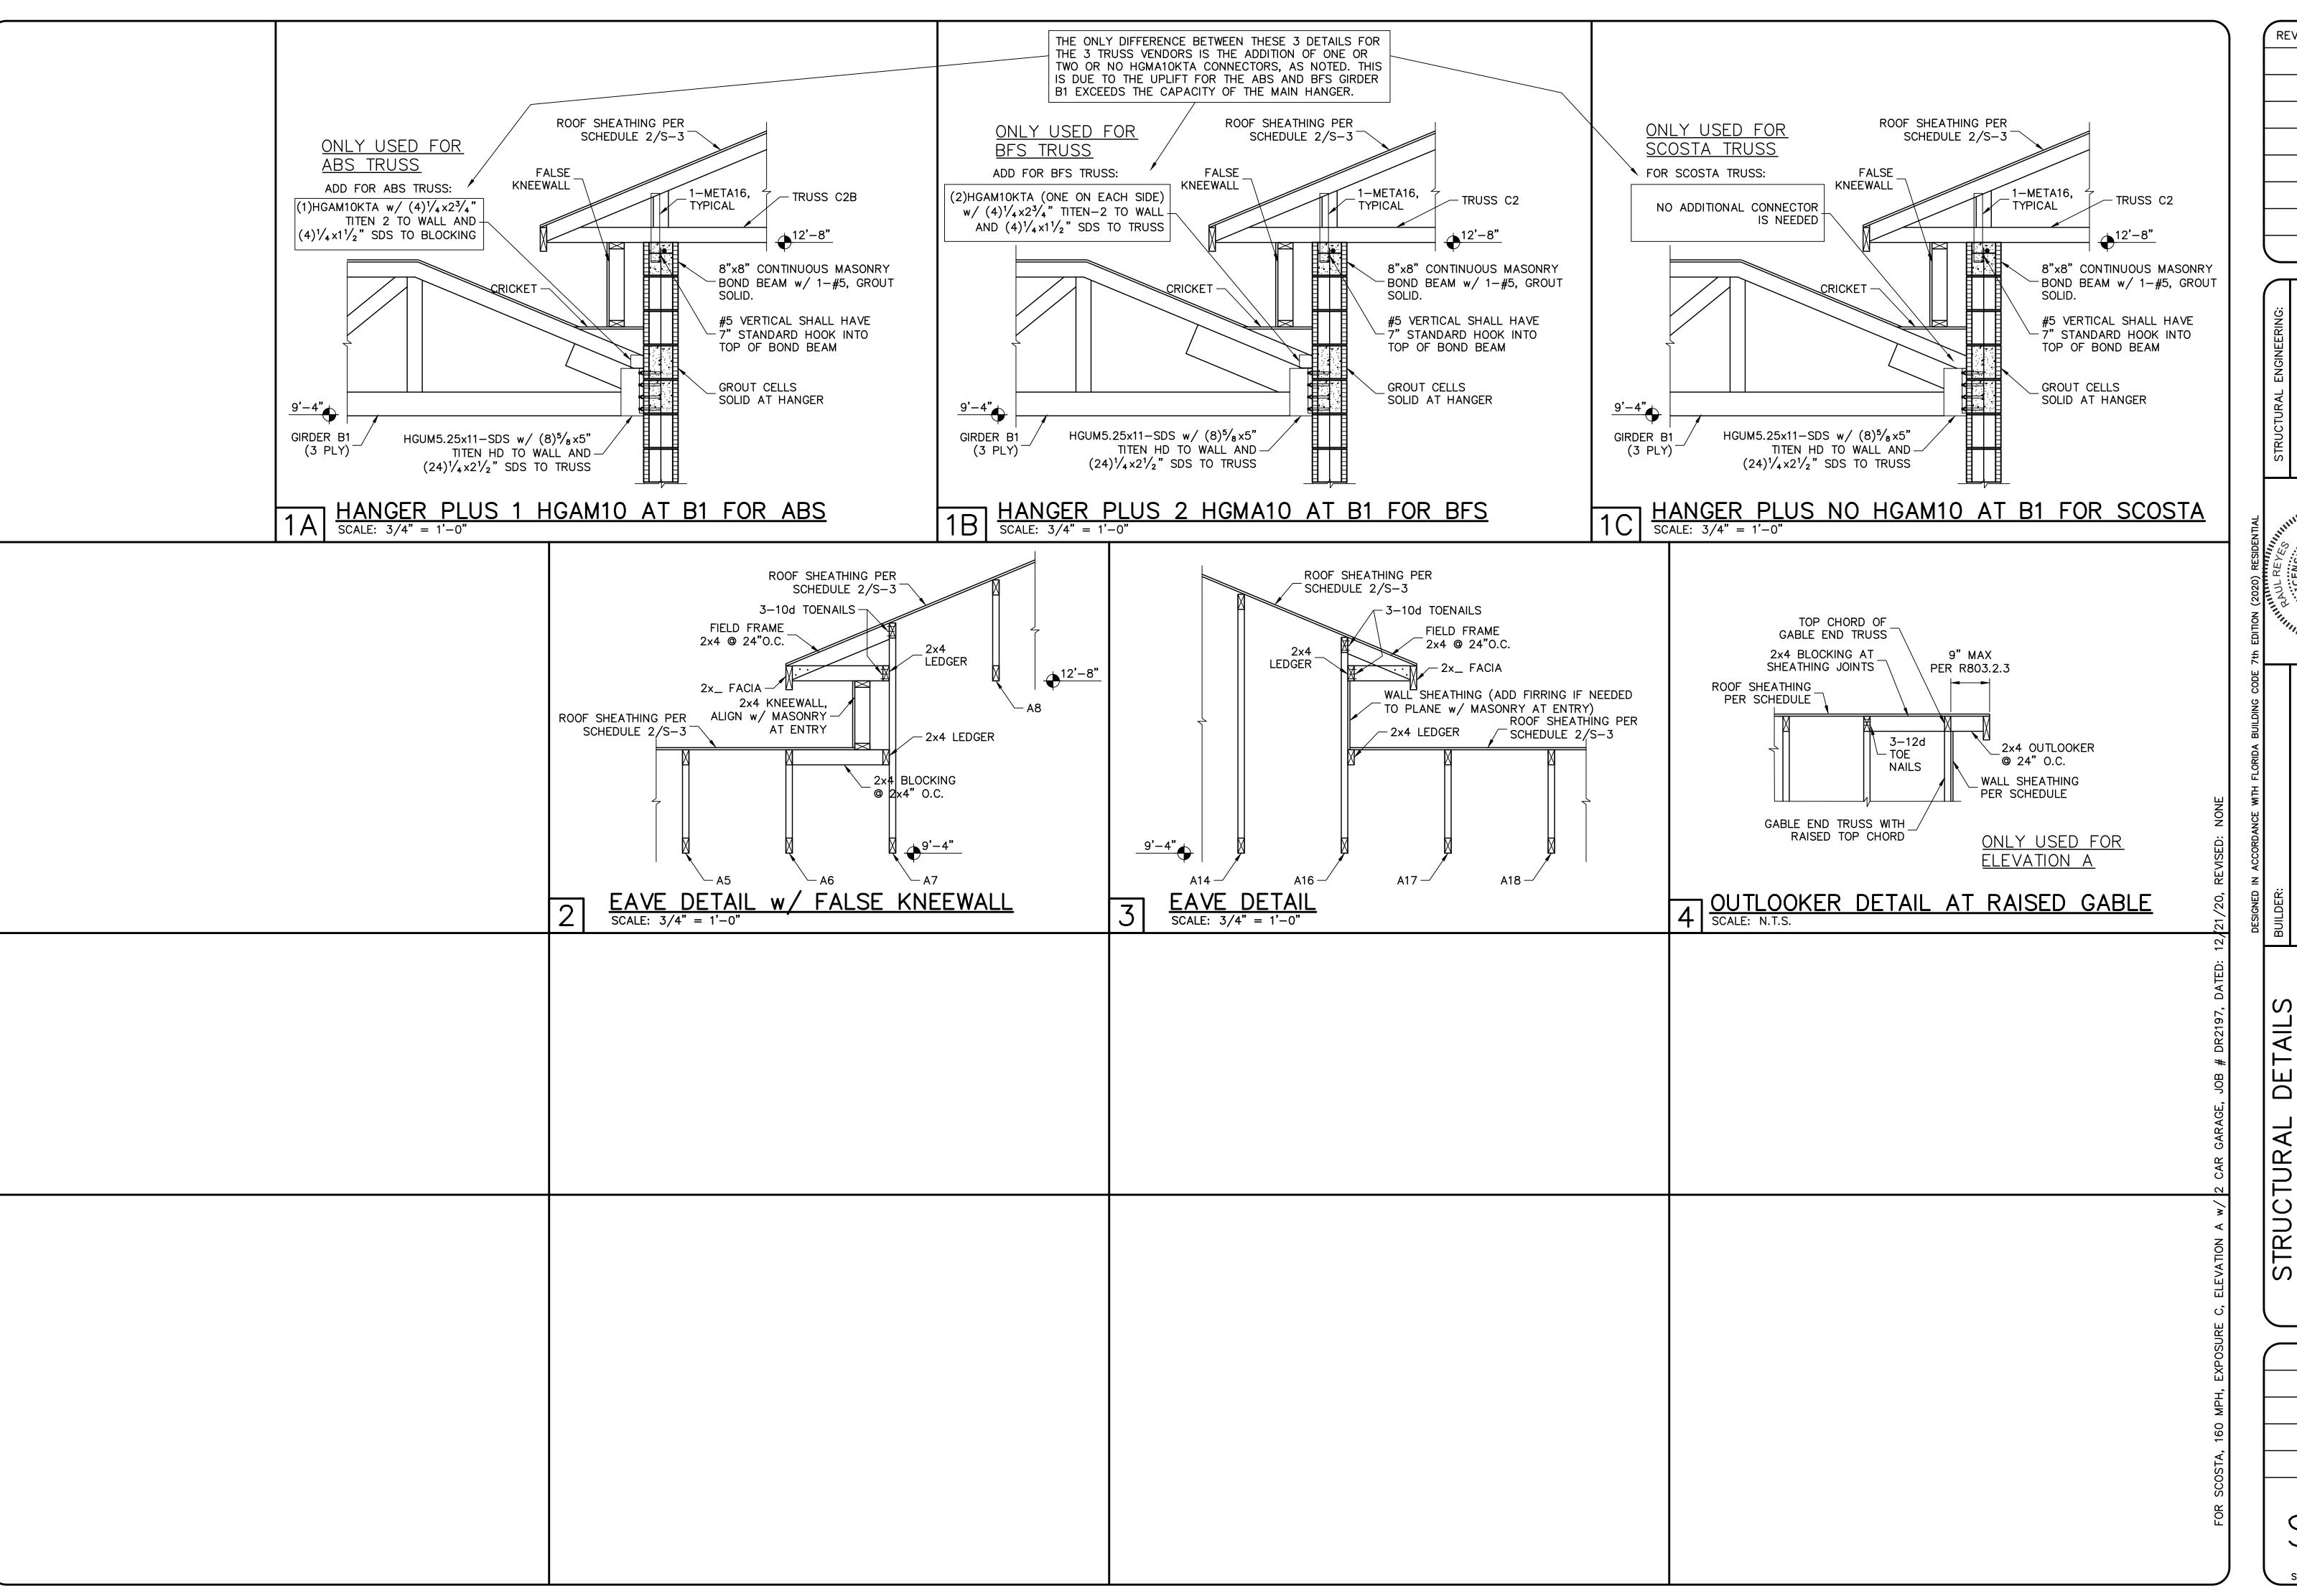

REVISIONS BY

STRUCTURAL SYSTEMS OF NORTH FLORIDA 1634 S.E. 47th STRET, SUITE #3 CAPE CORAL, FL 33904 (239) 549-4554 CA# 8829

7th EDITION (2020) RESIDENTIAL

WINDERPORT

No. 88925

STATE OF

STATE OF

NO. 88925

HORTON·解 Fica's Buttler

TAILS BUILDER:
2 CAR
DRHO

STRUCTURAL DETAILS
MODEL 2197 A 2 CA

9661 MIAMI CIRCLE
PORT CHARLOTTE, FLORIDA
LOT: 8 BLOCK: 4384
LOT: 8 BLOCK: 4384
COLETIE COLE

DESIGN/DRAWN
DWB/GH

CHECKED
DWB

DATE
10/07/21

SCALE
VARIES
JOB NO.
DR 13505

5-4