

September 25, 2021

DR Horton 10541 Six Mile Cypress Parkway Fort Myers, FL 33966 This item has been digitally signed by Derek Bergener on the date adjacent to the seal. Printed copies of this document are not considered signed and sealed and the signature must be verified on any electronic copies.

RE: AUTHORIZATION LETTER FOR MASTER PERMIT B21-04975

Model 1499 A Left

Subdivision: Gator Circle Spot Lots, Lot 38, Block 5551

3415 NE 9th Avenue, Cape Coral, Florida

This letter is to authorize DR Horton to obtain a building permit for the above referenced address using the master permit plans B21-04975.

If you need any more information, please call me at 239-549-4554.

Sincerely,

Structural Engineer of Record Derek Bergener, PE 58552



MASTERED PLAN


CAPE CORAL BUILDING DIVISION

	Ameri	ica's Bu	ilder	DATE
			ALL COMPLI	ONSTRUCTION SHALL BE IN ANCE WITH THE FLORIDA BUILDIN ALL STATE AND LOCAL CODES. THE ALL STATE AND LOCAL CODES. THE ALL STATE AND LOCAL CODES. THE ALL STATE AND OFF RESPONSIBLE TY ONTRACTOR OF RESPONSIBLE TY ONTRACTOR OF RESPONSIBLE TY.
FL#	Manufacturer	Design Pressures		
FL20468.1	Therma-Tru	Exterior	Exp. 5/31/2021	+67/-67
FL20468.4	Corporation	Doors		150.50
FL20468.5		Single		+50-50
FL12019.1	American Const.	Soffits 12"	3/2/2030	+50.0/-50.0
FL17676.1	MI Window 3540 SH	SH Fin Frame Non-impact	4/12/2022	+35.0/-50.0
FL17676.8	MI Window 3540 SH	SH Flange Non-impact	4/12/2022	+35.0/-50.0
FL15332.2	MI-420 Series	Slider-2 panel Non-impact	12/31/2024	+40.0/-40.0
FL15332.8	MI-420 Series	Slider-3 Panel Non-impact	12/31/2024	+40.0/-40.0
FL18644.1	MI Window 3540 PW	Fixed Glass Fin Non-impact	11/18/2022	+50.0/-50.0
FL9174.6	Wayne Dalton	Garage Door	6/27/2038	+39.20/-43.70
FL22270-R2	Eastern Metal Supply	Shutters	12/31/2021	+100/-100
FL30310.1	IKO Industries, LTD	Shingle	12/31/2024	NONE
NOA 18-0814.09	ABC ProGuard 20	Underlayment	08/08/2023	

REVISION

JUL 02 2021



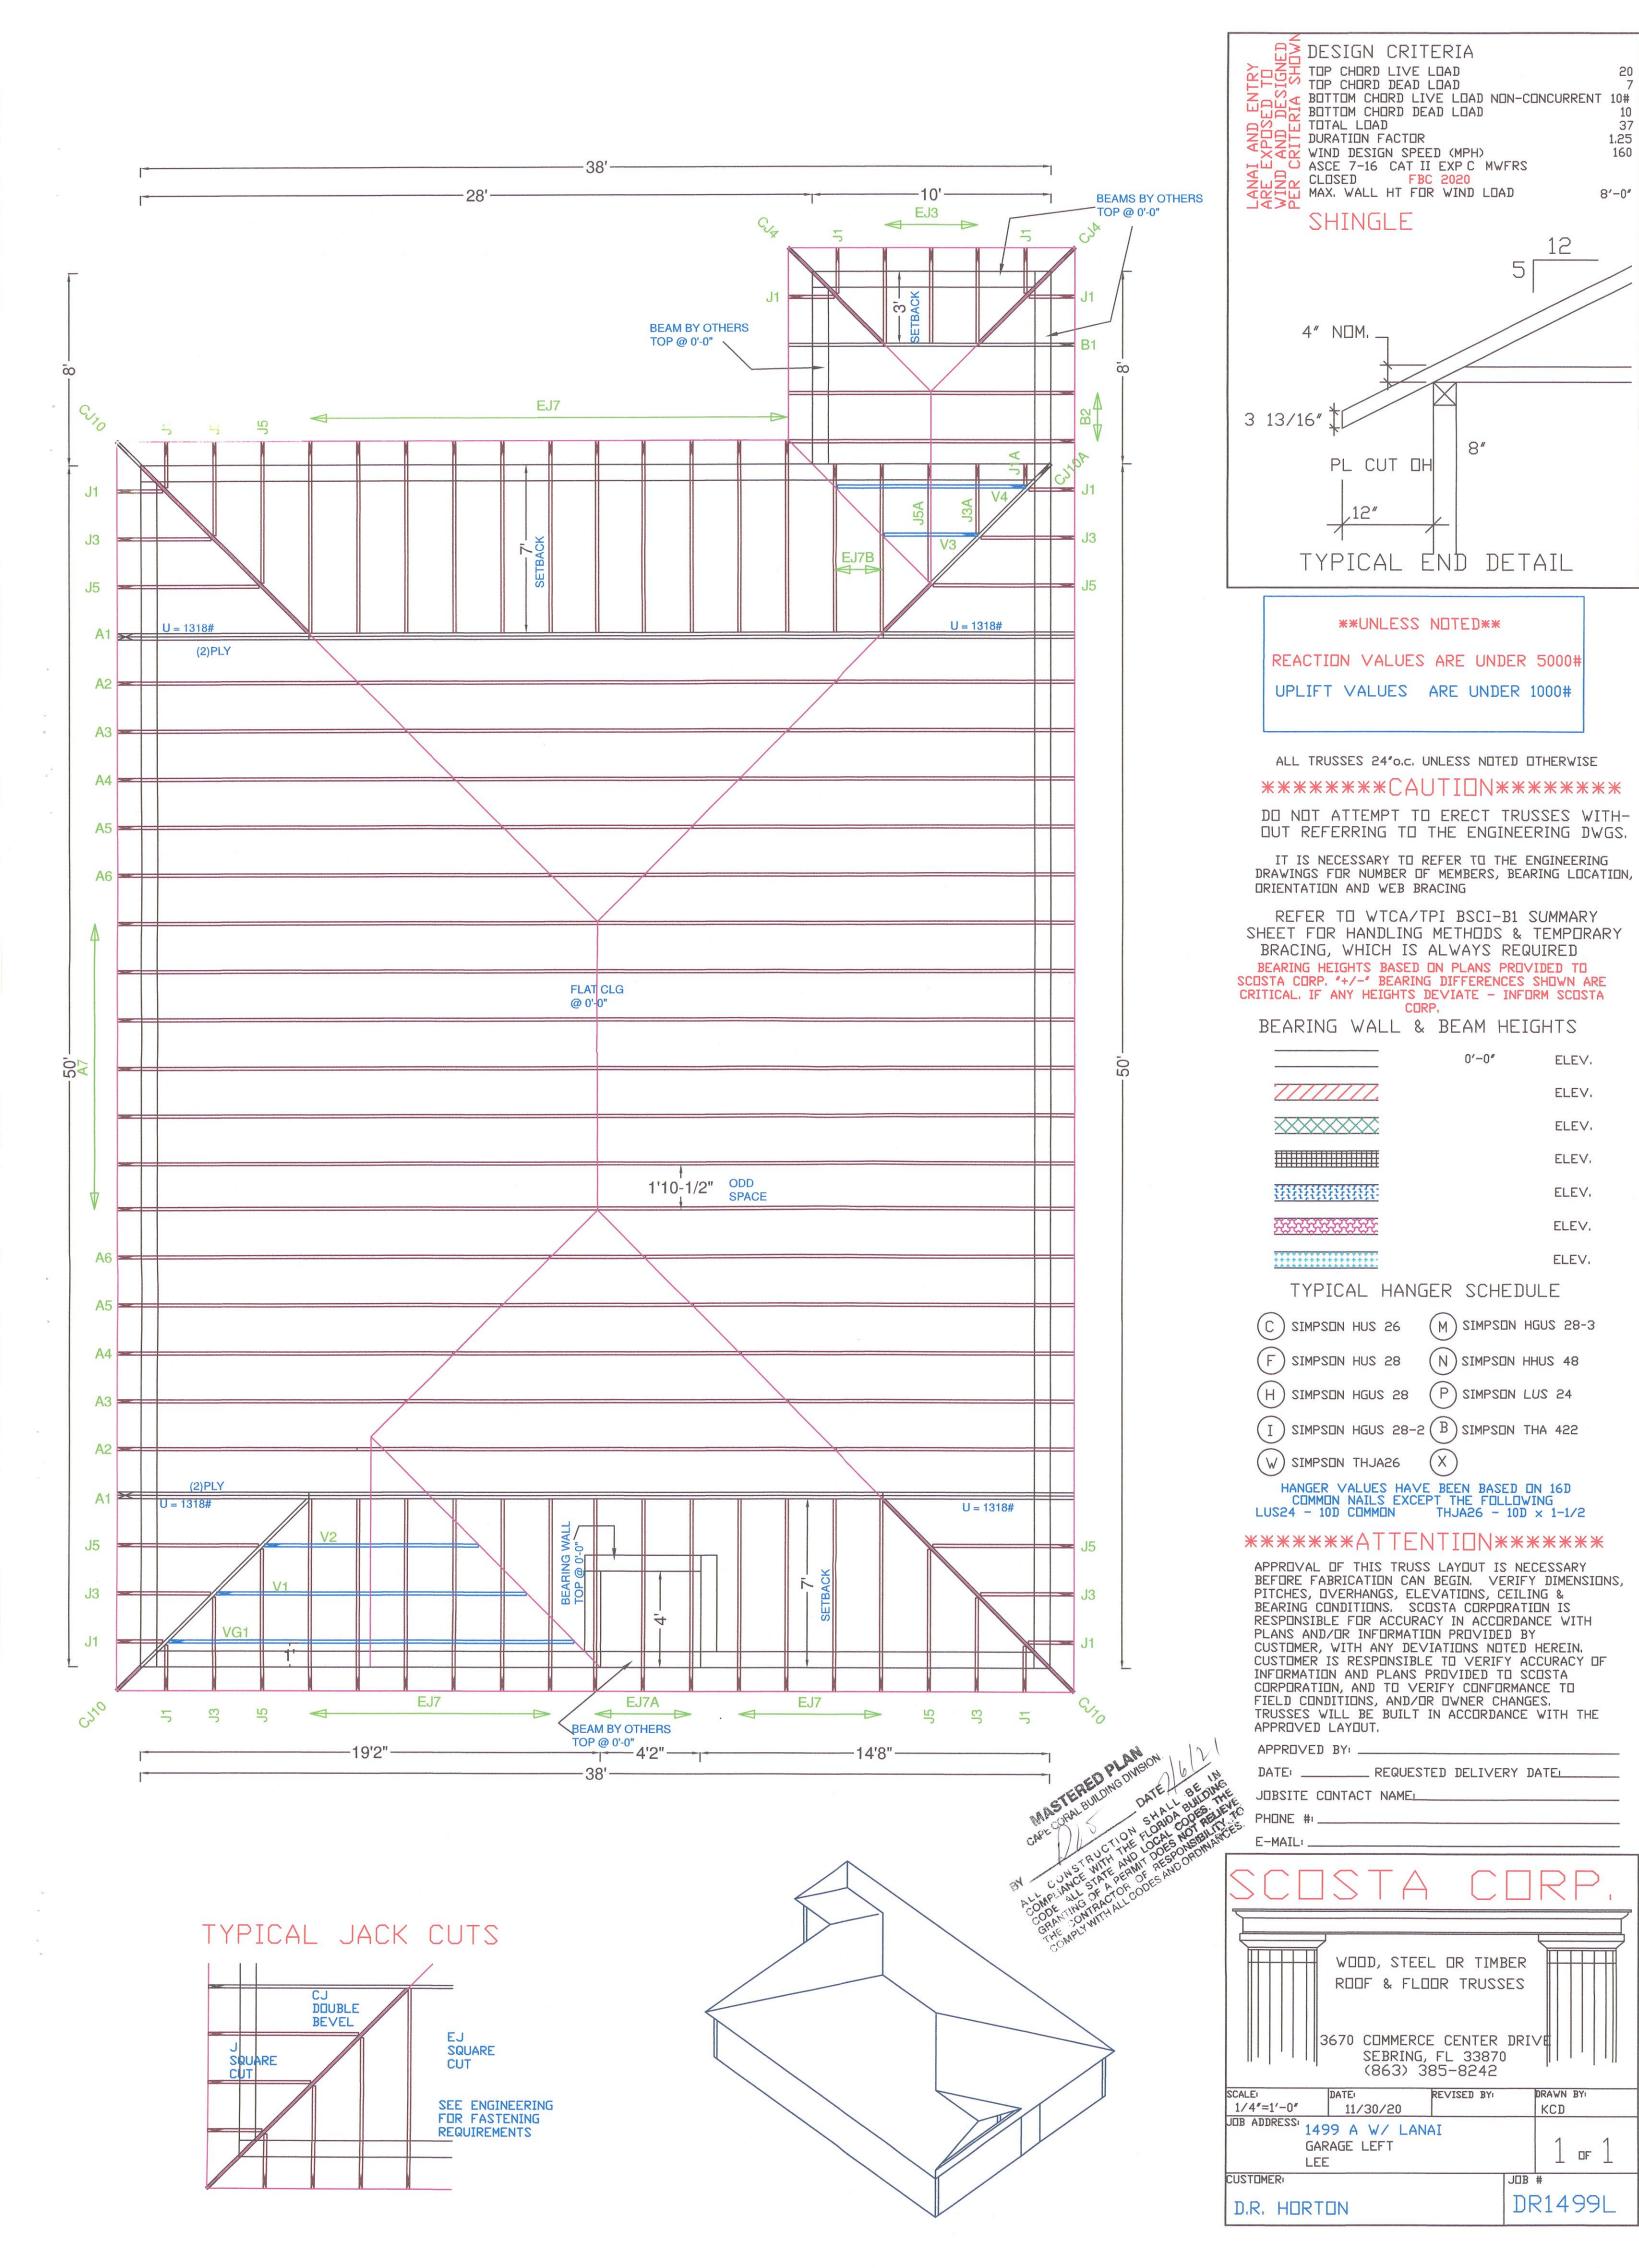

Engineer of Record for the Structure Structural Systems of N. FL, Inc. Raul Reyes, PE # 88925 1634 SE 47th Street # 3 Cape Coral, FL 33904 Sign: Date: 5/16/2/
Reviewed for conformance with the design intent of the structure and specified design criteria. Accepted Accepted Revise and As Is As noted Resubmit

8'-0"

ELEV.

ELEV.

ELEV.

ELEV.


ELEV.

ELEV.

ELEV.

DR1499L

REVISION JUL 02 2021 RESUBMIT#

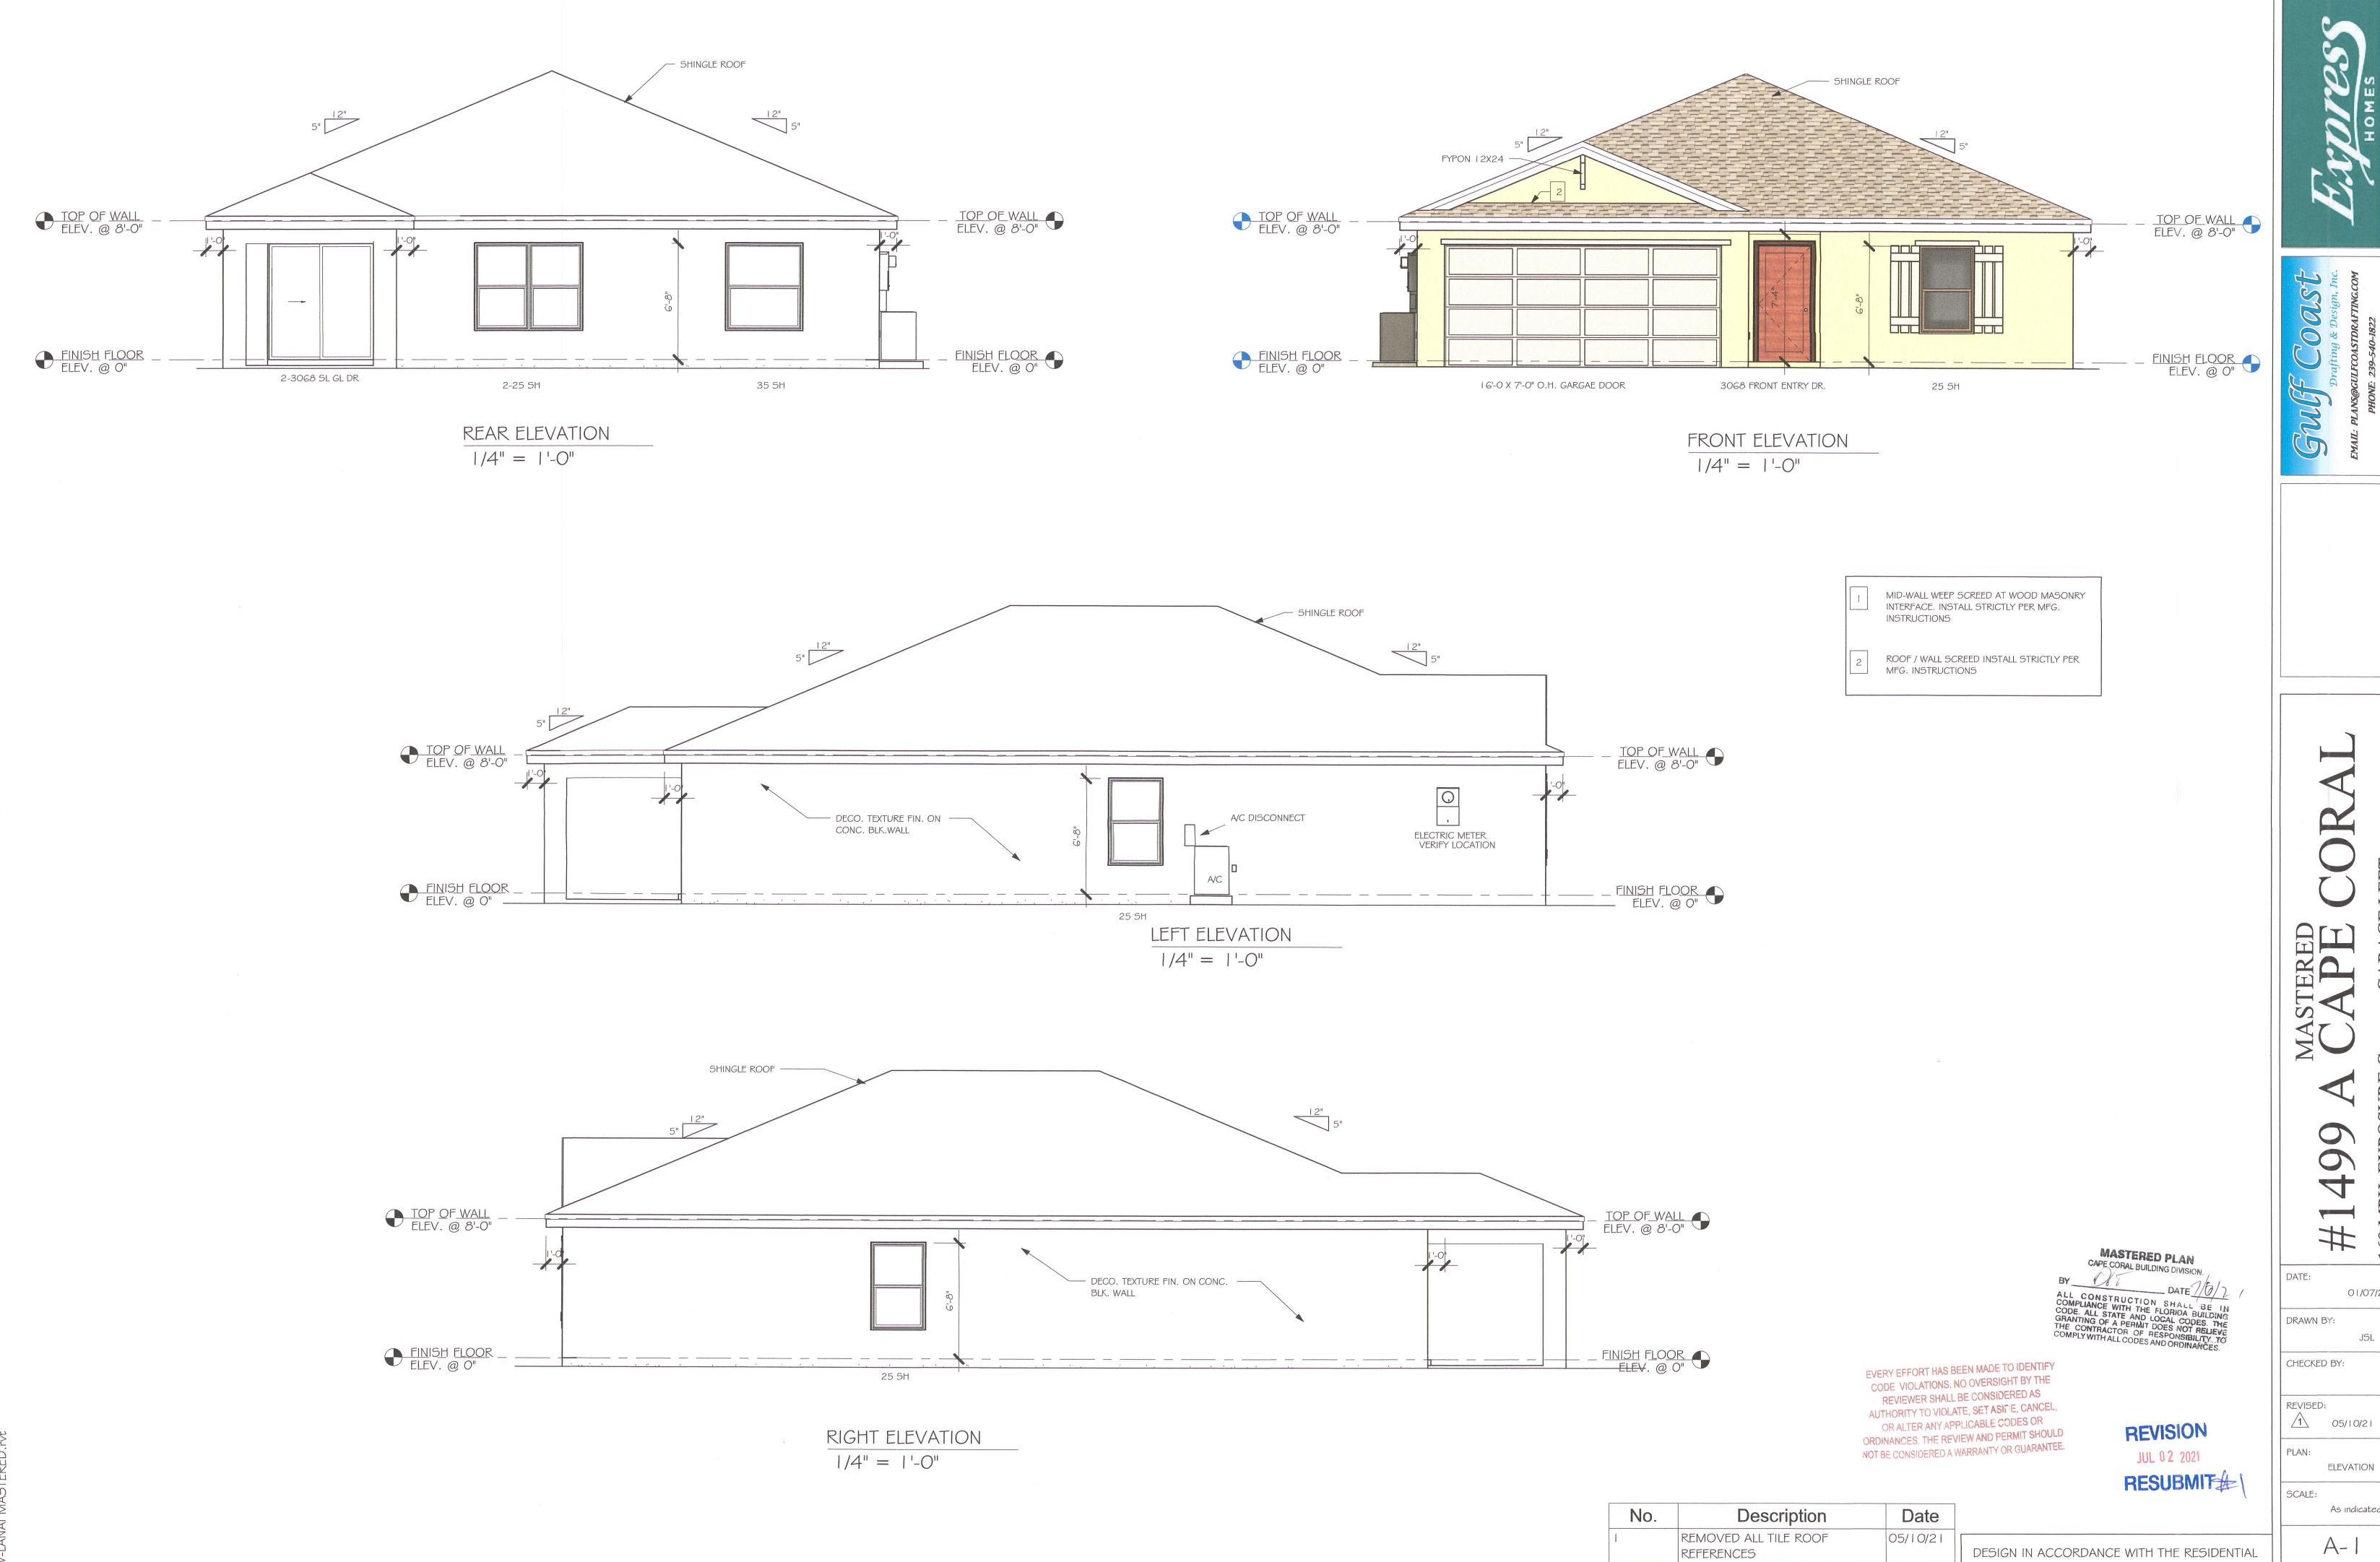



160 MPH, EXPOSURE 01/07/21 JSL

As indicated

A-1

FLORIDA BUILDING CODE 2020 - 7TH EDITION

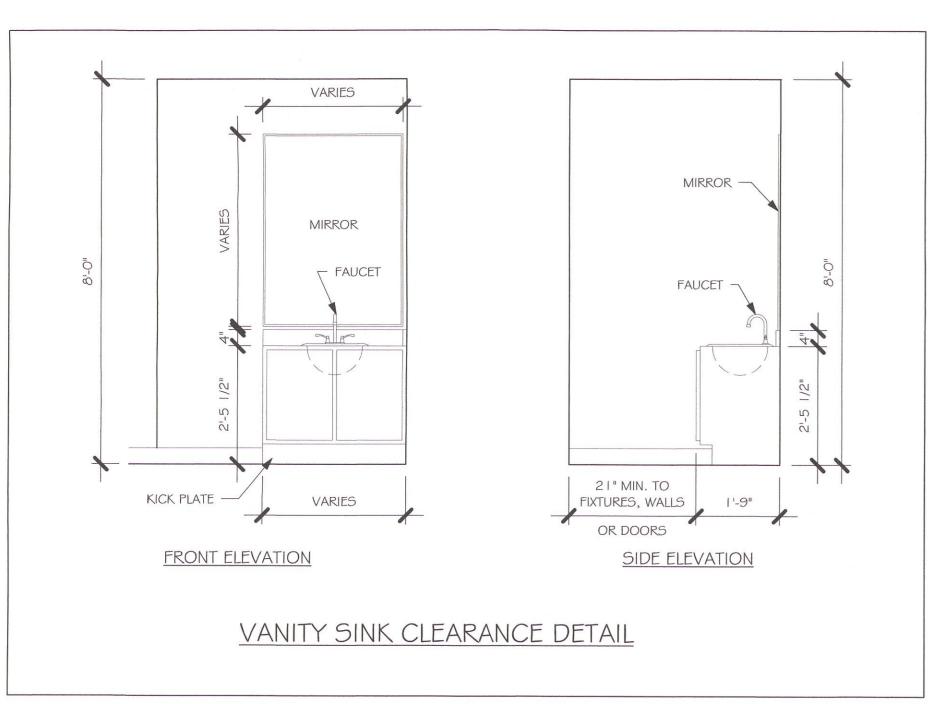

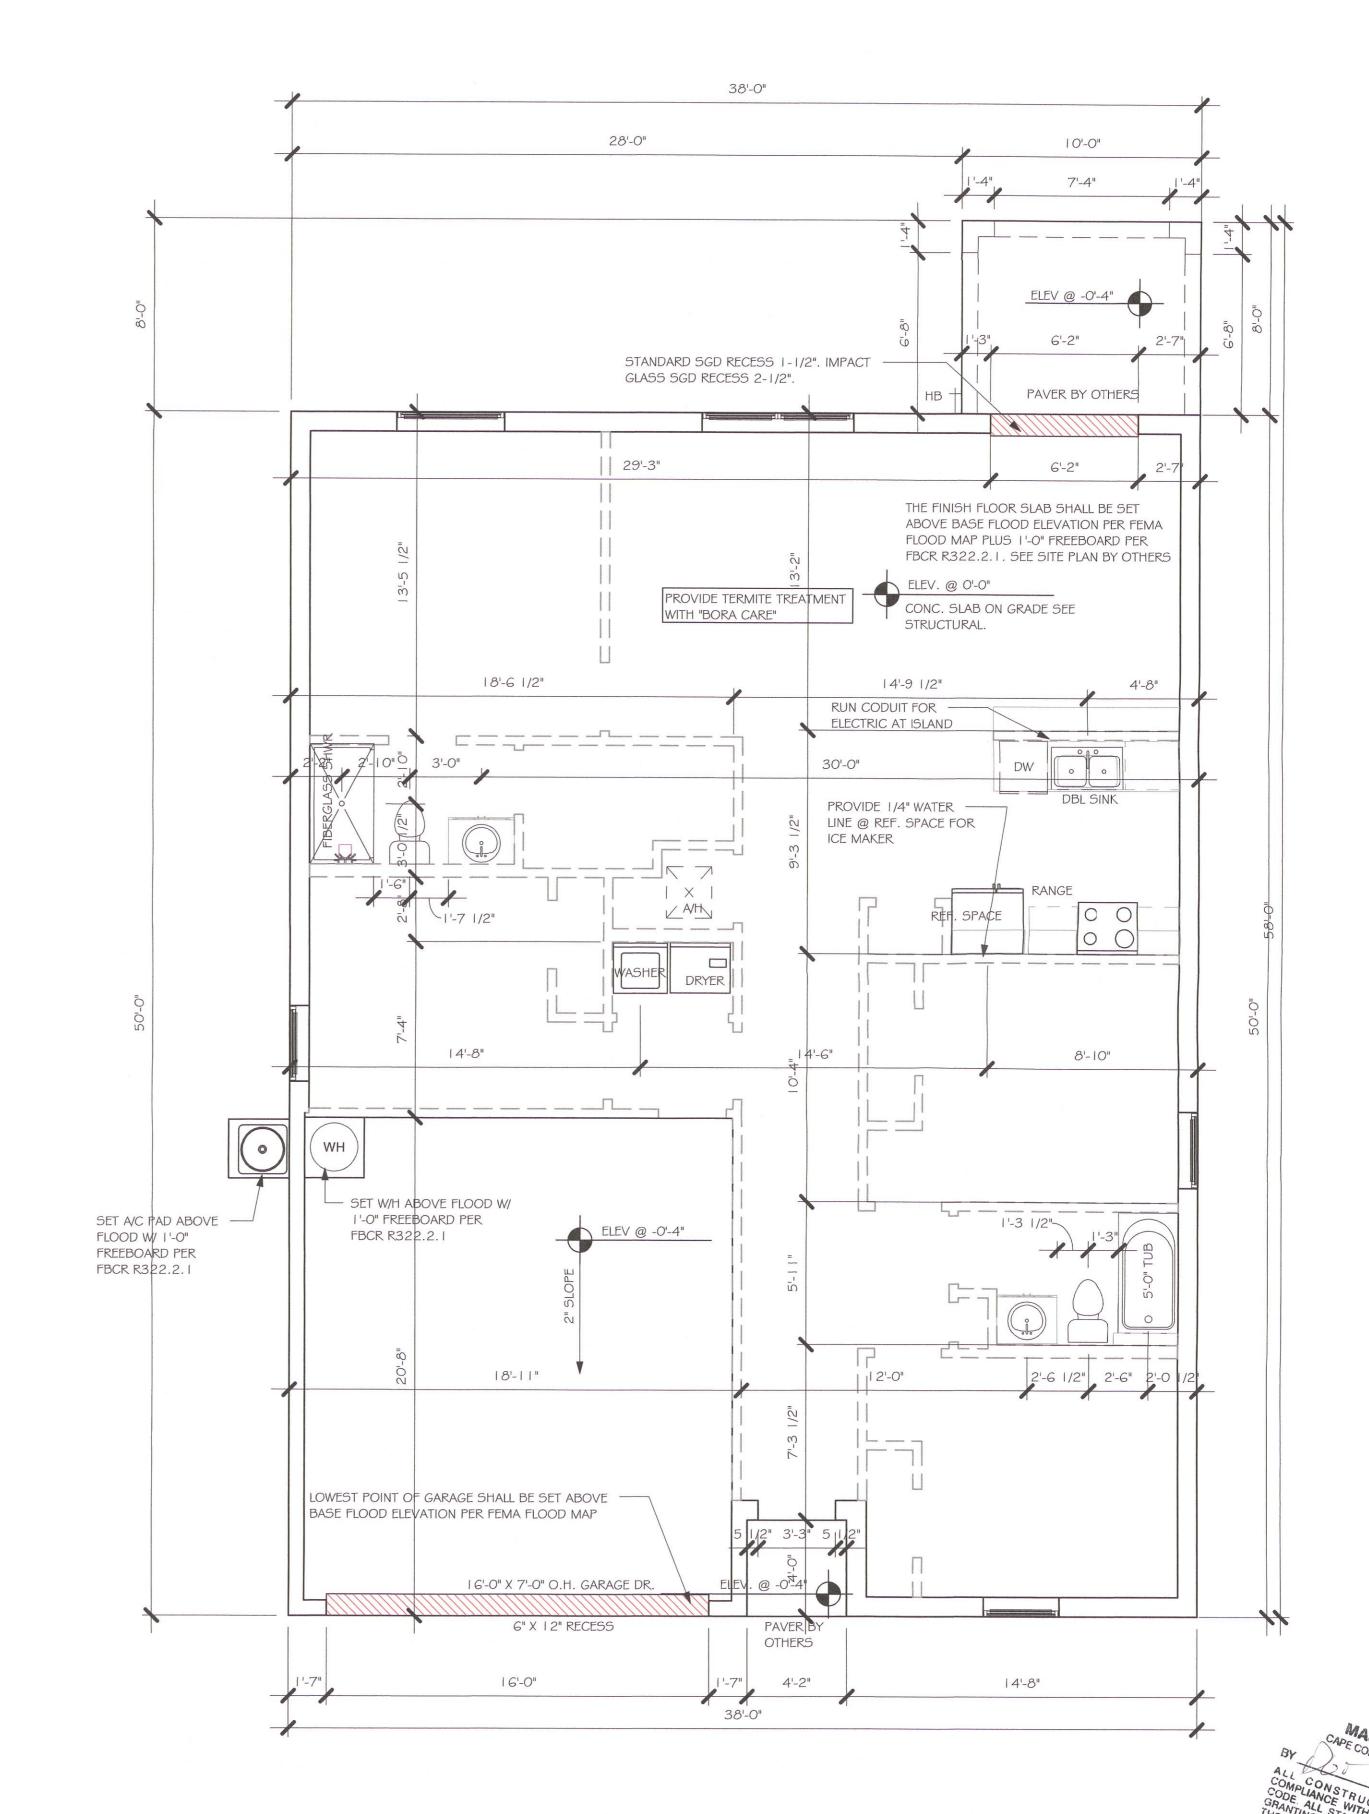

SLAB PLUMBING 1/4" = 1'-0"

> Description Date REMOVED ALL TILE ROOF 05/10/21 REFERENCES

DESIGN IN ACCORDANCE WITH THE RESIDENTIAL FLORIDA BUILDING CODE 2020 - 7TH EDITION

REVISION JUL 02 2021 **RESUBMIT**

SLAB # PLUMBING SCALE:

05/10/21

DRAWN BY:

CHECKED BY:

REVISED:

As indicated

01/07/21

7'-0"

GARAGE

	WINDO	W SCH	HEDUL	E		
MARK DESCRIPTION HEIGHT WIDTH COUNT						
Α	2-25 SH	5'-3"	6'-4"	1		
В	25 SH	5'-3"	3'-2"	3		
С	35 SH	5'-3"	4'-6"	1		

	OOR HEAD	ERS	
6'-8" BI-FOLD	HEADER HEIGHT	82" A.F.F.	
6'-8" SWING	HEADER HEIGHT	82 1/2" A.F.F.	
8'-0" SWING	HEADER HEIGHT	98 1/2" A.F.F.	

PLAN NOTES

16080 OHGD


- VERIFY ALL ROUGH OPENING DIMENSIONS FOR ALL WINDOWS AND DOORS
- PROVIDE SAFETY GLAZING WITHIN 24" FROM EXIT PER FLORIDA BUILDING CODE R 308.4.2.
- PROVIDE SAFETY GLAZING AT BATH/ SHOWER PER FLORIDA BUILDING CODE R 308.4.5.
- NON BEARING INTERIOR FRAME WALLS SHALL BE FRAMED W/ WOOD OR METAL STUDS. SPACING SHALL NOT EXCEED 24" O.C. (NON BEARING WALLS ONLY)
- PROVIDE DEAD WOOD IN ATTIC FOR OVERHEAD GARAGE DOOR HARDWARE
- KITCHEN KNEE WALL TO BE FRAMED W/ TOP @ 34 1/2" A.F.F.
- INSTALL SMOOTH WALLS IN KITCHEN AND ALL BATHROOM AREAS
- WHERE DRYWALL CEILING IS APPLIED TO TRUSSES @ 24" O.C. USE 5/8" DRYWALL OR 1/2" SAG RESISTANT PER SEC. R702.3.5
- THE GARAGE SHALL BE SEPARATED FROM THE RESIDENCE \$ ATTIC BY NOT LESS THEN 1/2" GYPSIUM BOARD APPLIED TO THE GARAGE SIDE. GARAGES BENEATH HABITABLE ROOMS SHALL BE SEPARATED WITH NOT LESS THAN 5/8" TYPE "X" GYPSUM BOARD OR EQUIVALENT. WHERE THE SEPARATIION IS A FLOOR - CEILING ASSEMBLY, THE STRUCTURE SUPPORTING THE SEPARTION SHALL ALSO BE PROTECTED BY NOT LESS THAN 1/2" GYPSOM BOARD OR EQUIVALENT
- INSTALL I 3/8" THICK SOLID WOOD DOOR BETWEEN LIVING AND GARAGE PER FLORIDA BUILDING CODE R302.5.1.
- II) ALL WINDOWS INSTALLED 72" ABOVE GRADE MUST COMPLY WITH R6 | 2.2 MIN 24" SILL HEIGHT OR PROVIDED WITH AN APPROVED WINDOW FALL PRVENTION DEVICE
- 12) ALL CLOSET SHELVES TO BE 12". ALL PANTRY \$ LINEN TO BE (4)-16" SHELVES 18" O.F.F. W/ 15" INCREMENT.
- 13) ALL MECHANICAL AND ELECTRICAL EQUIPMENT TO BE INSTALLED AT OR ABOVE FLOOD PLUS 1'-O" FREEBOARD.


IN	TERIOR DO	OR SCHEDULE
MARK	DOOR WIDTH	NOTES
	3'-0"	P.K. = POCKET DOOR
2	2'-8"	B.F. = BI-FOLD DOOR
3	2'-6"	D.1 DI-1 OLD DOOK
4	2'-4"	B.P. = BI-PASS DOOR
5	2'-0"	L.V. = LOUVERED DOOR
6	1'-8"	
7	1'-6"	
8	2'-11"	

SQUARE FOO	TAGE
LIVING AREA	1499
GARAGE AREA	385
LANAI AREA	80
FRONT PORCH/ ENTRY AREA	16
TOTAL SQUARE FOOTAGE	1,980

	BATHROOM NOTES	
TB TOWEL BAR	ALL TUB DECKS @ 21" A.F.F	
TP TOILET PAPER	ALL BLOCKING TO BE PT IN SHOWERS	
4-0 _"	TOWEL BAR TOILET PAPER ROLL 4" 4" MINMIN.	

CA	ABINET BACK	KING
KITCHEN	UPPER TOP @ 84"	BASE TOP @ 35"
MASTER BATH	UPPER	BASE TOP @ 35"
GUEST BATH	UPPER	BASE TOP @ 31"
LAUNDRY ROOM	UPPER TOP @ 84"	BASE

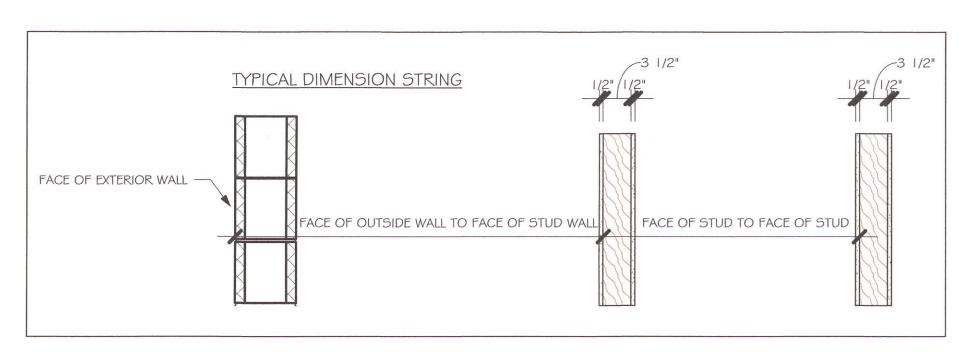

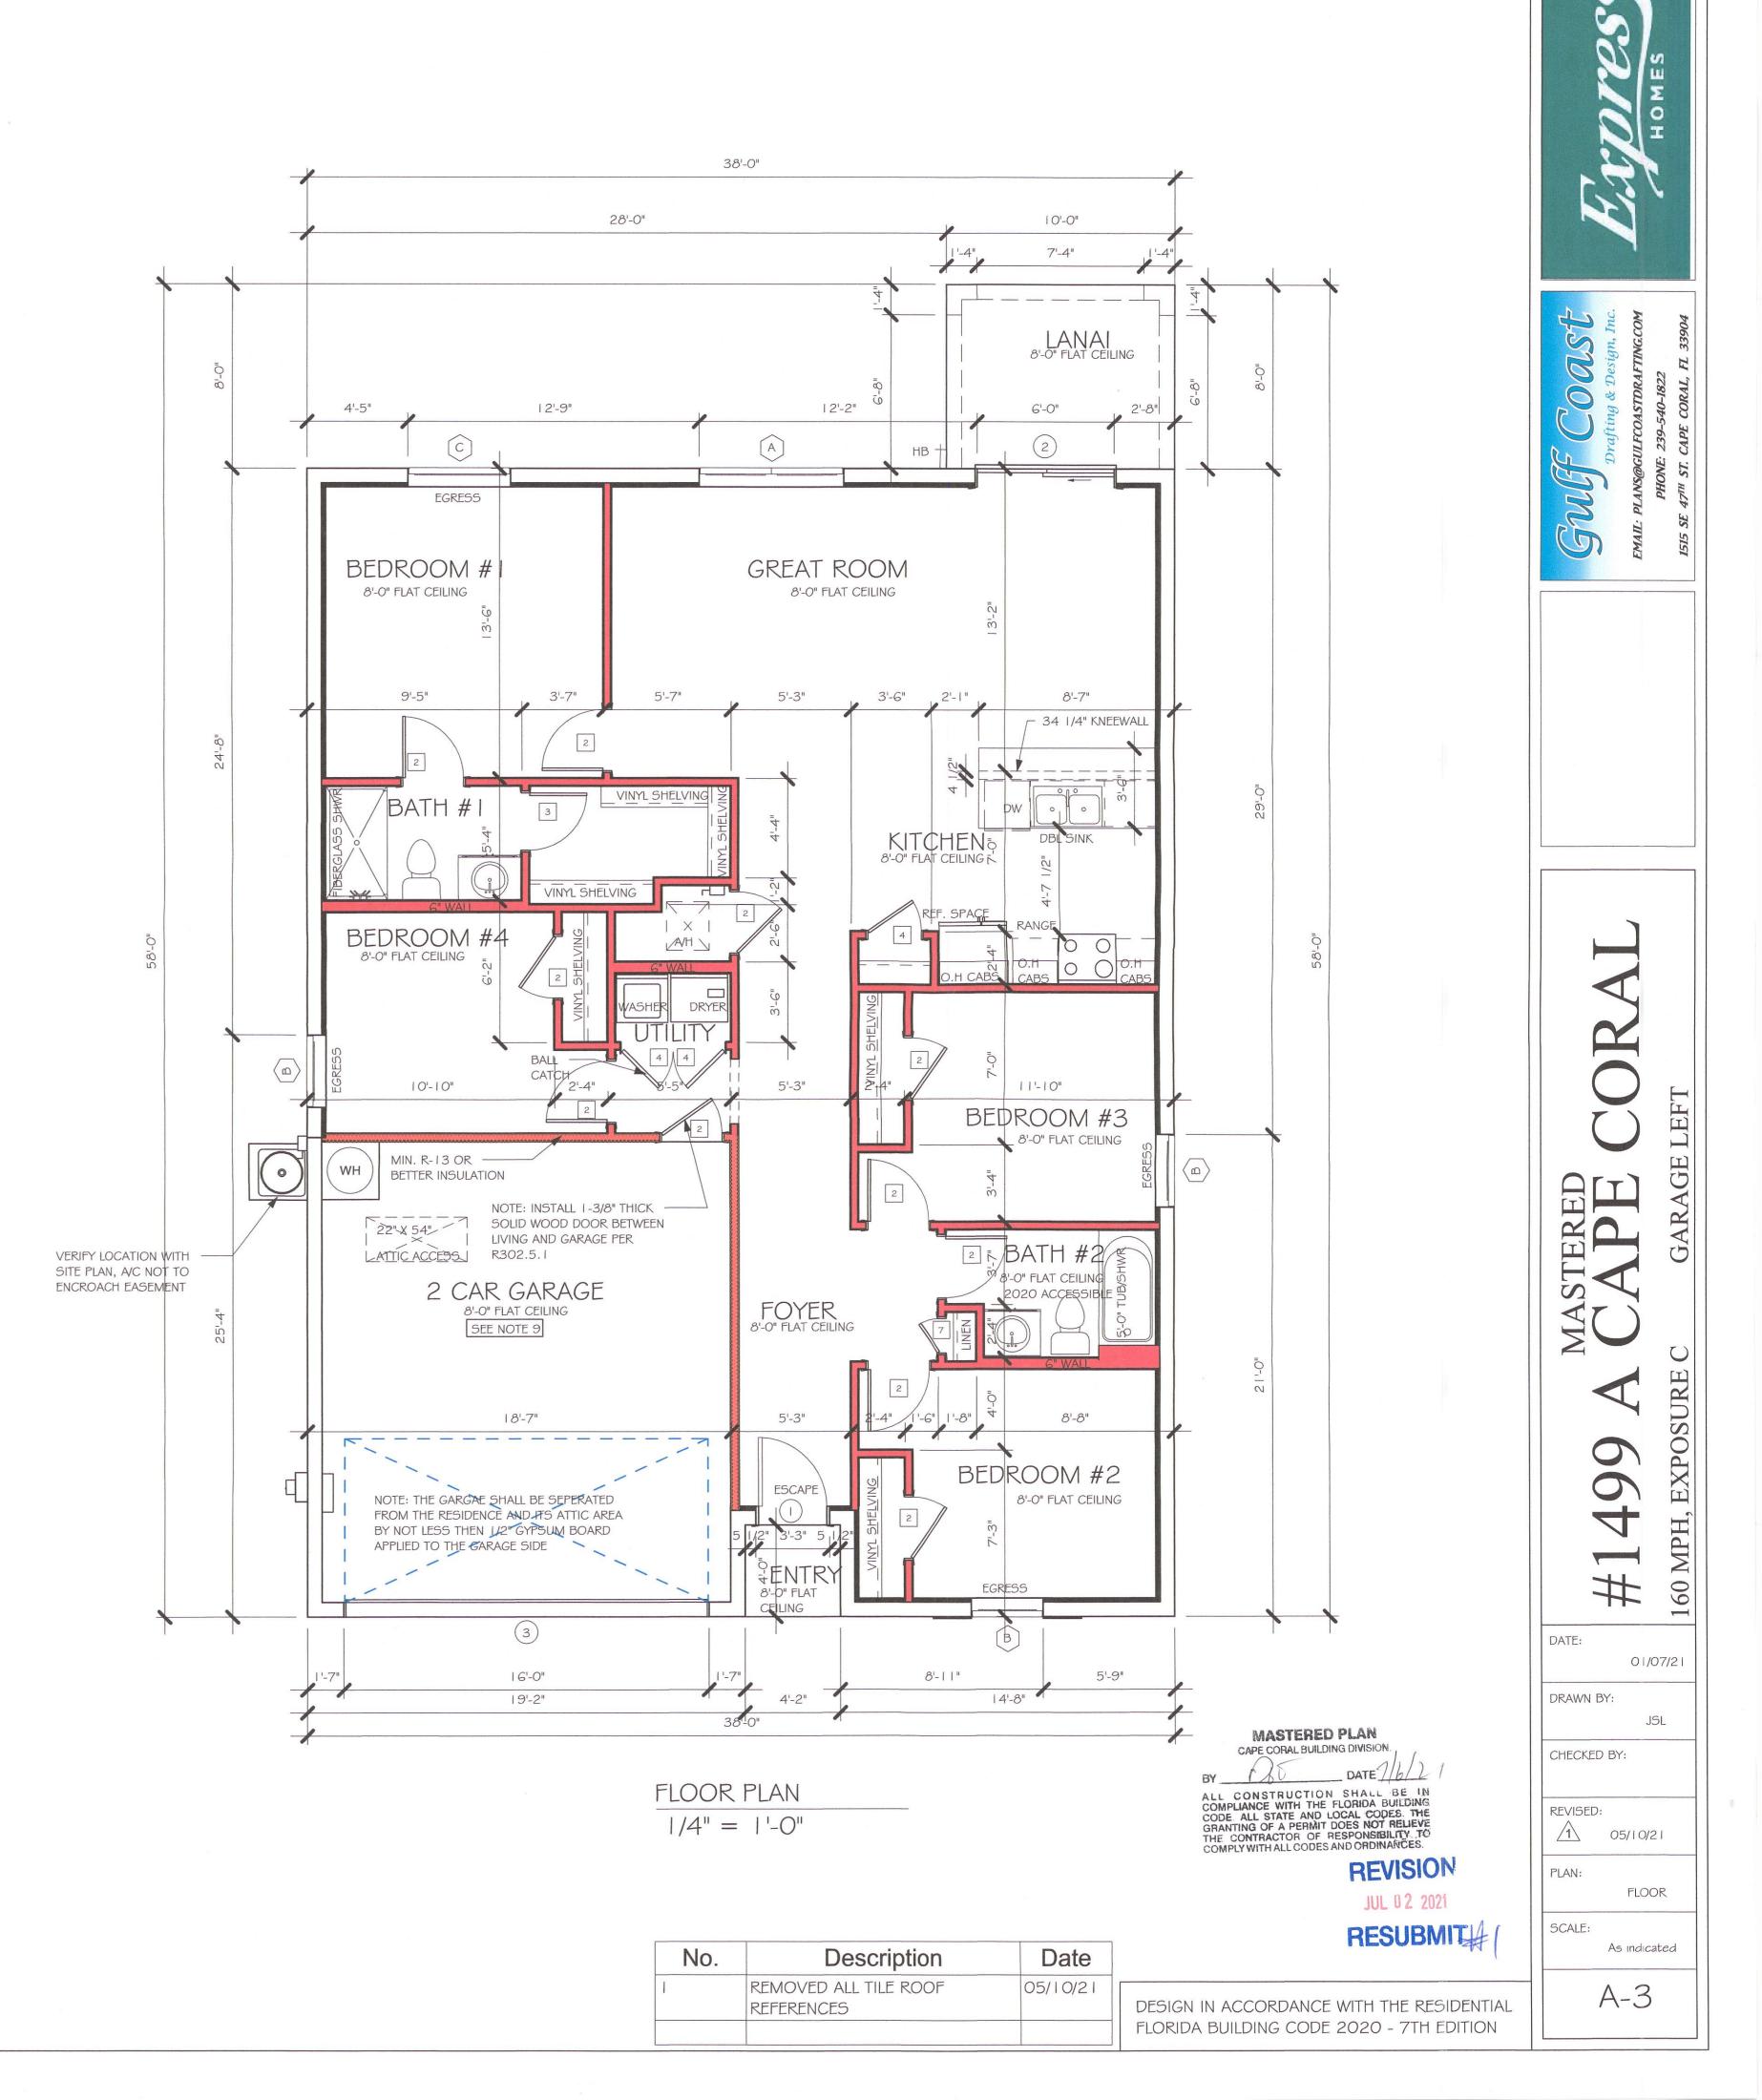

MODEL 1499 A: ATTIC VENTILATION FBCR R806

COORDINATE VENTING REQUIREMENTS WITH ENERGY CALCULATIONS

			SOFFIT ONLY (1/150) (NO ROOF VENTS) ATTIC VENTILATION REQUIRED			WIT	WITH ROOF VENTS (1/300) (R.V.)		
AREAS (SQ. FT.)		ATTIC				ATTIC VENTILATION REQUIRED			
MARK	ATTIC	SOFFIT	ATTIC AREA/150 REQ'D AIR FLOW QUAD 4 SOFFIT HAS		ATTIC AREA/300	QUANTITY OF ROOF VENTS	MIN AIR FLOW OF SOFFIT		
1st STORY	2080.0 SQ. FT.	180.0 SQ. FT.	13.87 SQ.FT.	7.71%	8.15%	SQ. FT.	-	%	
		"SOFFIT ONLY" QUALIFIES				ROOF VENTS ARE NOT REQUIRED			
		SOFFIT MODEL ACM QUAD 4, FULL VENT, NARROW PATTERN, 8.15% FREE AIR FLOW		22-3/8" BASE					

WALL HEIGHT

= WALL @ 8'-0"

GREAT ROOM 8'-0" FLAT CEILING BATH #1 KITCHEN 8'-0" FLAT CEILING BEDROOM #4 8'-0" FLAT CEILING BEDROOM #3 8'-0" FLAT CEILING ATTIG ACCESS BATH #2 8'-0" FLAT CEILING 2 CAR GARAGE 8'-0" FLAT CEILING BEDROOM #2 8'-0" NAT CEILING

> ROOF PLAN 1/4" = 1'-0"



REVISION

JUL 0 2 2021 **RESUBMIT**

DESIGN IN ACCORDANCE WITH THE RESIDENTIAL FLORIDA BUILDING CODE 2020 - 7TH EDITION

Description Date No. REMOVED ALL TILE ROOF 05/10/21 REFERENCES

#1 DATE:

01/07/21 DRAWN BY: JSL CHECKED BY: REVISED: 05/10/21 PLAN:


ROOF SCALE: As indicated

A-4

El	ECTRICAL LEGEND				
	ELECTRICAL METER				
	ELECTRICAL PANEL				
	I 20 V JUNCTION BOX				
$\overline{\bigcirc}$	SINGLE RECEPTACLE OUTLET				
	220 V RECEPTACLE OUTLET				
<u> </u>	4-PLEX RECEPTACLE OUTLET				
	DUPLEX RECEPTACLE OUTLET				
<u> </u>	I/2 SWITCHED DUPLEX OUTLET				
AFF	DUPLEX RECEPTACLE AT ELEV. A.F.F.				
-	DUPLEX RECEPTACLE - ABOVE COUNTER				
⇔	SINGLE POLE SWITCH				
() 3	3 WAY SWITCH				
₩ D	DIMMER SWITCH				
₩S	MOTION SENSOR SWITCH				
⊗ _{sc}	AC/DC SMOKE DETECTOR TO BE INTERCONNECTED ANY RESIDENT HAVING A FOSSIL-BURNING HEATER OR APPLIANCE, A FIREPLACE, OR AN ATTACHED GARAGE SHALL HAVE AN OPERATIONAL CARBON MONOXIDE ALARM INSTALLED WITHIN 10 FEET OF EACH ROOM USED FOR SLEEPING PERPOSES. PER RULE 9B-3.04.72 SD (SMOKE DETECTOR) SCD (CARBON MONOXIDE/ SMOKE DETECTOR)				
-[T]	TELEPHONE OUTLET				
-[TV]	TELEVISION RECEPTION OUTLET				
	SURFACE MOUNTED CEILING LIGHT				
0	FLUSH MOUNTED LIGHT				
Ю	WALL MTD. BRACKET LIGHT				
400	DUPLEX FLOOD LIGHT				
	EXHAUST FAN				
	TRACK MTD. LIGHTS				
	A/C DISCONNECT				
Ю	PUSH BUTTON (PB) / DOOR BELL (DB)				
(IC)	INTERCOM				
	KEYPAD				
	4' FLUORESCENT LIGHT				
) 	2' UNDER COUNTER LIGHT				
NOTE: NO	DT ALL SYMBOLS ARE USED FOR THIS				
PROJECT					
ELECTRICAL NOTES: ARC-FAULT CIRCUIT-INTERRUPTERS AND TAMPER RESISTANT RECEPTACLES SHALL BE INSTALLED IN DWELLING UNITS PER N.E.C 210.12 AND 406.11 ALL ELECTRIC, ELECTRICAL EQUIPMENT AND APPLIANCES TO BE SET AT OR ABOVE BASE FLOOD ELEVATIONS PLUS 1'-0" FREEBOARD. ALL OUTLETS IN WET AREAS AND ALL EXTERIOR OUTLETS TO BE GFI'S.					
	EXTENSIA COTTETS TO BE GITS.				

INSTALL PHONE AND T.V PER CONTRACT.

INSTALL ALL ELECTRICAL PER NEC 2014

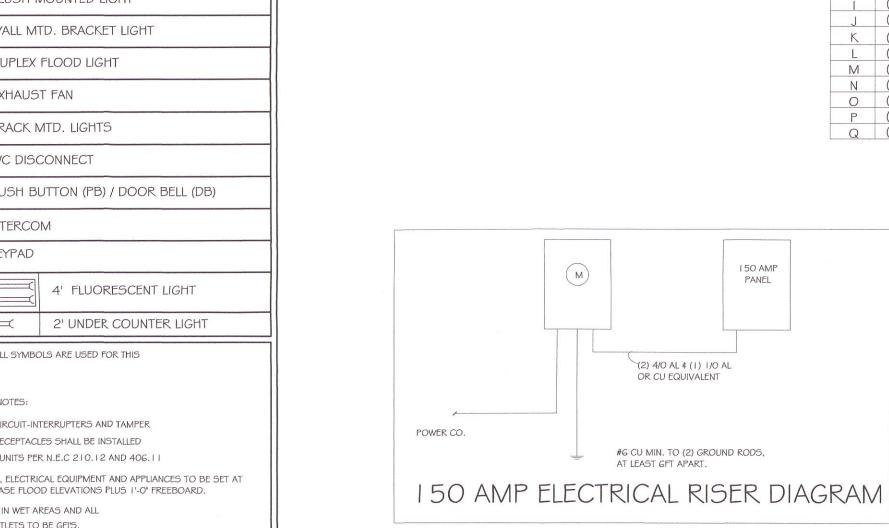

ELECTRICAL PLAN

(FLUSH MOUNTED LT)

(VAPORS) (PENDANT LIGHT (10" MUSHROOMS)

(24" 3 LT) (36" LT) (NOT USED)

(COACH LIGHTS)

(4' FLUORESCENT)

(2' FLUORESCENT)


(5LT CHANDELIER)

(PENDANT/ NOOK)

(3 LT)

TAG QUANTITY PRODUCT

150 AMP SERVICE

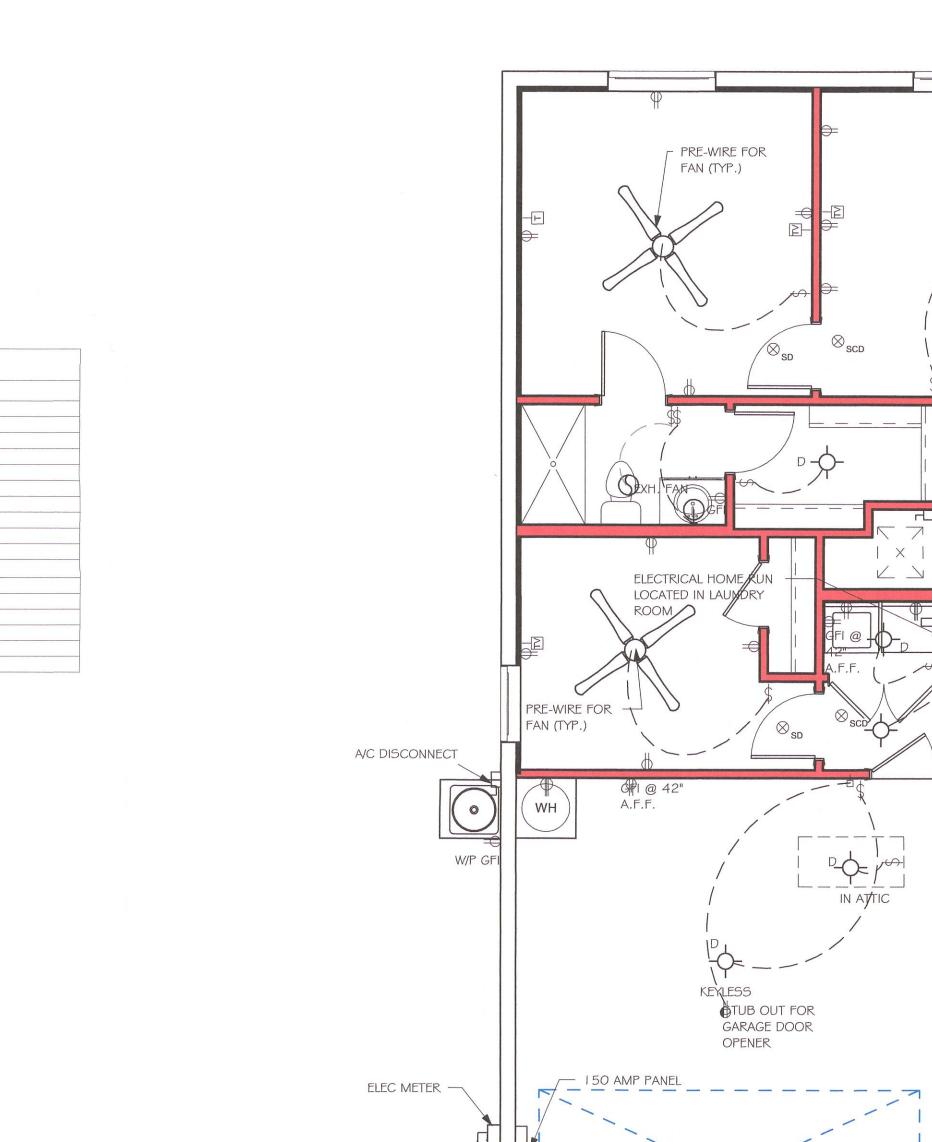

COACH LIGHT

ELECTRICAL PLAN 1/4" = 1'-0"

NOTE: VERIFY — LOCATION OF GFI PER DECO BANDING

PRE-WIRE FOR FAN (TYP.)

UNDER CAB

PRE-WIRE FOR FAN (TYP.)

PRE-WIRE FOR FAN (TYP.)



REVISION

JUL 0 2 2021

RESUBMIT

No.	Description	Date 05/10/21	
	REMOVED ALL TILE ROOF REFERENCES		

DESIGN IN ACCORDANCE WITH THE RESIDENTIAL FLORIDA BUILDING CODE 2020 - 7TH EDITION

#

DRAWN BY:

CHECKED BY:

REVISED:

PLAN:

SCALE:


05/10/21

ELECTRICAL


As indicated

01/07/21


JSL

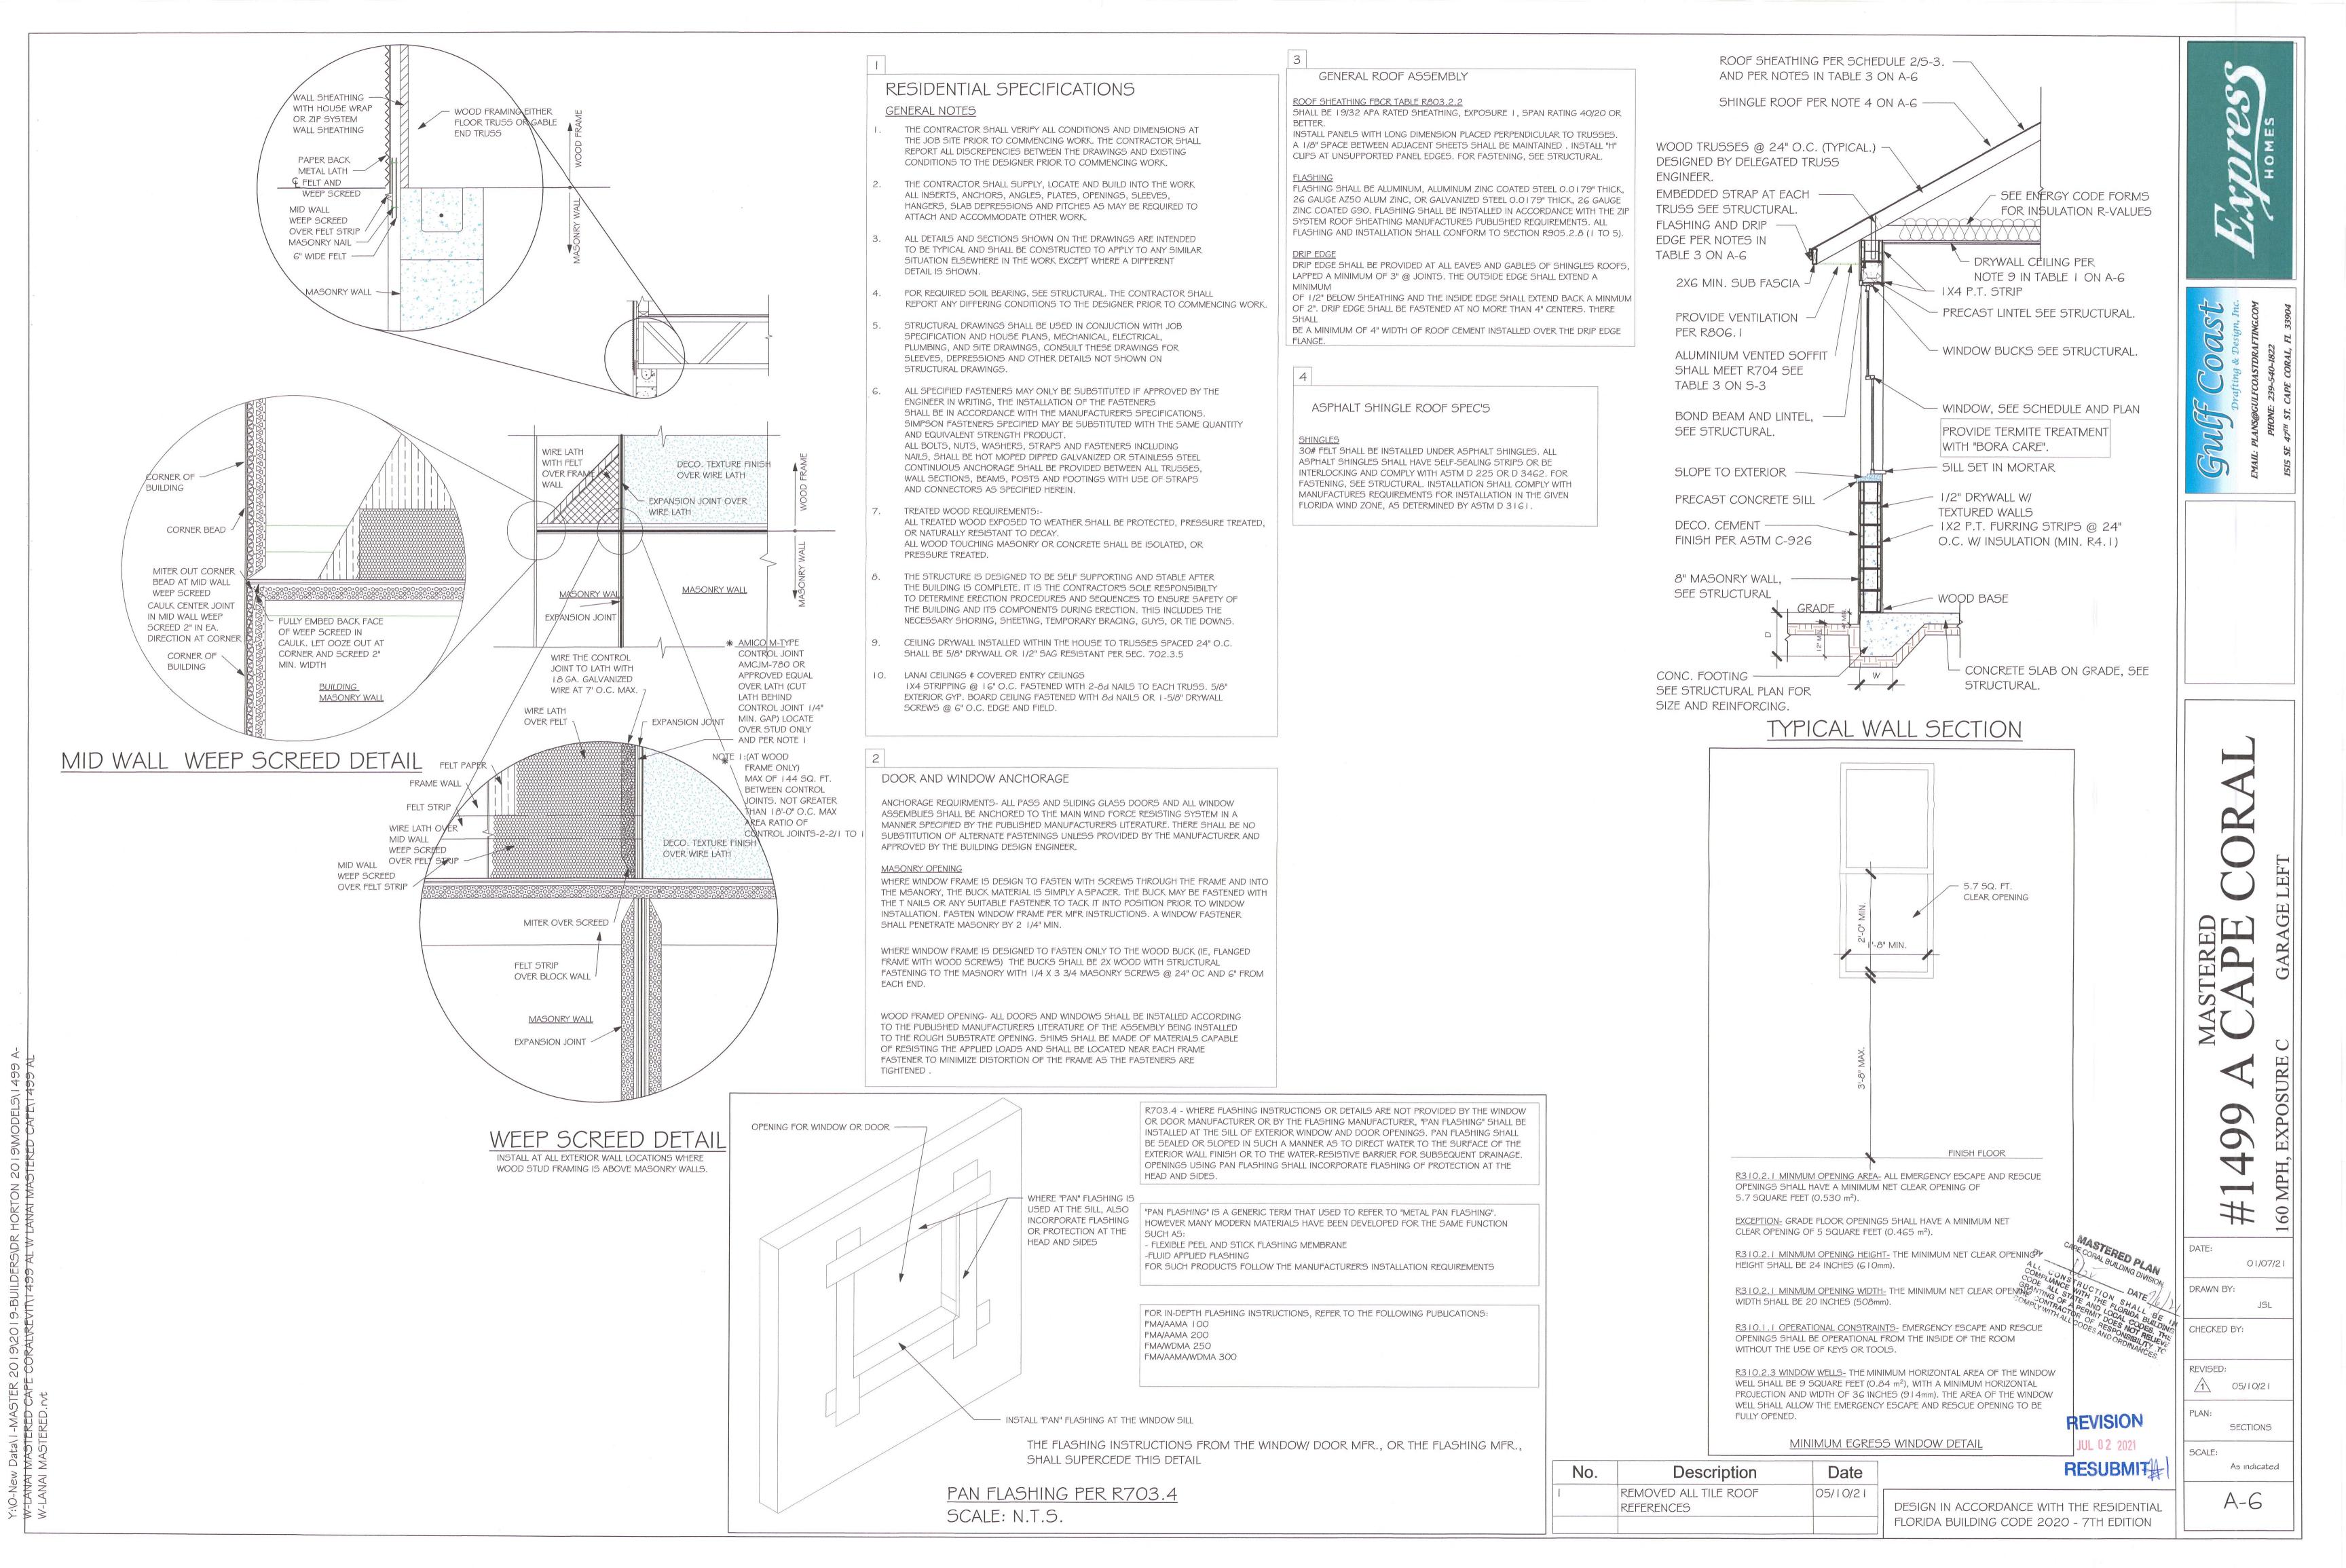

||F3|| FOOTING || 1/2|| = 1'-0||

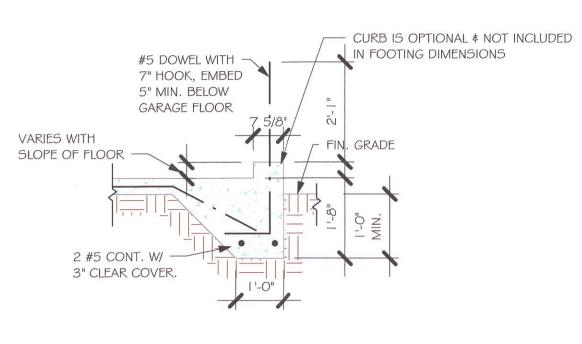


 $\frac{\text{"F3" WITH CURB AT GARAGE}}{1/2\text{"} = 1\text{'-0"}}$

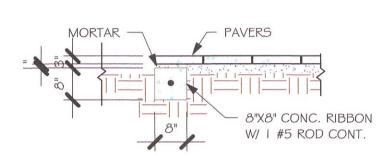


"P" PAVERS DETAIL ENTRY/ LANAII

1/2" = 1'-0"

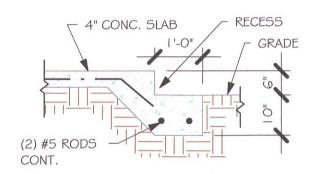

GARAGE DOOR RECESS 1/2" = 1'-0"

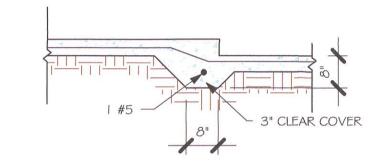

 $\frac{\text{"F6A" STEP DOWN}}{1/2\text{"} = 1\text{'-0"}}$

	PAD FOOTING SCHEDULE								
	TYPE	LENGTH	WIDTH	DEPTH	BOTTOM REINF.		DEMARKS		
מפנת					LONG WAY	SHORT WAY	REMARKS		
\langle	$\langle \mathbf{A} \rangle$	2'-6"	2'-6"	1'-0"	3-#5	3-#5	-		
	B	3'-0"	3'-0"	1'-0"	4-#5	4-#5	-		
T	(c)	3'-6"	3'-6"	1'-0"	4-#5	4-#5	-		
	D	4'-0"	4'-0"	1'-2"	5-#5	5-#5	-		
T	(E)	5'-0"	5'-0"	1'-2"	6-#5	6-#5			


	WALL FOOTING SCHEDULE						
USED	TYPE	LENGTH	WIDTH	DEPTH	BOTTOM REINFORCING	SHAPE	
	F1	CONT.	1'-4"	0'-8"	2-#5	Ц	
	F2	CONT.	1'-8"	0'-10"	2-#5		
X	F3	CONT.	1'-0"	1'-8"	2-#5		ADD CURB TO GARAGE, SEE DETAIL
	F4	CONT.	1'-4"	1'-8"	2-#5		DETAIL
	F5	CONT.	1'-4"	1'-0"	2-#5		
505765	F6	CONT.	1'-4"	1'-0"	2-#5		
X	F6A	CONT.	0'-8"	0'-8"	1-#5		
	TE	CONT.	0'-8"	0'-8"	1-#5	5	

PROVIDE CORNER BARS PER 6/5-3

FOL	JNDATION PLAN				
SCALE: 3/16" = 1'-0"					
PLAN I	NOTES:				
1.	TOP OF GROUND FLOOR SLAB DATUM ELEVATION 0'-0"				
2.	"F#" DENOTES CONTINUOUS WALL FOOTING TYPE PER SCHEDULE THIS SHEET.				
3.	(#) DENOTES PAD FOOTING AT CONCENTRATED LOADS PER SCHEDULE THIS SHEET.				
4.	PROVIDE #5 VERTICAL REINFORCING AT DOT LOCATIONS SHOWN ON PLAN FROM FOOTI				
	TO BOND BEAM.				
5.	ALL DIMENSIONS ARE TO OUTSIDE FACE OF MASONRY WALLS. SOME SLAB EDGES MAY				
	EXTEND BEYOND FACE OF WALL.				

PROVIDE PRESSURE TREATED BUCKS AT WINDOWS/ DOORS PER DETAIL 7/S-3.

FOR DIMENSIONS OF ROUGH OPENINGS IN MASONRY WALLS, COORDINATE WITH WINDOW/

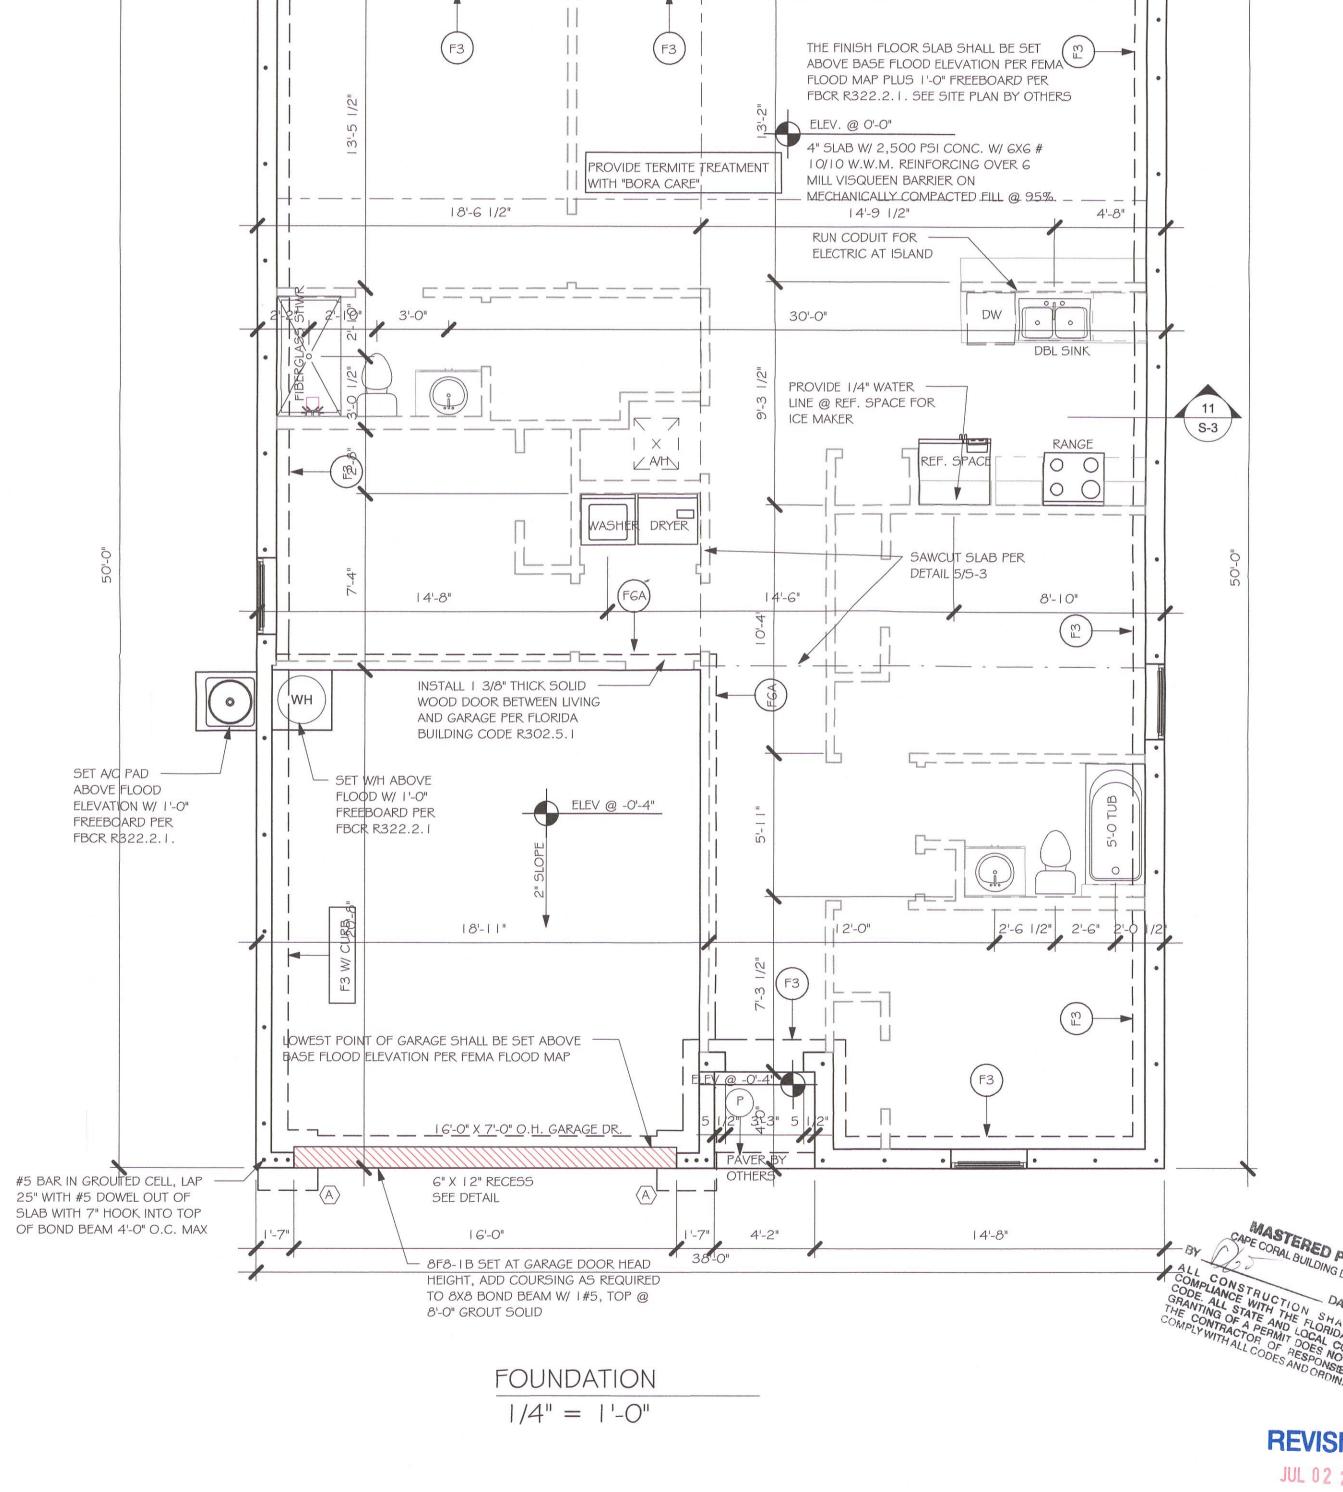

38'-0"

STANDARD SGD RECESS 1-1/2". IMPACT — GLASS SGD RECESS 2-1/2".

10'-0"

PAVER BY OTHERS

28'-0"

29'-3"

No. Description Date

REMOVED ALL TILE ROOF
REFERENCES 05/10/21

DESIGN IN ACCORDANCE WITH THE RESIDENTIAL FLORIDA BUILDING CODE 2020 - 7TH EDITION

REVISION
JUL 0.2 2021
RESUBMIT

ting & Design, Inc.
COASTDRAFTING.COM
F-540-1822
E CORAL, FL 33904

Drafting & Design, Inc Drafting & Design, Inc EMAIL: PLANS@GUIFCOASTDRAFTING.COM PHONE: 239-540-1822 1515 SE 47" ST. CAPE CORAL, FL 33904

other disciplines such its architectural, inc. lite safety, accessibility, energy, site work, civil, or geotechnical.

STRUCTURAL ENGINEERING

STRUCTURAL ENGINEERING

STRUCTURAL ENGINEERING

SYSTIENS

OF NORTH FLORIDA

1654 SE 47th ST SUITE #3

CAPE CORAL, FL 33904

CAPE CORAL, FL 33904

CAPE CORAL, FL 33904

CAPE COR

#1499 A

DRAWN BY:

JSL

CHECKED BY:

01/07/21

REVISED: 05/10/21


PLAN: FOUNDATION PLAN


SCALE:
As indicated

5-1

- PROVIDE A STRAP FROM THE ABOVE LIST AT EACH ROOF TRUSS BEARING POINT, BASED ON THE TRUSS UPLIFT VALUES IN THE SIGNED AND SEALED TRUSS DESIGN PACKAGE AND
- SUITABLE FOR THE GEOMETRY. EMBED STRAP ON -C OF WALL. CONNECTORS ARE SIMPSON STRUCTURAL CONNECTORS. ALL CONNECTORS SHALL BE INSTALLED IN STRICT ACCORDANCE WITH SIMPSON PRINTED INSTUCTIONS.
- SUBSTITUTIONS MUST BE APPROVED IN WRITING BY THE ENGINEER OF RECORD. WHERE EMBEDDED STRAPS ARE MISSING, OR MIS-LOCATED, INSTALL RETROFIT STRAP PER

SIMPSON CATALOG C-C- 2019

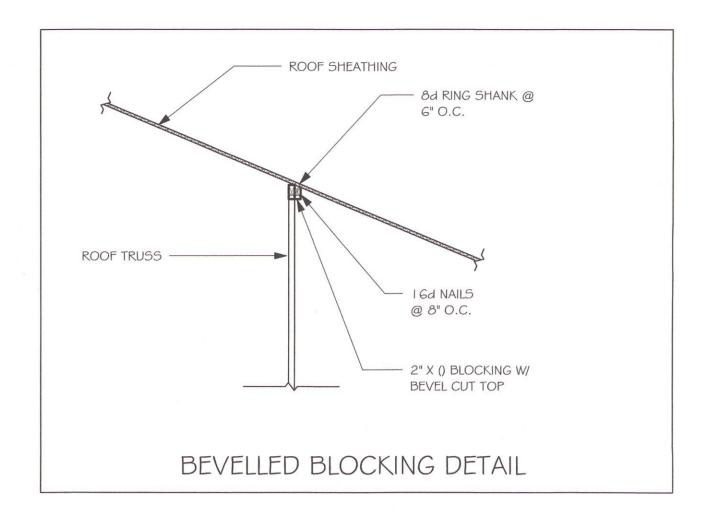

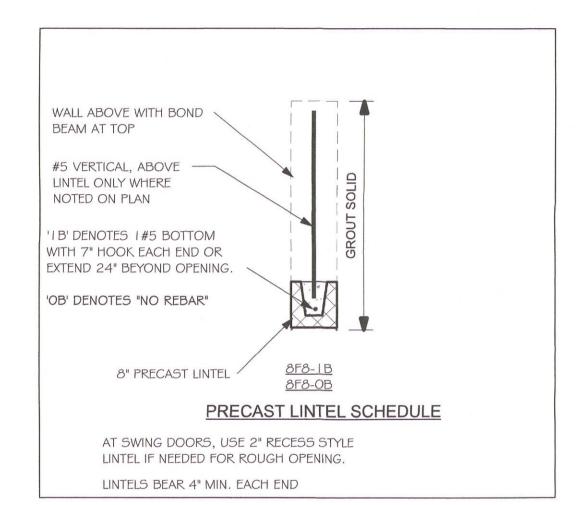

PLAN NOTES:


- ROOF TRUSS BEARING 8'-O", SEE LEGEND. ROOF FRAMING SHALL BE WOOD TRUSSES DESIGNED BYA DELEGATED TRUSS ENGINEER PER DESIGN CRITERIA ON SHEET S-3.
- PROVIDE STRAPPING AT TRUSSES PER NOTES ON THIS
- FOR NAILING OF ROOF AND FLOOR DECK, SEE I AND 2
- 8F8-1B etc., DENOTES PRECAST LINTEL ABOVE
- DOOR/WINDOW OPENING PER SCHEDULE THIS SHEET. AT TRUSS BEARING, PROVIDE 8x8 MASONRY BOND

BEAM W/ I #5 CONTINUOUS, SEE DETAIL I I/S-3.

BEARING HEIGHT

= BEARING @ 8'-0"

TRUSS BEARING CONDITIONS AND STRAPPING IS BASED ON TRUSS LAYOUT PREPARED BY SCOSTA JOB# DR I 499L DATED: 11/30/20 REVISED: NONE

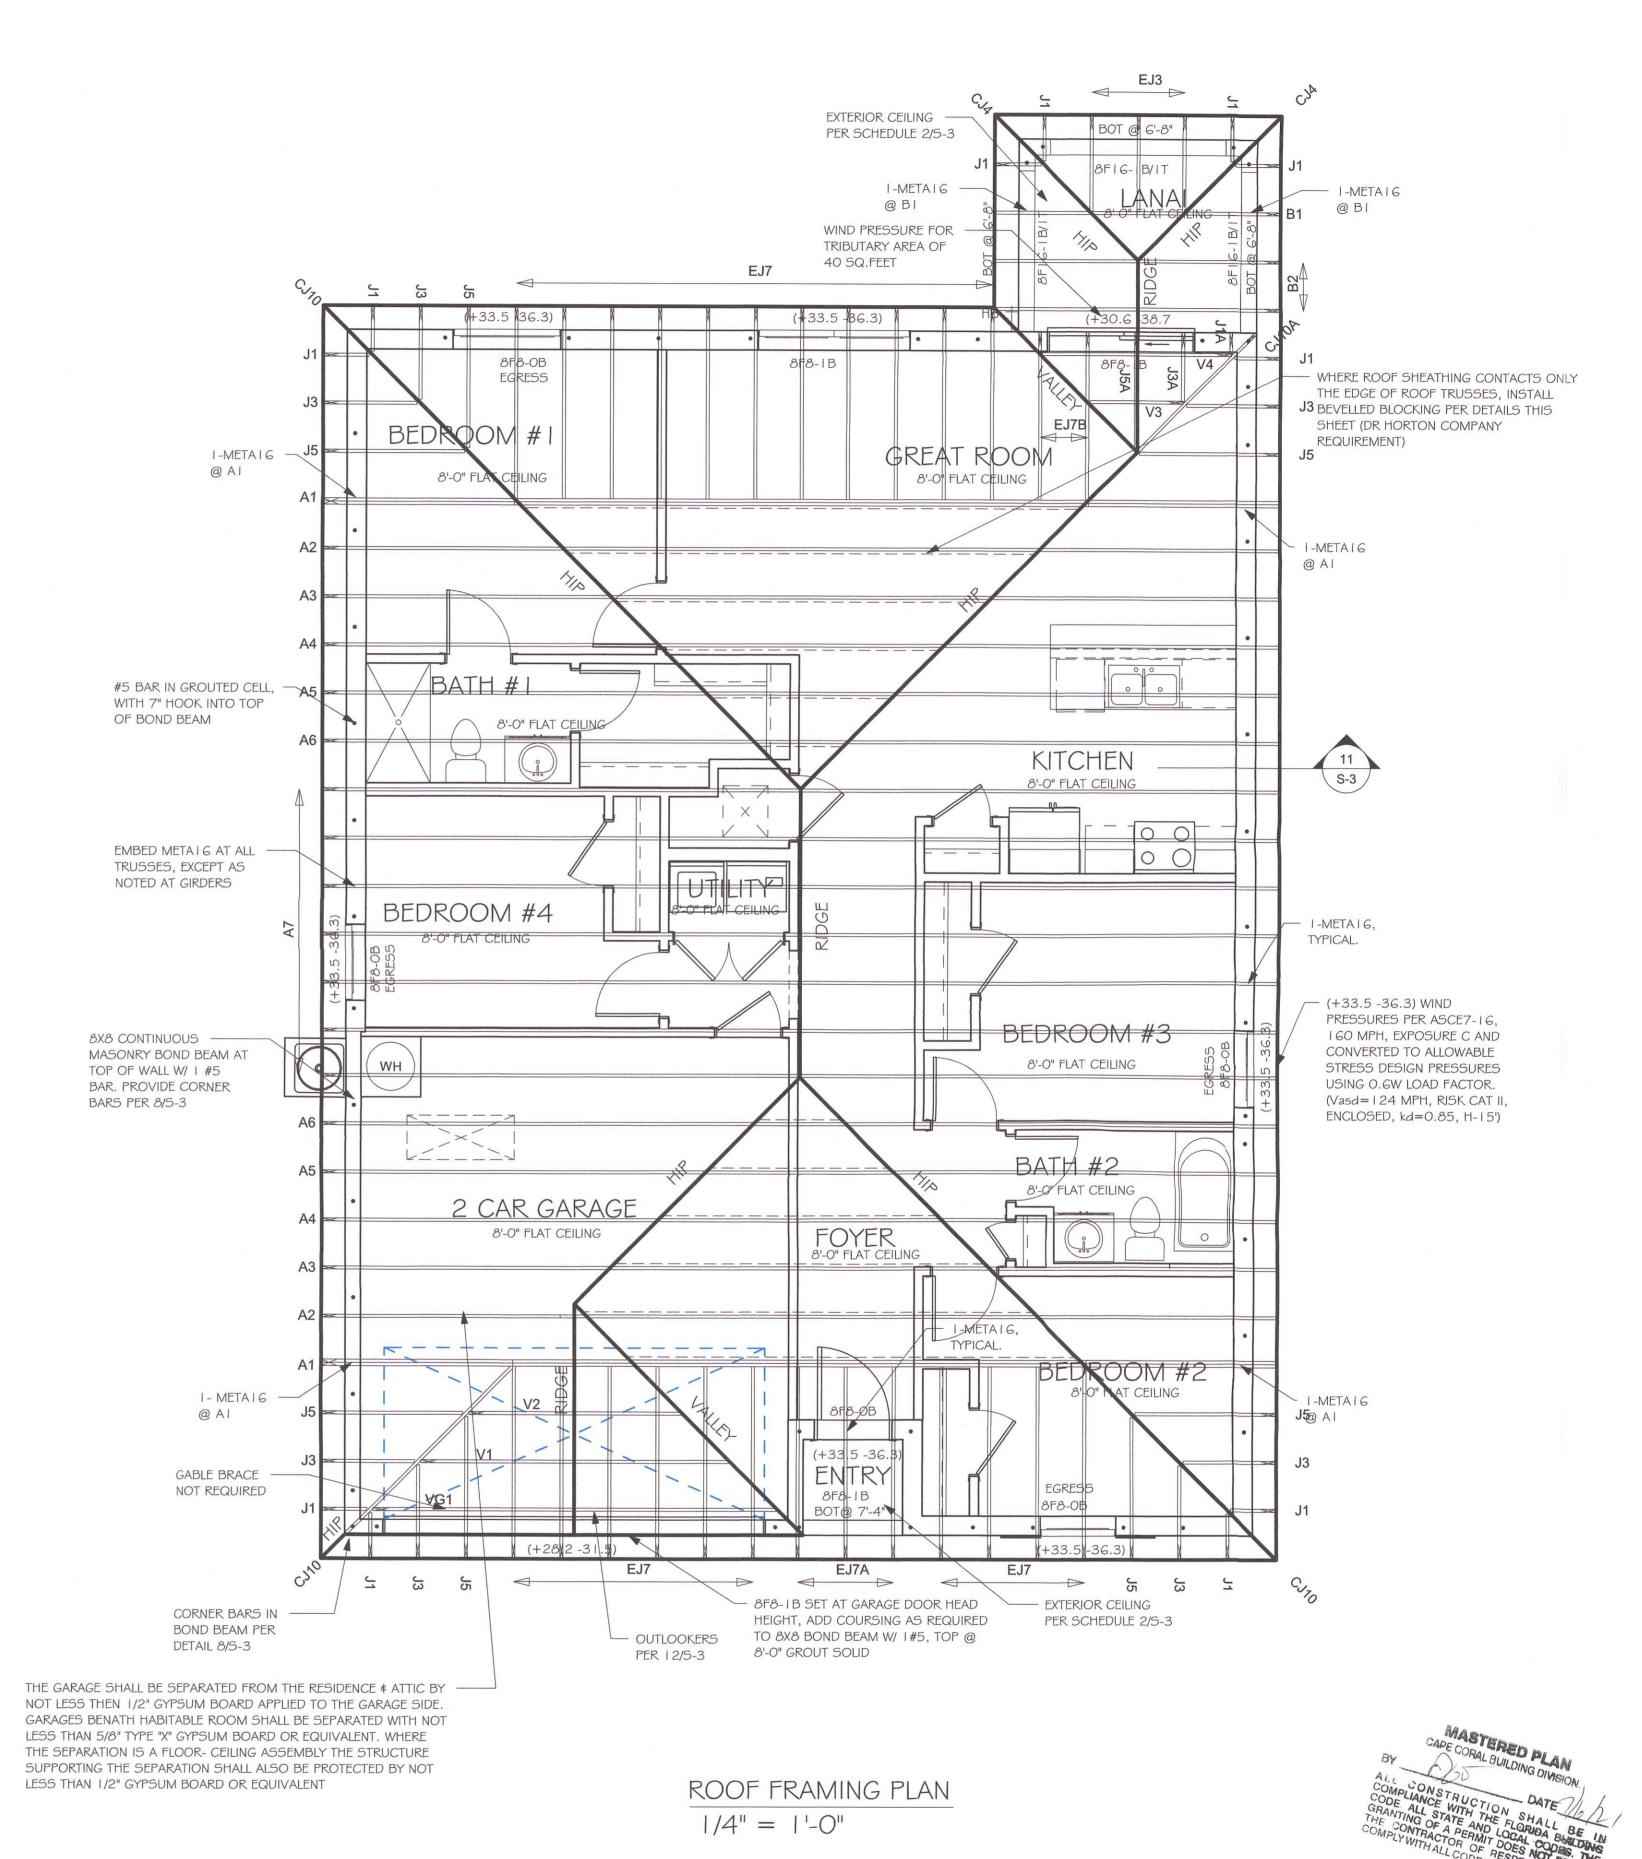

No. Description Date REMOVED ALL TILE ROOF 05/10/21 REFERENCES

DESIGN IN ACCORDANCE WITH THE RESIDENTIAL FLORIDA BUILDING CODE 2020 - 7TH EDITION

REVISION JUL 0 2 2021 RESUBMIT#

01/07/21 DRAWN BY:


JSL CHECKED BY:

REVISED: 05/10/21

PLAN:

ROOF FRAMING PLAN SCALE:

As indicated

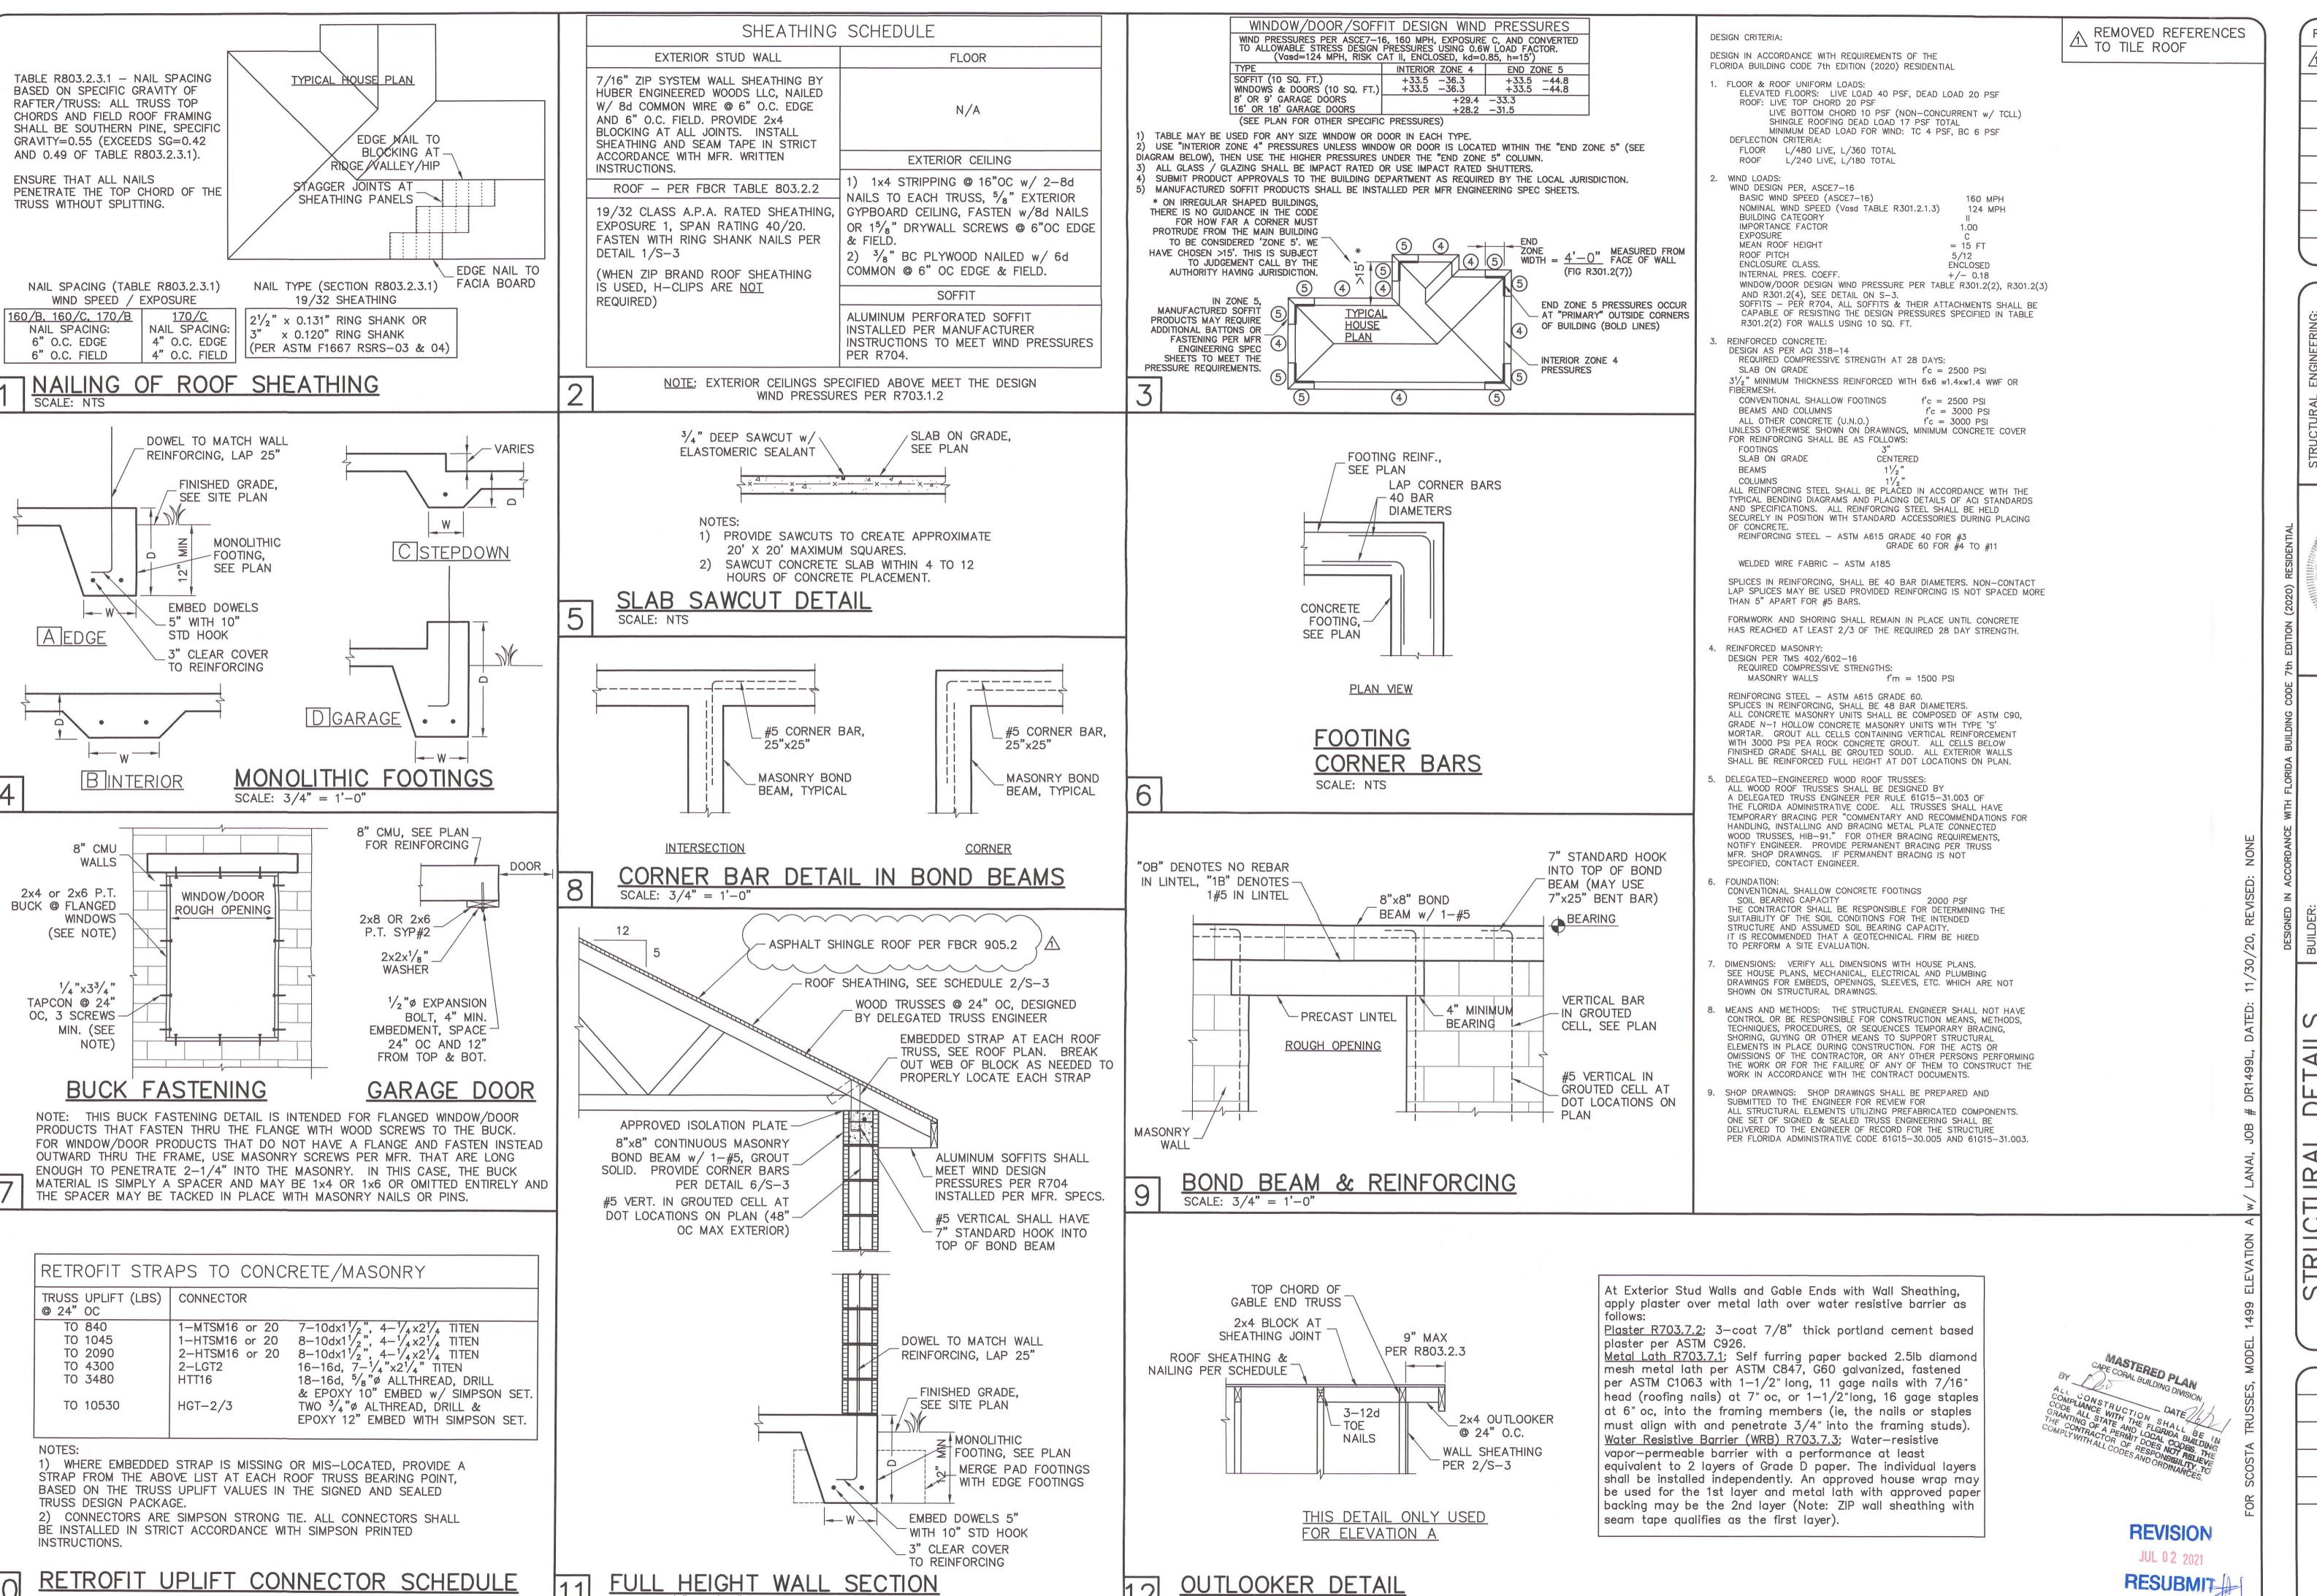

REVISIONS <u>/1</u>\ 05/07/21|

ORTON

D-R-H

ら出 \cdot \vdash \cong DET GAR ERMI OSUI UCTUI 1498 AASTE MPH, _ _ 0 ST 9

> DESIGN/DRAWN DWB/DWB CHECKED DWB DATE 01/15/21 SCALE

> **VARIES** JOB NO. DR 12292 SHEET

SHEET 3 OF 3