


Engineer of Record for the Structure Structural Systems of N. Fl, Inc. Raul Reyes, PE 88925 1634 SE 47th Street #3 Cape Coral, FL 33904


This document has been reviewed for conformance with the design intent of the structure and specified design criteria.

	-	_
Accepted As-Is		Revise and Resubmit

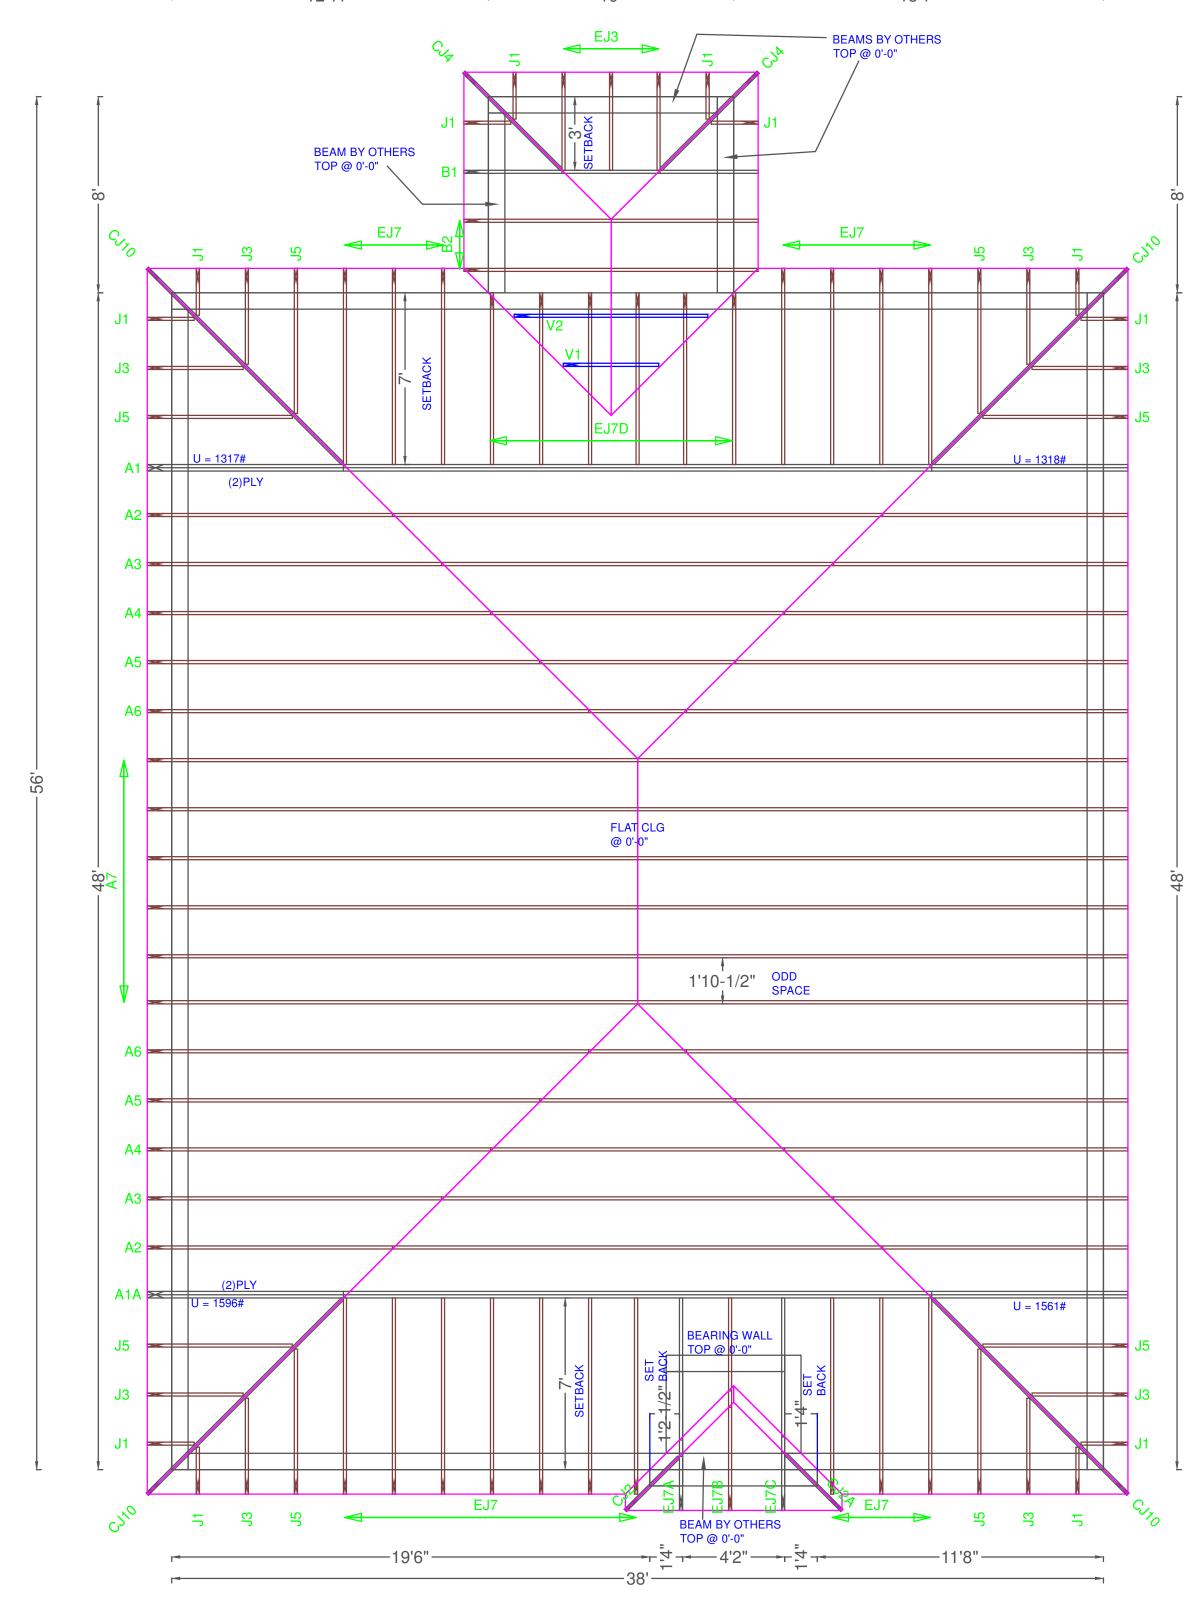

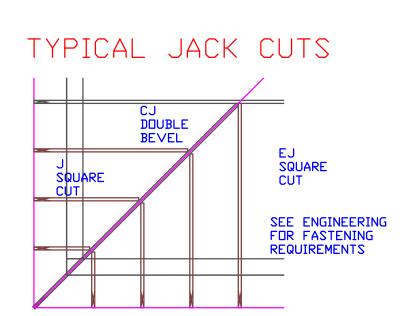

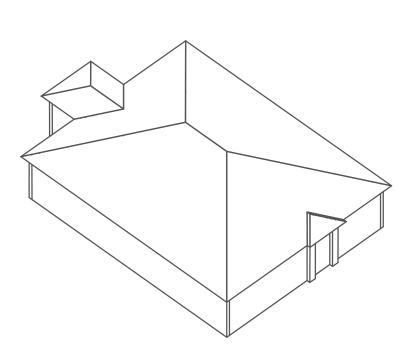

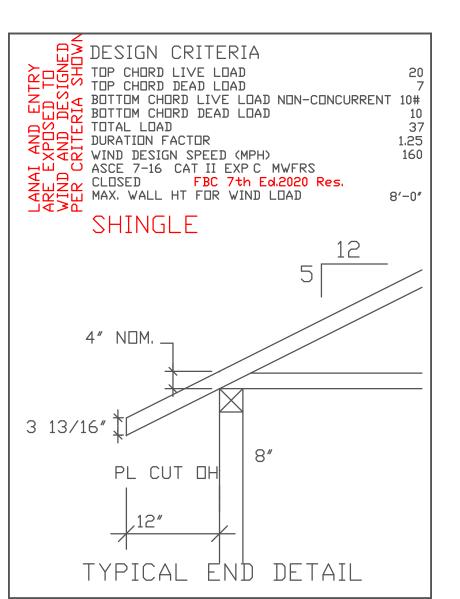

UNLESS NOTED

REACTION VALUES ARE UNDER 5000# UPLIFT VALUES ARE UNDER 1000#

ALL TRUSSES 24"o.c. UNLESS NOTED OTHERWISE

********* DO NOT ATTEMPT TO ERECT TRUSSES WITH-DUT REFERRING TO THE ENGINEERING DWGS.

IT IS NECESSARY TO REFER TO THE ENGINEERING DRAWINGS FOR NUMBER OF MEMBERS, BEARING LOCATION, DRIENTATION AND WEB BRACING

REFER TO WTCA/TPI BSCI-B1 SUMMARY SHEET FOR HANDLING METHODS & TEMPORARY BRACING, WHICH IS ALWAYS REQUIRED BEARING HEIGHTS BASED ON PLANS PROVIDED TO SCOSTA CORP. "+/-" BEARING DIFFERENCES SHOWN ARE CRITICAL. IF ANY HEIGHTS DEVIATE - INFORM SCOSTA

BEARING WALL & BEAM HEIGHTS

	0'-0"	ELE
7/////		ELE
		ELE
		ELE
HARRAGARE .		ELE
		ELE
		ELE

TYPICAL HANGER SCHEDULE

- (C) SIMPSON HUS 26 (M) SIMPSON HGUS 28-3
- F SIMPSON HUS 28 N SIMPSON HHUS 48
- H SIMPSON HGUS 28 P SIMPSON LUS 24
- I SIMPSON HGUS 28-2 B SIMPSON THA 422
- (M) SIMPSON THJA26 (X)

HANGER VALUES HAVE BEEN BASED ON 16D COMMON NAILS EXCEPT THE FOLLOWING LUS24 - 10D COMMON THJA26 - 10D x 1-1/2

APPROVAL OF THIS TRUSS LAYOUT IS NECESSARY BEFORE FABRICATION CAN BEGIN. VERIFY DIMENSIONS, PITCHES, OVERHANGS, ELEVATIONS, CEILING & BEARING CONDITIONS. SCOSTA CORPORATION IS RESPONSIBLE FOR ACCURACY IN ACCORDANCE WITH PLANS AND/OR INFORMATION PROVIDED BY CUSTOMER, WITH ANY DEVIATIONS NOTED HEREIN. CUSTOMER IS RESPONSIBLE TO VERIFY ACCURACY OF INFORMATION AND PLANS PROVIDED TO SCOSTA CORPORATION, AND TO VERIFY CONFORMANCE TO FIELD CONDITIONS, AND/OR OWNER CHANGES. TRUSSES WILL BE BUILT IN ACCORDANCE WITH THE APPROVED LAYOUT.


APPROVED BY: _____

DATE: _____ REQUESTED DELIVERY DATE: JOBSITE CONTACT NAME:


PHONE #: ____ E-MAIL: _

D.R. HORTON



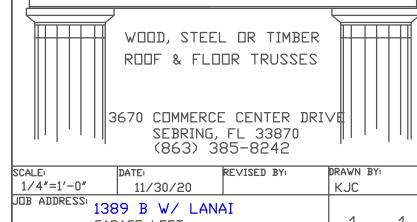


GARAGE LEFT LEE CUSTOMER: DR1389BL

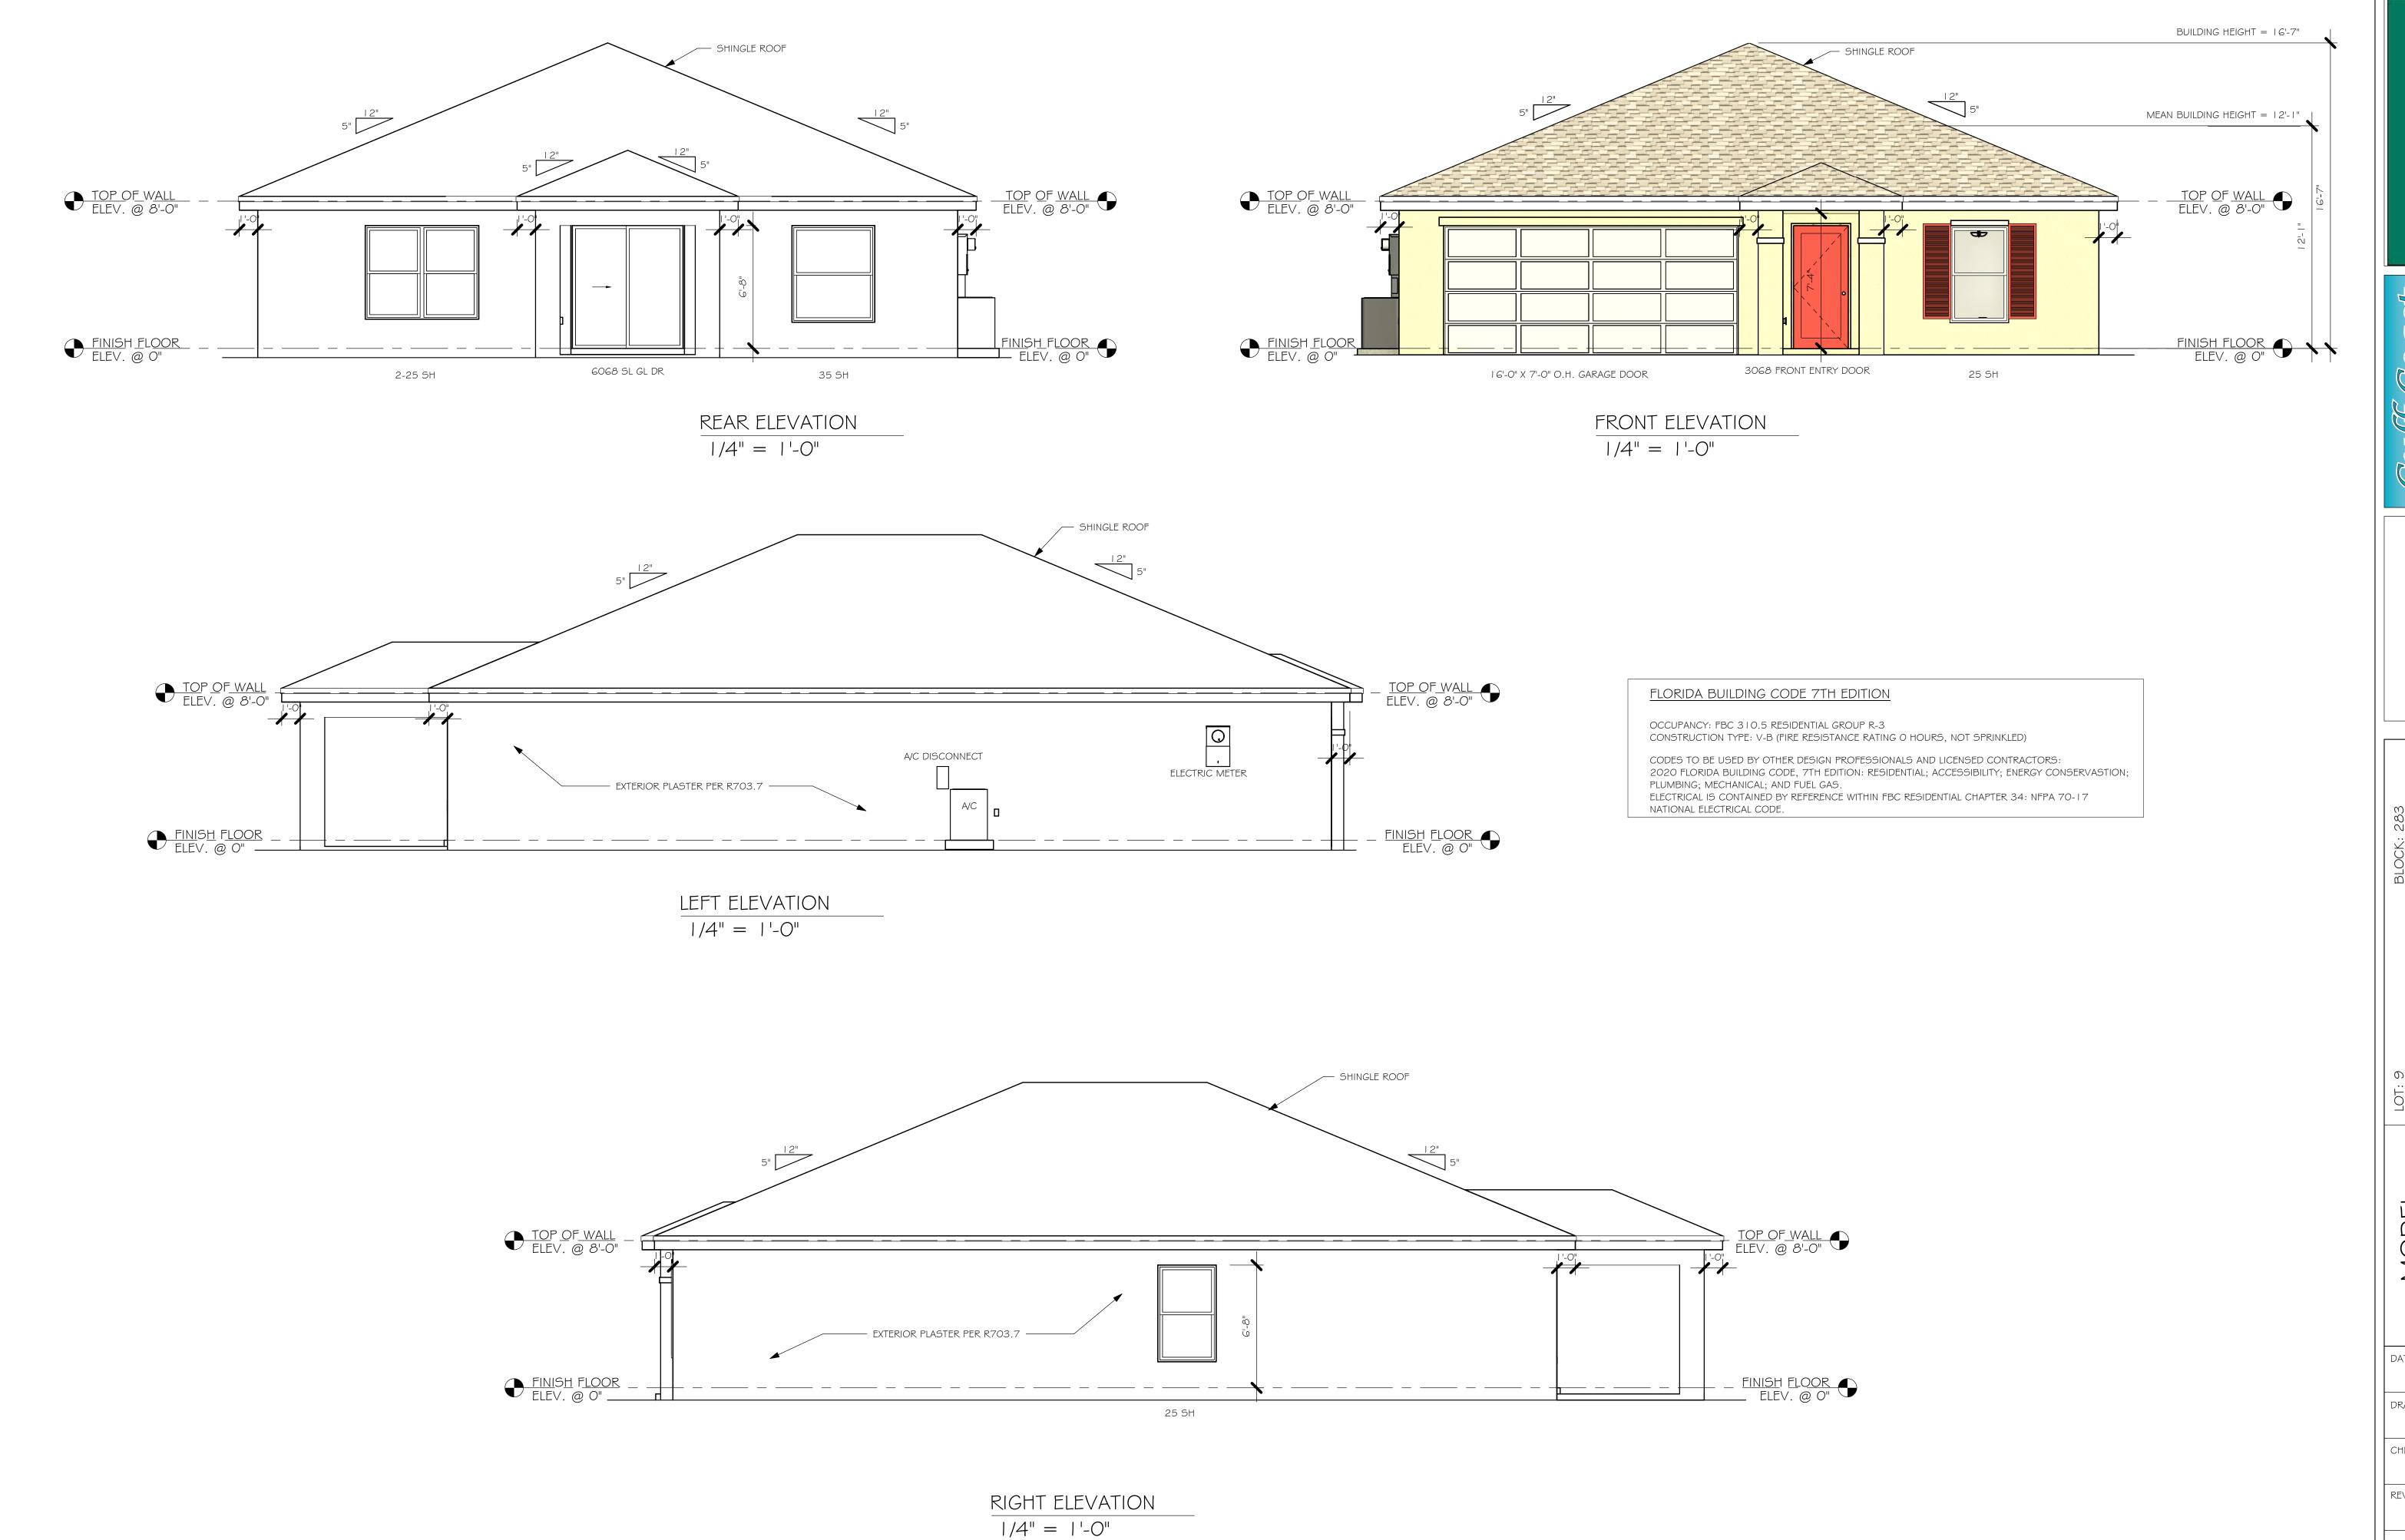

MODEL DATE: 07/30/21 DRAWN BY: CHECKED BY: REVISED: PLAN: ELEVATION SCALE: As indicated A-1


DESIGN IN ACCORDANCE WITH THE RESIDENTIAL FLORIDA BUILDING CODE 2020 - 7TH EDITION

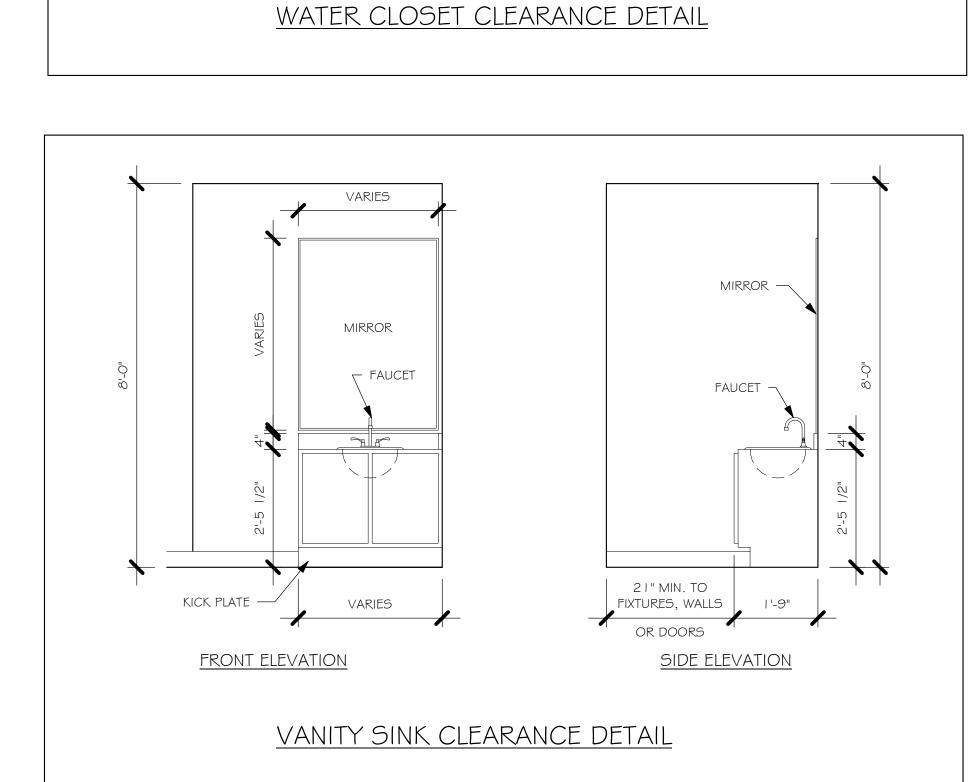


FRONT ELEVATION


36" MAX.

SIDE ELEVATION

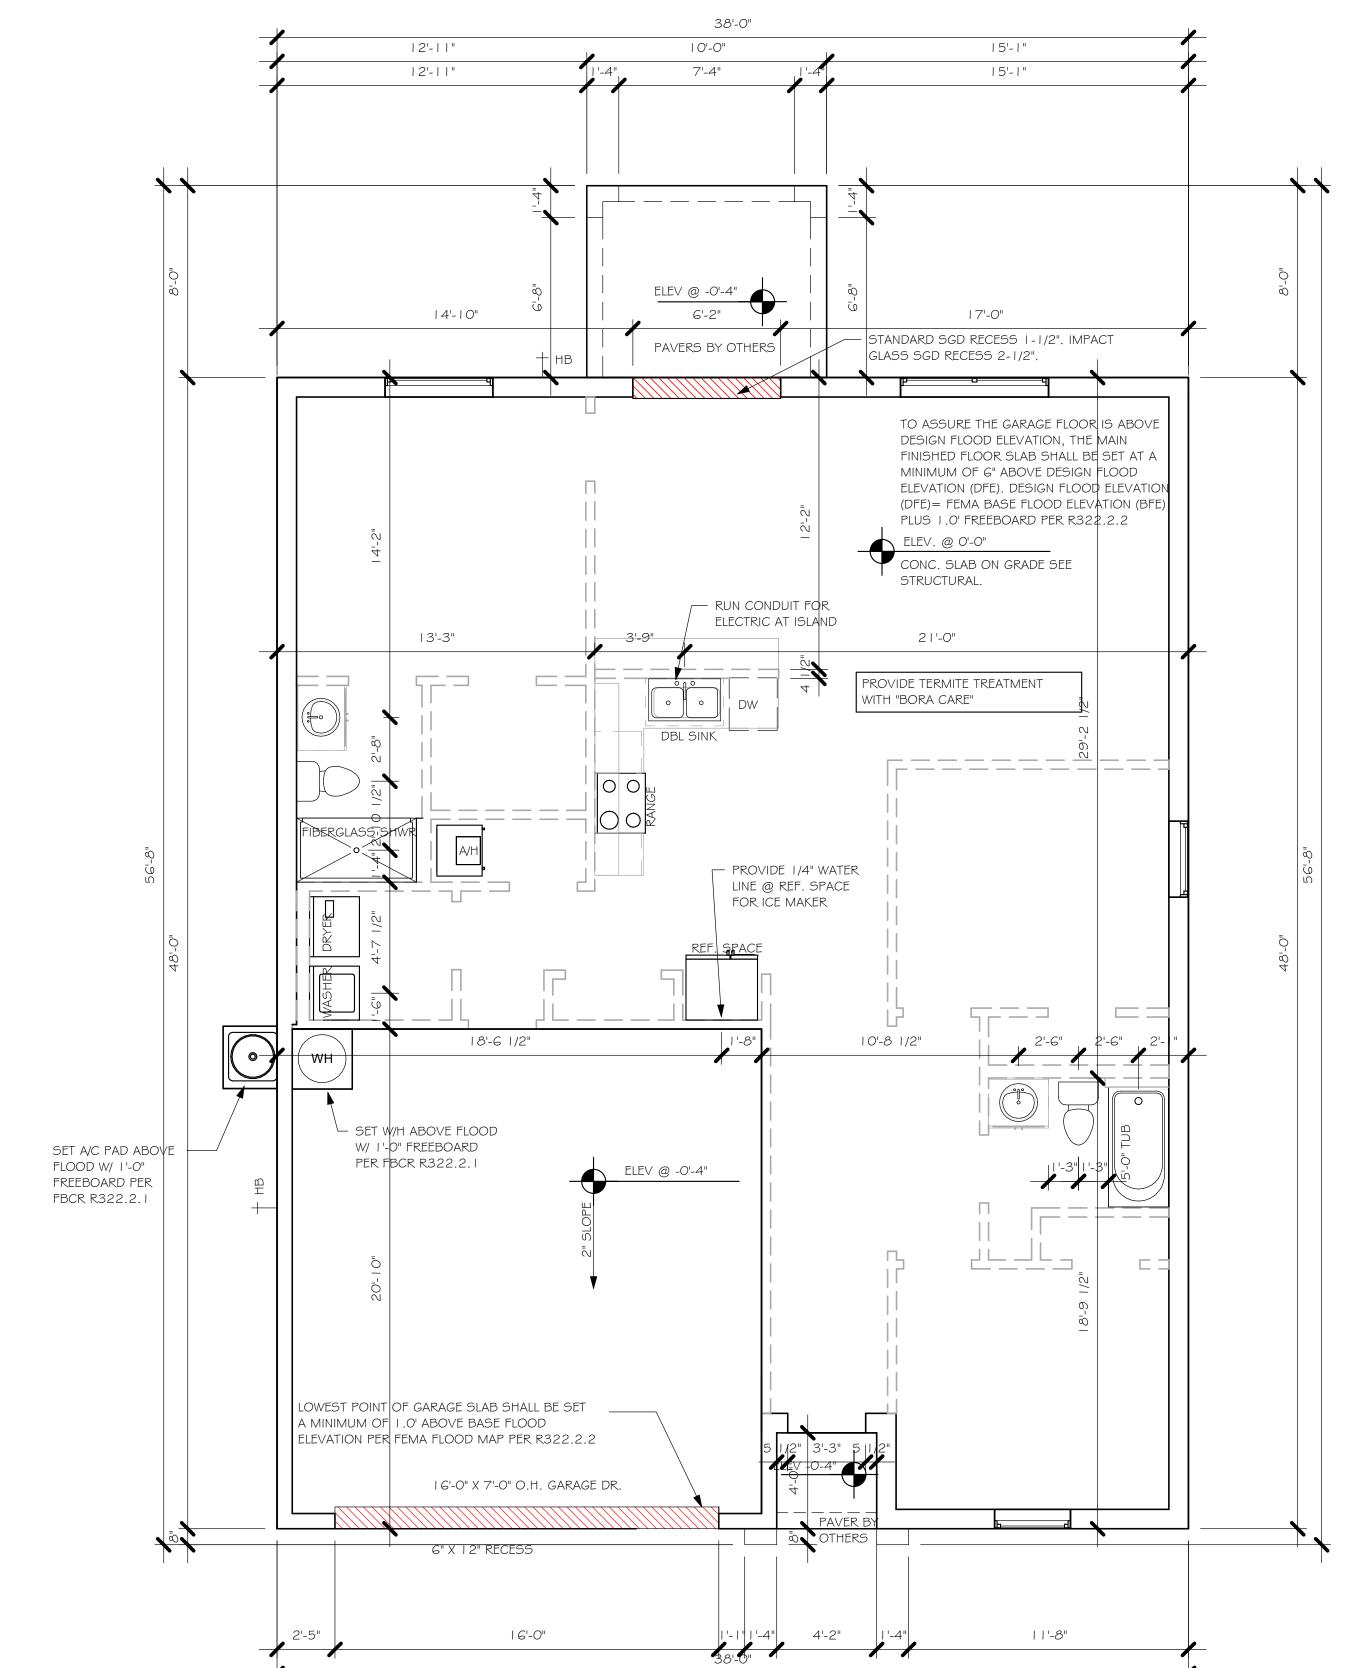

 $\frac{\text{SLAB } \text{ } \text{PLUMBING}}{1/4" = 1'-0"}$

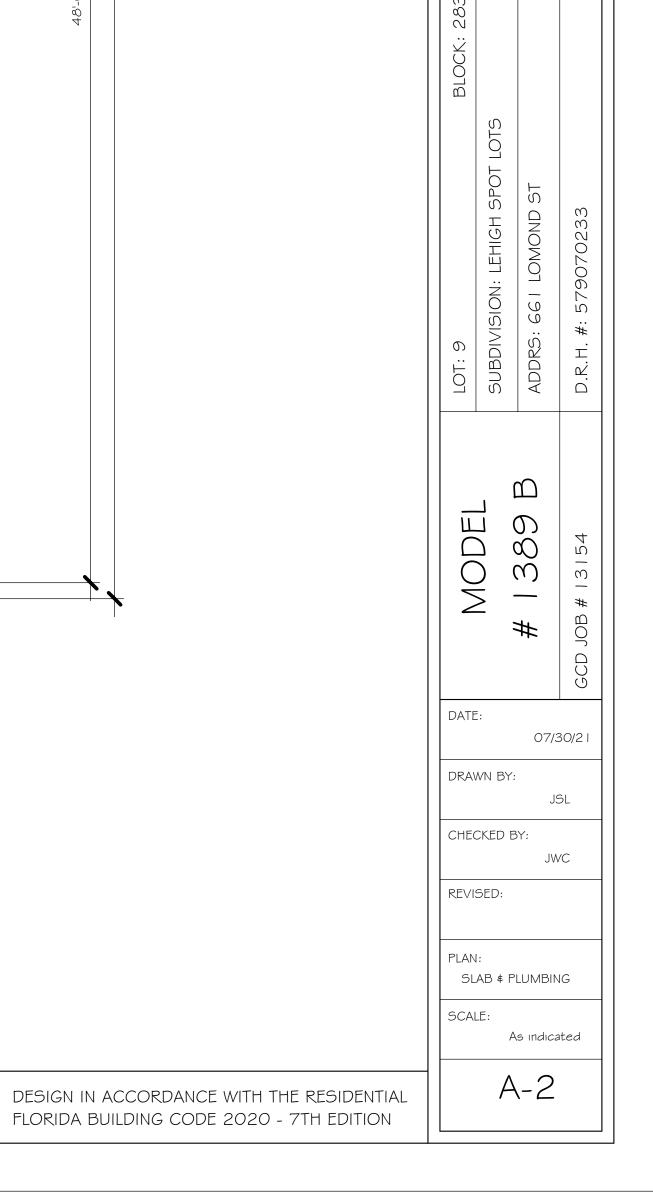

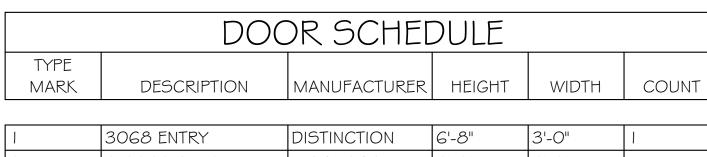

1	3068 ENTRY	DISTINCTION	6'-8"	3'-0"	1
2	2-3068 SL. GL. DR.	DISTINCTION	6'-8"	6'-0"	1
3	16070 OHGD	GARAGE DOOR	7'-0"	16'-0"	1

5'-5"

5'-5"

4'-8"

WINDOW SCHEDULE									
MARK	DESCRIPTION	MANUFACTURER	HEIGHT	WIDTH	COUNT				
А	2-25 SH		5'-3"	6'-4"					

D	OOR HEADE	RS
6'-8" BI-FOLD	HEADER HEIGHT	82" A.F.F.
6'-8" SWING	HEADER HEIGHT	82 I/2" A.F.F.
8'-0" SWING	HEADER HEIGHT	98 I/2" A.F.F.

PLAN NOTES

VERIFY ALL ROUGH OPENING DIMENSIONS FOR ALL WINDOWS AND DOORS

25 SH

35 SH

- PROVIDE SAFETY GLAZING WITHIN 24" FROM EXIT PER FLORIDA BUILDING CODE R 308.4.2.
- PROVIDE SAFETY GLAZING AT BATH/ SHOWER PER FLORIDA BUILDING CODE R 308.4.5.
- NON BEARING INTERIOR FRAME WALLS SHALL BE FRAMED W/ WOOD OR METAL STUDS. SPACING SHALL NOT EXCEED 24" O.C. (NON BEARING WALLS ONLY)
- PROVIDE DEAD WOOD IN ATTIC FOR OVERHEAD GARAGE DOOR HARDWARE
- KITCHEN KNEE WALL TO BE FRAMED W/ TOP @ 34 I/2" A.F.F.
- INSTALL SMOOTH WALLS IN KITCHEN AND ALL

RESISTANT PER SEC. R702.3.5

BATHROOM AREAS

R302.5.1,

- WHERE DRYWALL CEILING IS APPLIED TO TRUSSES @ 24" O.C. USE 5/8" DRYWALL OR 1/2" SAG
- THE GARAGE SHALL BE SEPARATED FROM THE RESIDENCE & ATTIC BY NOT LESS THEN 1/2" GYPSUM BOARD APPLIED TO THE GARAGE SIDE. GARAGES BENEATH HABITABLE ROOMS SHALL BE SEPARATED WITH NOT LESS THAN 5/8" TYPE "X" GYPSUM BOARD OR EQUIVALENT. WHERE THE SEPARATIION IS A FLOOR - CEILING ASSEMBLY, THE STRUCTURE SUPPORTING THE SEPARTION SHALL ALSO BE PROTECTED BY NOT LESS THAN 1/2" GYPSOM BOARD OR EQUIVALENT
- 10) INSTALL 1 3/8" THICK SOLID WOOD DOOR BETWEEN LIVING AND GARAGE PER FLORIDA BUILDING CODE
- II) ALL WINDOWS INSTALLED 72" ABOVE GRADE MUST COMPLY WITH R3 | 2.2 MIN 24" SILL HEIGHT OR PROVIDED WITH AN APPROVED WINDOW FALL PREVENTION DEVICE
- 12) ALL CLOSET SHELVES TO BE 12". ALL PANTRY \$ LINEN TO BE (4)-16" SHELVES 18" O.F.F. W/ 15" INCREMENT.
- 13) ALL MECHANICAL AND ELECTRICAL EQIUPMENT TO BE INSTALLED AT OR ABOVE FLOOD PLUS 1'-0" FREEBOARD.

TYPICAL DIMENSION STRING


IN.	INTERIOR DOOR SCHEDULE								
MARK	DOOR WIDTH	NOTES							
	3'-0"	P.K. = POCKET DOOR							
2	2'-8"	B.F. = BI-FOLD DOOR							
3	2'-6"	D.1 DI-1 OLD DOOK							
4	2'-4"	B.P. = BI-PASS DOOR							
5	2'-0"	L.V. = LOUVERED DOOI							
6	1'-8"								
7	1'-6"								
8	2'-11"								

SQUARE FOOTAGE					
LIVING AREA	1,389				
GARAGE AREA	419				
LANAI AREA	80				
FRONT PORCH/ ENTRY AREA	16				
TOTAL SQUARE FOOTAGE	1,904				

CABINET BACKING			
KITCHEN	UPPER TOP @ 84"	BASE TOP @ 35"	
MASTER BATH	UPPER	BASE TOP @ 35"	
GUEST BATH	UPPER	BASE TOP @ 31"	
LAUNDRY ROOM	UPPER TOP @ 84"	BASE	

IB	TOWEL BAR	ALL TUB DECKS @ 21" A.F.F
TP	TOILET PAPER	ALL BLOCKING TO BE PT IN SHOWERS
	4.0"	TOWEL BAR TOILET PAPER ROLL

BATHROOM NOTES

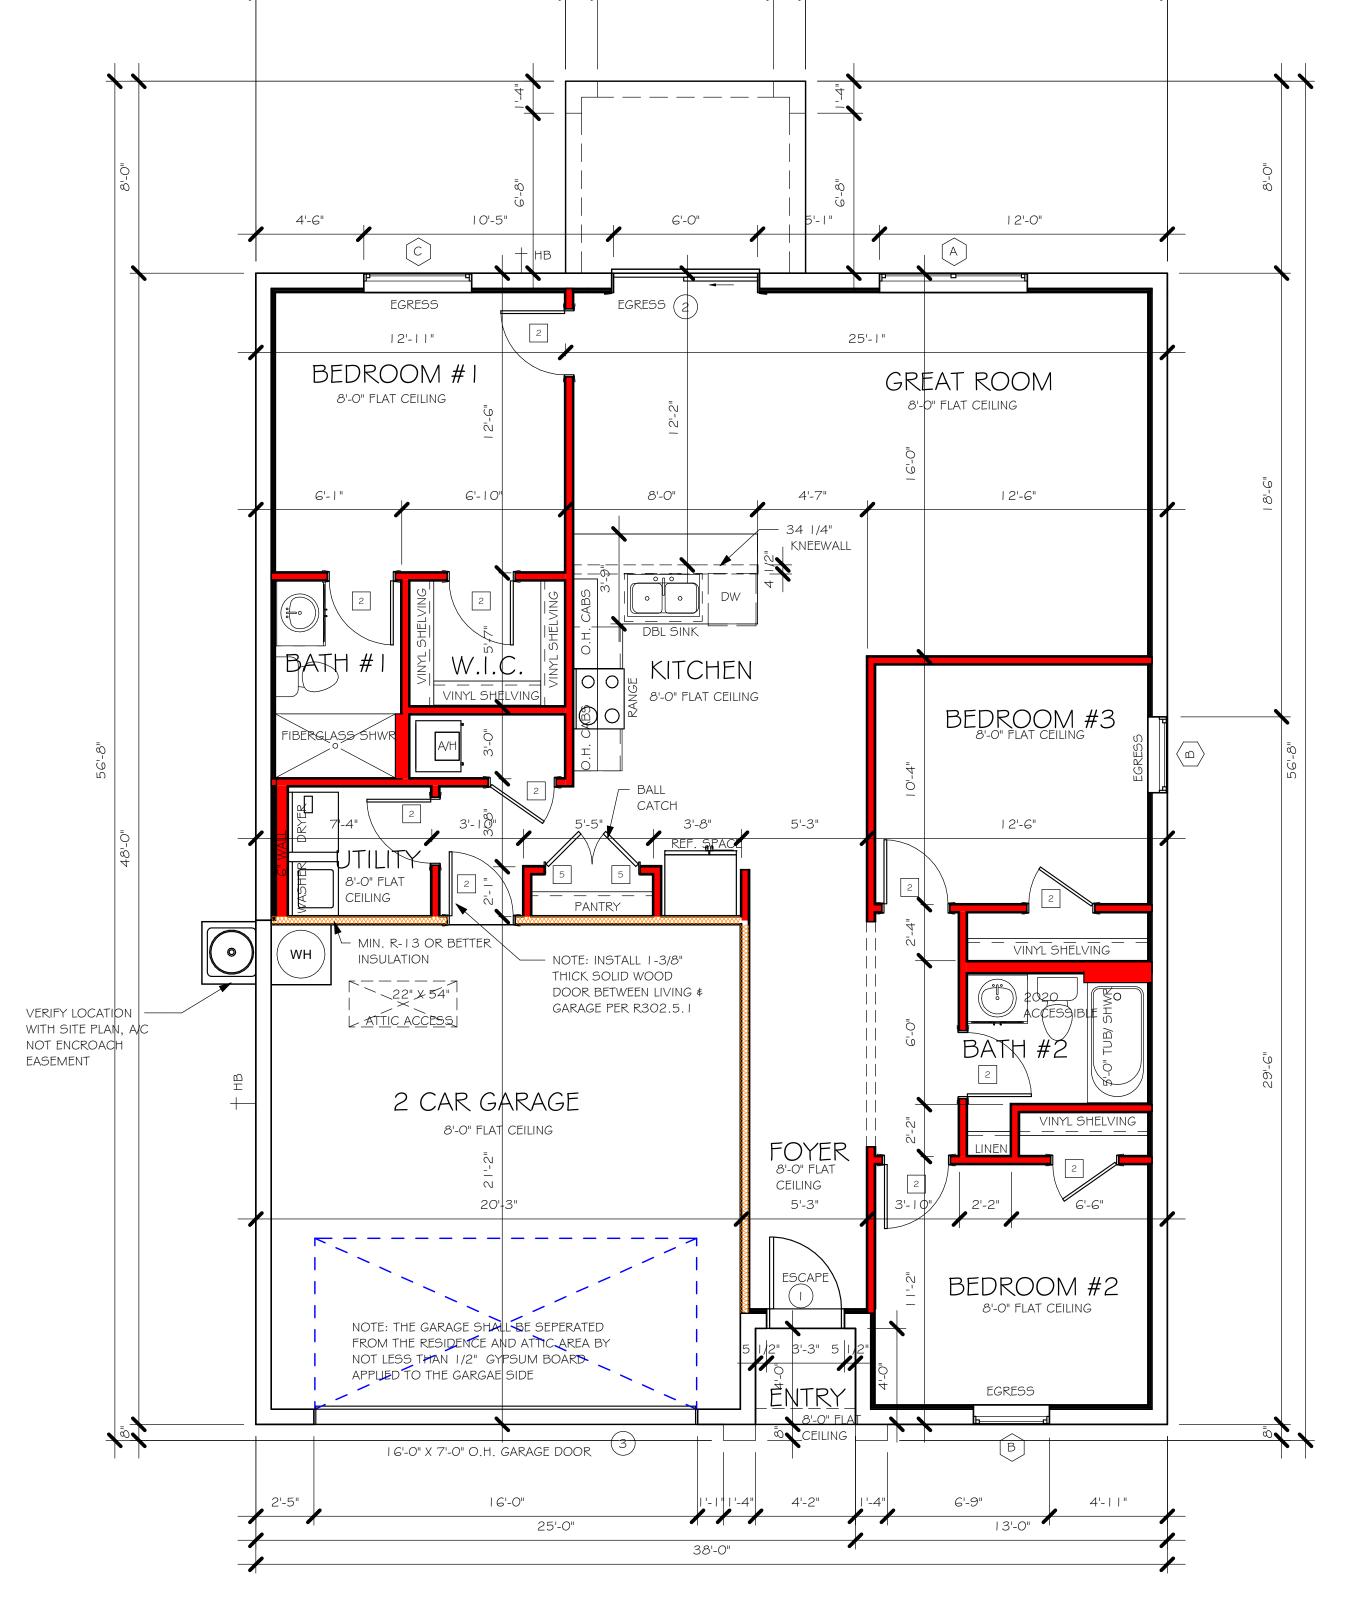

38'-0"

15'-1"

15'-1"

10'-0"

7'-4"

12'-11"

12'-11"

FLOOR PLAN $\frac{1}{4} = 1'-0''$

FACE OF EXTERIOR WALL —

DESIGN IN ACCORDANCE WITH THE RESIDENTIAL FLORIDA BUILDING CODE 2020 - 7TH EDITION

DATE:

DRAWN BY:

CHECKED BY:

REVISED:

SCALE:

07/30/21

JWC

FLOOR

As indicated

MODEL

DATE:

DRAWN BY: JSL CHECKED BY: JWC REVISED:

07/30/21

PLAN: ROOF SCALE: As indicated

A-4

GREAT ROOM 8'-0" FLAT CEILING

BEDROOM #3 8'-0" FLAT CEILING

FOYER
8'-0" FLAT
CEILING

2 CAR GARAGE

ROOF PLAN

1/4" = 1'-0"

MODEL 1389 B: ATTIC VENTILATION FBCR R806 COORDINATE VENTING REQUIREMENTS WITH ENERGY CALCULATIONS									
SOFFIT ONLY (1/150) WITH ROOF VENTS (1/300) (NO ROOF VENTS) (R.V.)									
	AREAS (SQ. FT.)		ATTIC VENTILATION REQUIRED		ATTIC VENTILATION REQUIRED		N REQUIRED		
MARK	ATTIC	SOFFIT	ATTIC AREA/150	REQ'D AIR FLOW OF SOFFIT	QUAD 4 SOFFIT HAS	ATTIC AREA/300	QUANTITY OF ROOF VENTS	MIN AIR FLOW OF SOFFIT	
1st STORY	2000.0 SQ. FT.	176.0 SQ. FT.	13.33 SQ. FT.	7.57%	8.15%	SQ. FT.	-	%	
"SOFFIT ONLY" QUALIFIES ROOF VENTS ARE NOT REQUIRE					E NOT REQUIRED				
			NA NA	SOFFIT MOD CM QUAD 4, F IRROW PATTEI I 5% FREE AIR	FULL VENT, RN,	ROOF VENT MODEL 32" BASE BOX LOMANCO 770-D 0.97 SQ. FT. FREE AIR			

WALL HEIGHT = WALL @ 8'-0"

> DESIGN IN ACCORDANCE WITH THE RESIDENTIAL FLORIDA BUILDING CODE 2020 - 7TH EDITION

4' FLUORESCENT LIGHT 2' UNDER COUNTER LIGHT NOTE: NOT ALL SYMBOLS ARE USED FOR THIS PROJECT. ELECTRICAL NOTES: ARC-FAULT CIRCUIT-INTERRUPTERS AND TAMPER RESISTANT RECEPTACLES SHALL BE INSTALLED IN DWELLING UNITS PER N.E.C 210.12 AND 406.11 ALL ELECTRIC, ELECTRICAL EQUIPMENT AND APPLIANCES TO BE SET AT OR ABOVE BASE FLOOD ELEVATION PLUS 1'-0" FREEBOARD. ALL OUTLETS IN WET AREAS AND ALL EXTERIOR OUTLETS TO BE GFI'S. INSTALL PHONE AND T.V PER CONTRACT.

INSTALL ALL ELECTRICAL PER NEC 2017

\Rightarrow	DUPLEX RECEPTACLE OUTLET
=	1/2 SWITCHED DUPLEX OUTLET
AFF	DUPLEX RECEPTACLE AT ELEV. A.F.F.
-	DUPLEX RECEPTACLE - ABOVE COUNTER
Θ	SINGLE POLE SWITCH
() ³	3 WAY SWITCH
(∫ D	DIMMER SWITCH
₩ ^S	MOTION SENSOR SWITCH
⊗ _{SD}	AC/DC SMOKE DETECTOR TO BE INTERCONNECTED ANY RESIDENT HAVING A FOSSIL-BURNING HEATER OR APPLIANCE, A FIREPLACE, OR AN ATTACHED GARAGE SHALL HAVE AN OPERATIONAL CARBON MONOXIDE ALARM INSTALLED WITHIN 10 FEET OF EACH ROOM USED FOR SLEEPING PERPOSES. PER RULE 9B-3.04.72 SD (SMOKE DETECTOR) SCD (CARBON MONOXIDE/ SMOKE DETECTOR)
	TELEPHONE OUTLET
-TV	TELEVISION RECEPTION OUTLET
-	SURFACE MOUNTED CEILING LIGHT
	FLUSH MOUNTED LIGHT
Ю	WALL MTD. BRACKET LIGHT
44	DUPLEX FLOOD LIGHT
	EXHAUST FAN
$\nabla \nabla$	TRACK MTD. LIGHTS
마	A/C DISCONNECT
Н	PUSH BUTTON (PB) / DOOR BELL (DB)
(IC)	INTERCOM
P	KEYPAD
	4' FLUORESCENT LIGHT

ELECTRICAL LEGEND

ELECTRICAL METER

120 V JUNCTION BOX


SINGLE RECEPTACLE OUTLET


220 V RECEPTACLE OUTLET


4-PLEX RECEPTACLE OUTLET

= ELECTRICAL PANEL


ELECTRICAL PLAN 1389 200 AMP SERVICE TAG QUANTITY PRODUCT A (X) (FLUSH MOUNTED LT B (X) (VAPORS) (VALORO) (PENDANT LIGHT (10" MUSHROOMS) (24" 3 LT) (36" 4 LT) (NOT USED) (COACH LIGHTS) (COACH LIGHTS) (J BOX) (4' FLUORESCENT) (2' FLUORESCENT) (5LT CHANDELIER) (3 LT) (PENDANT/ NOOK)

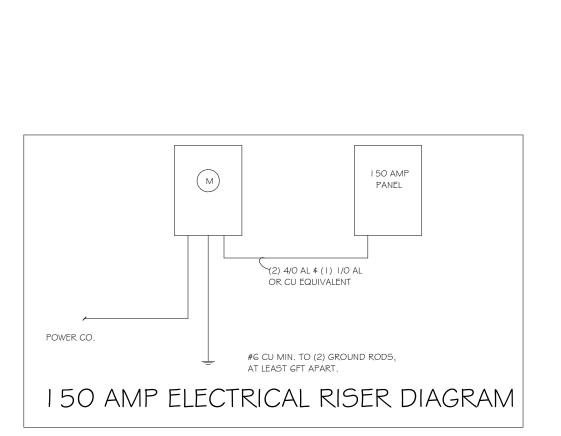

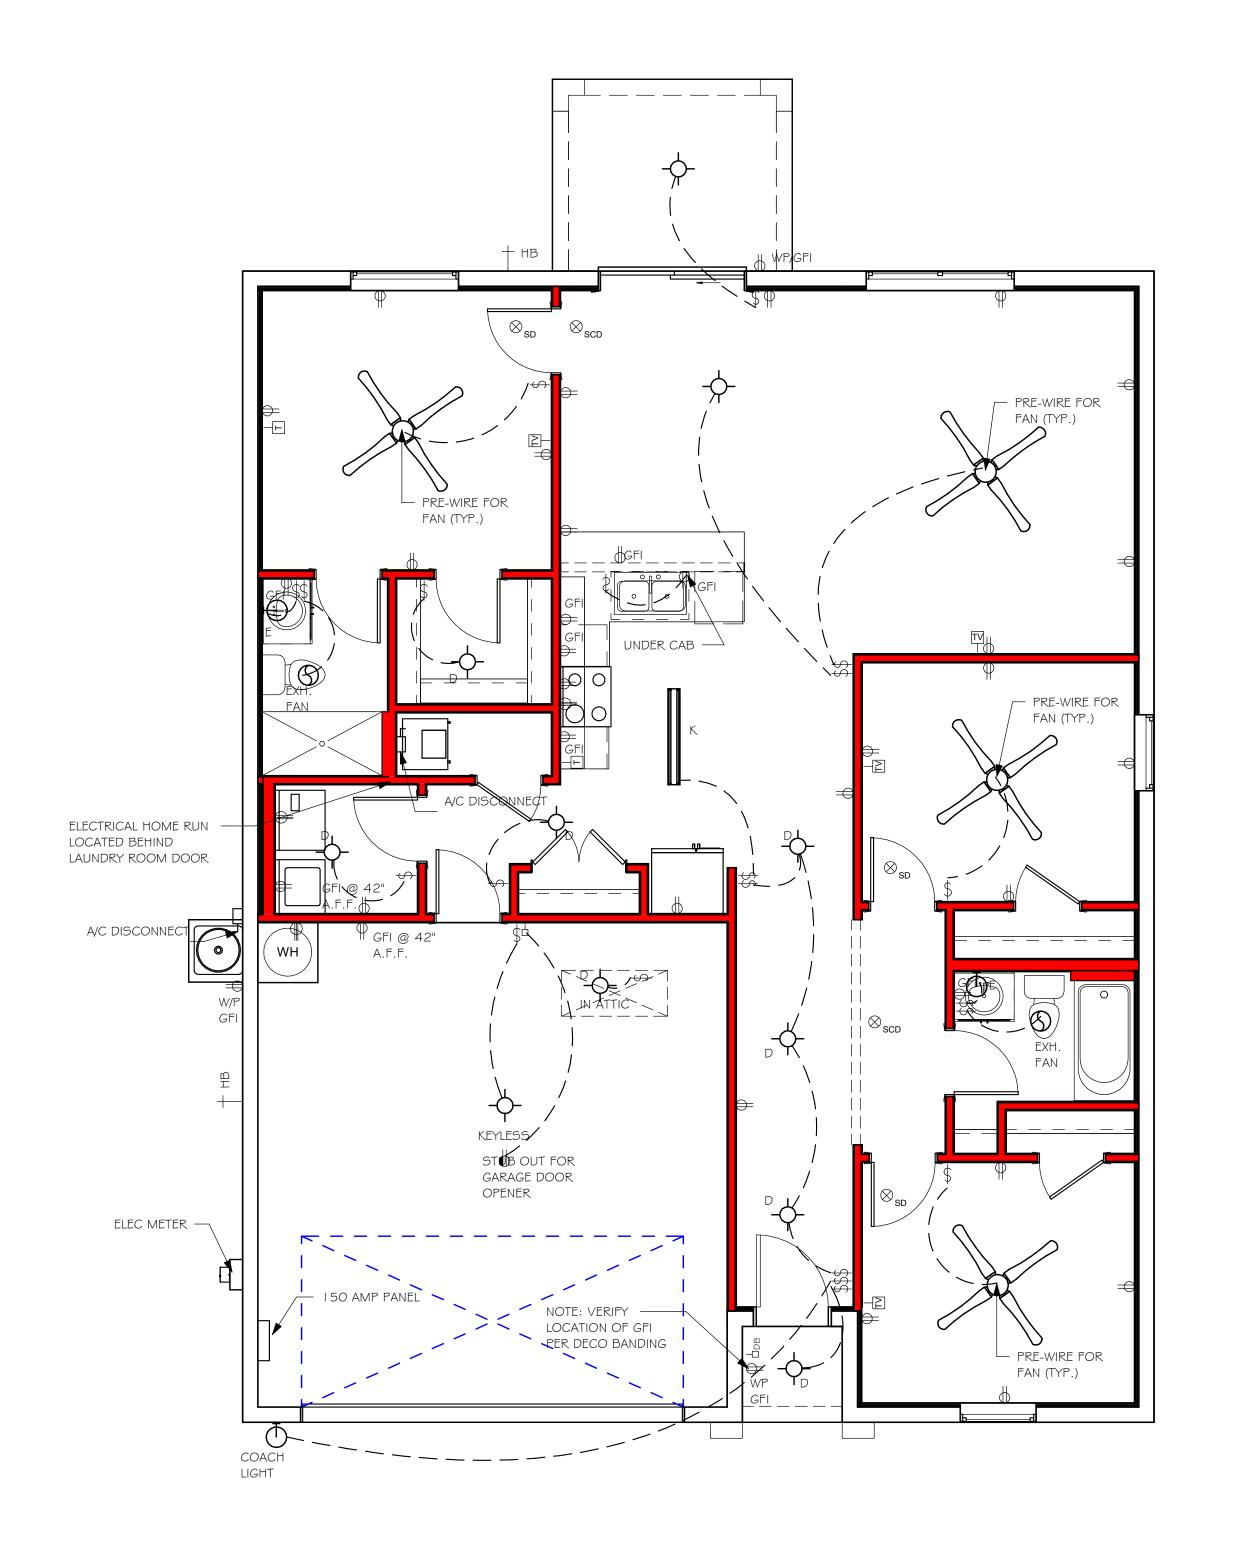


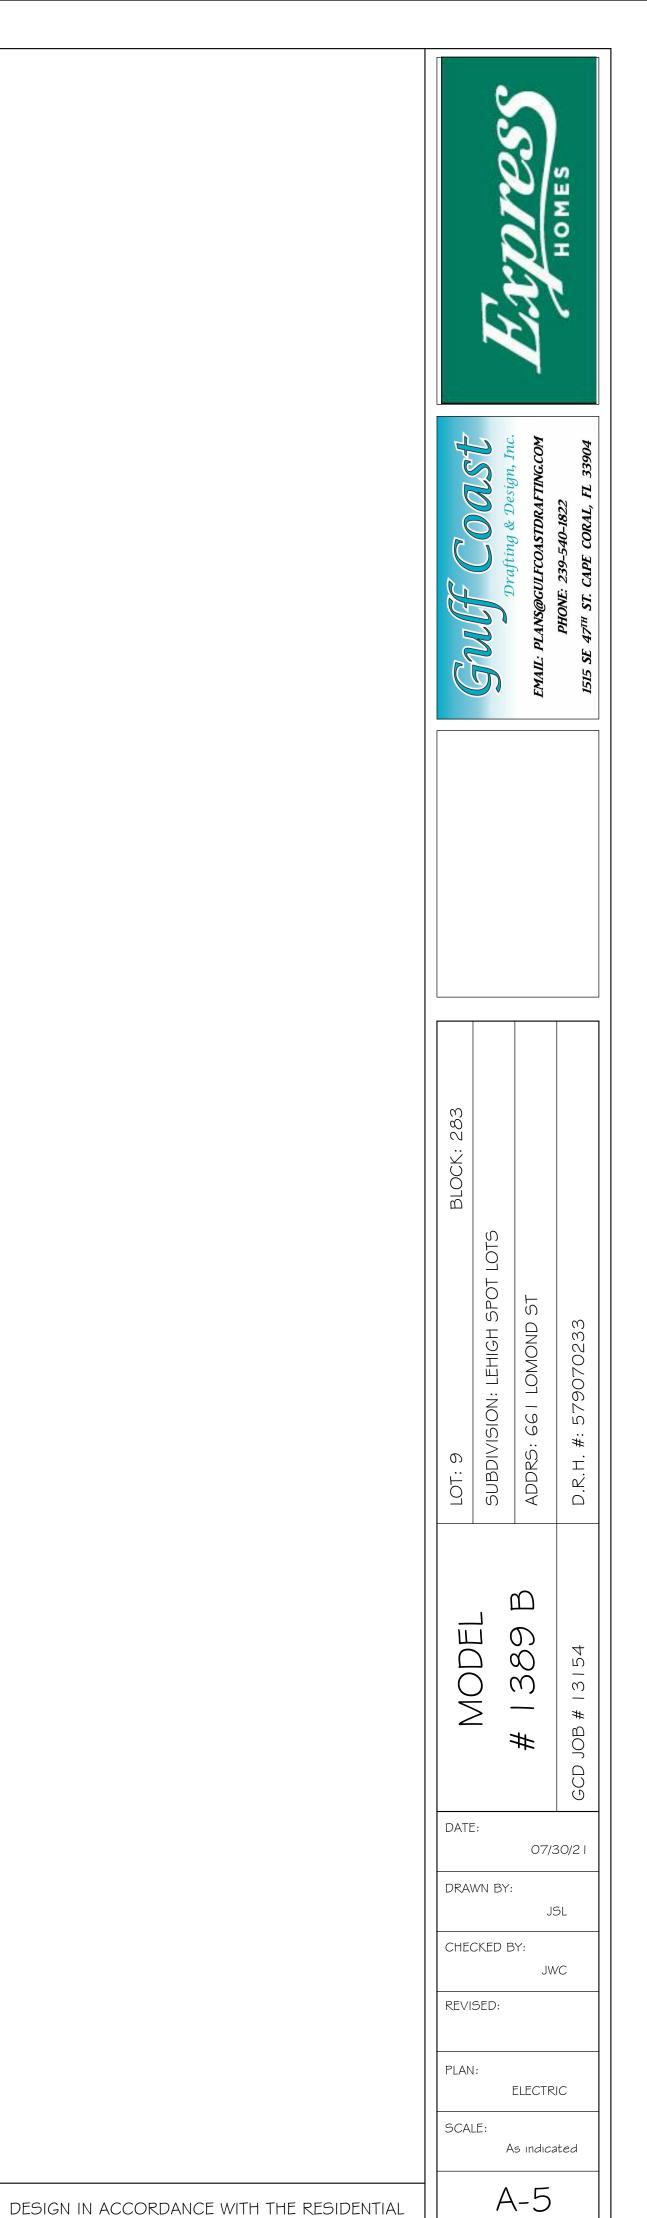


FLORIDA BUILDING CODE 2020 - 7TH EDITION

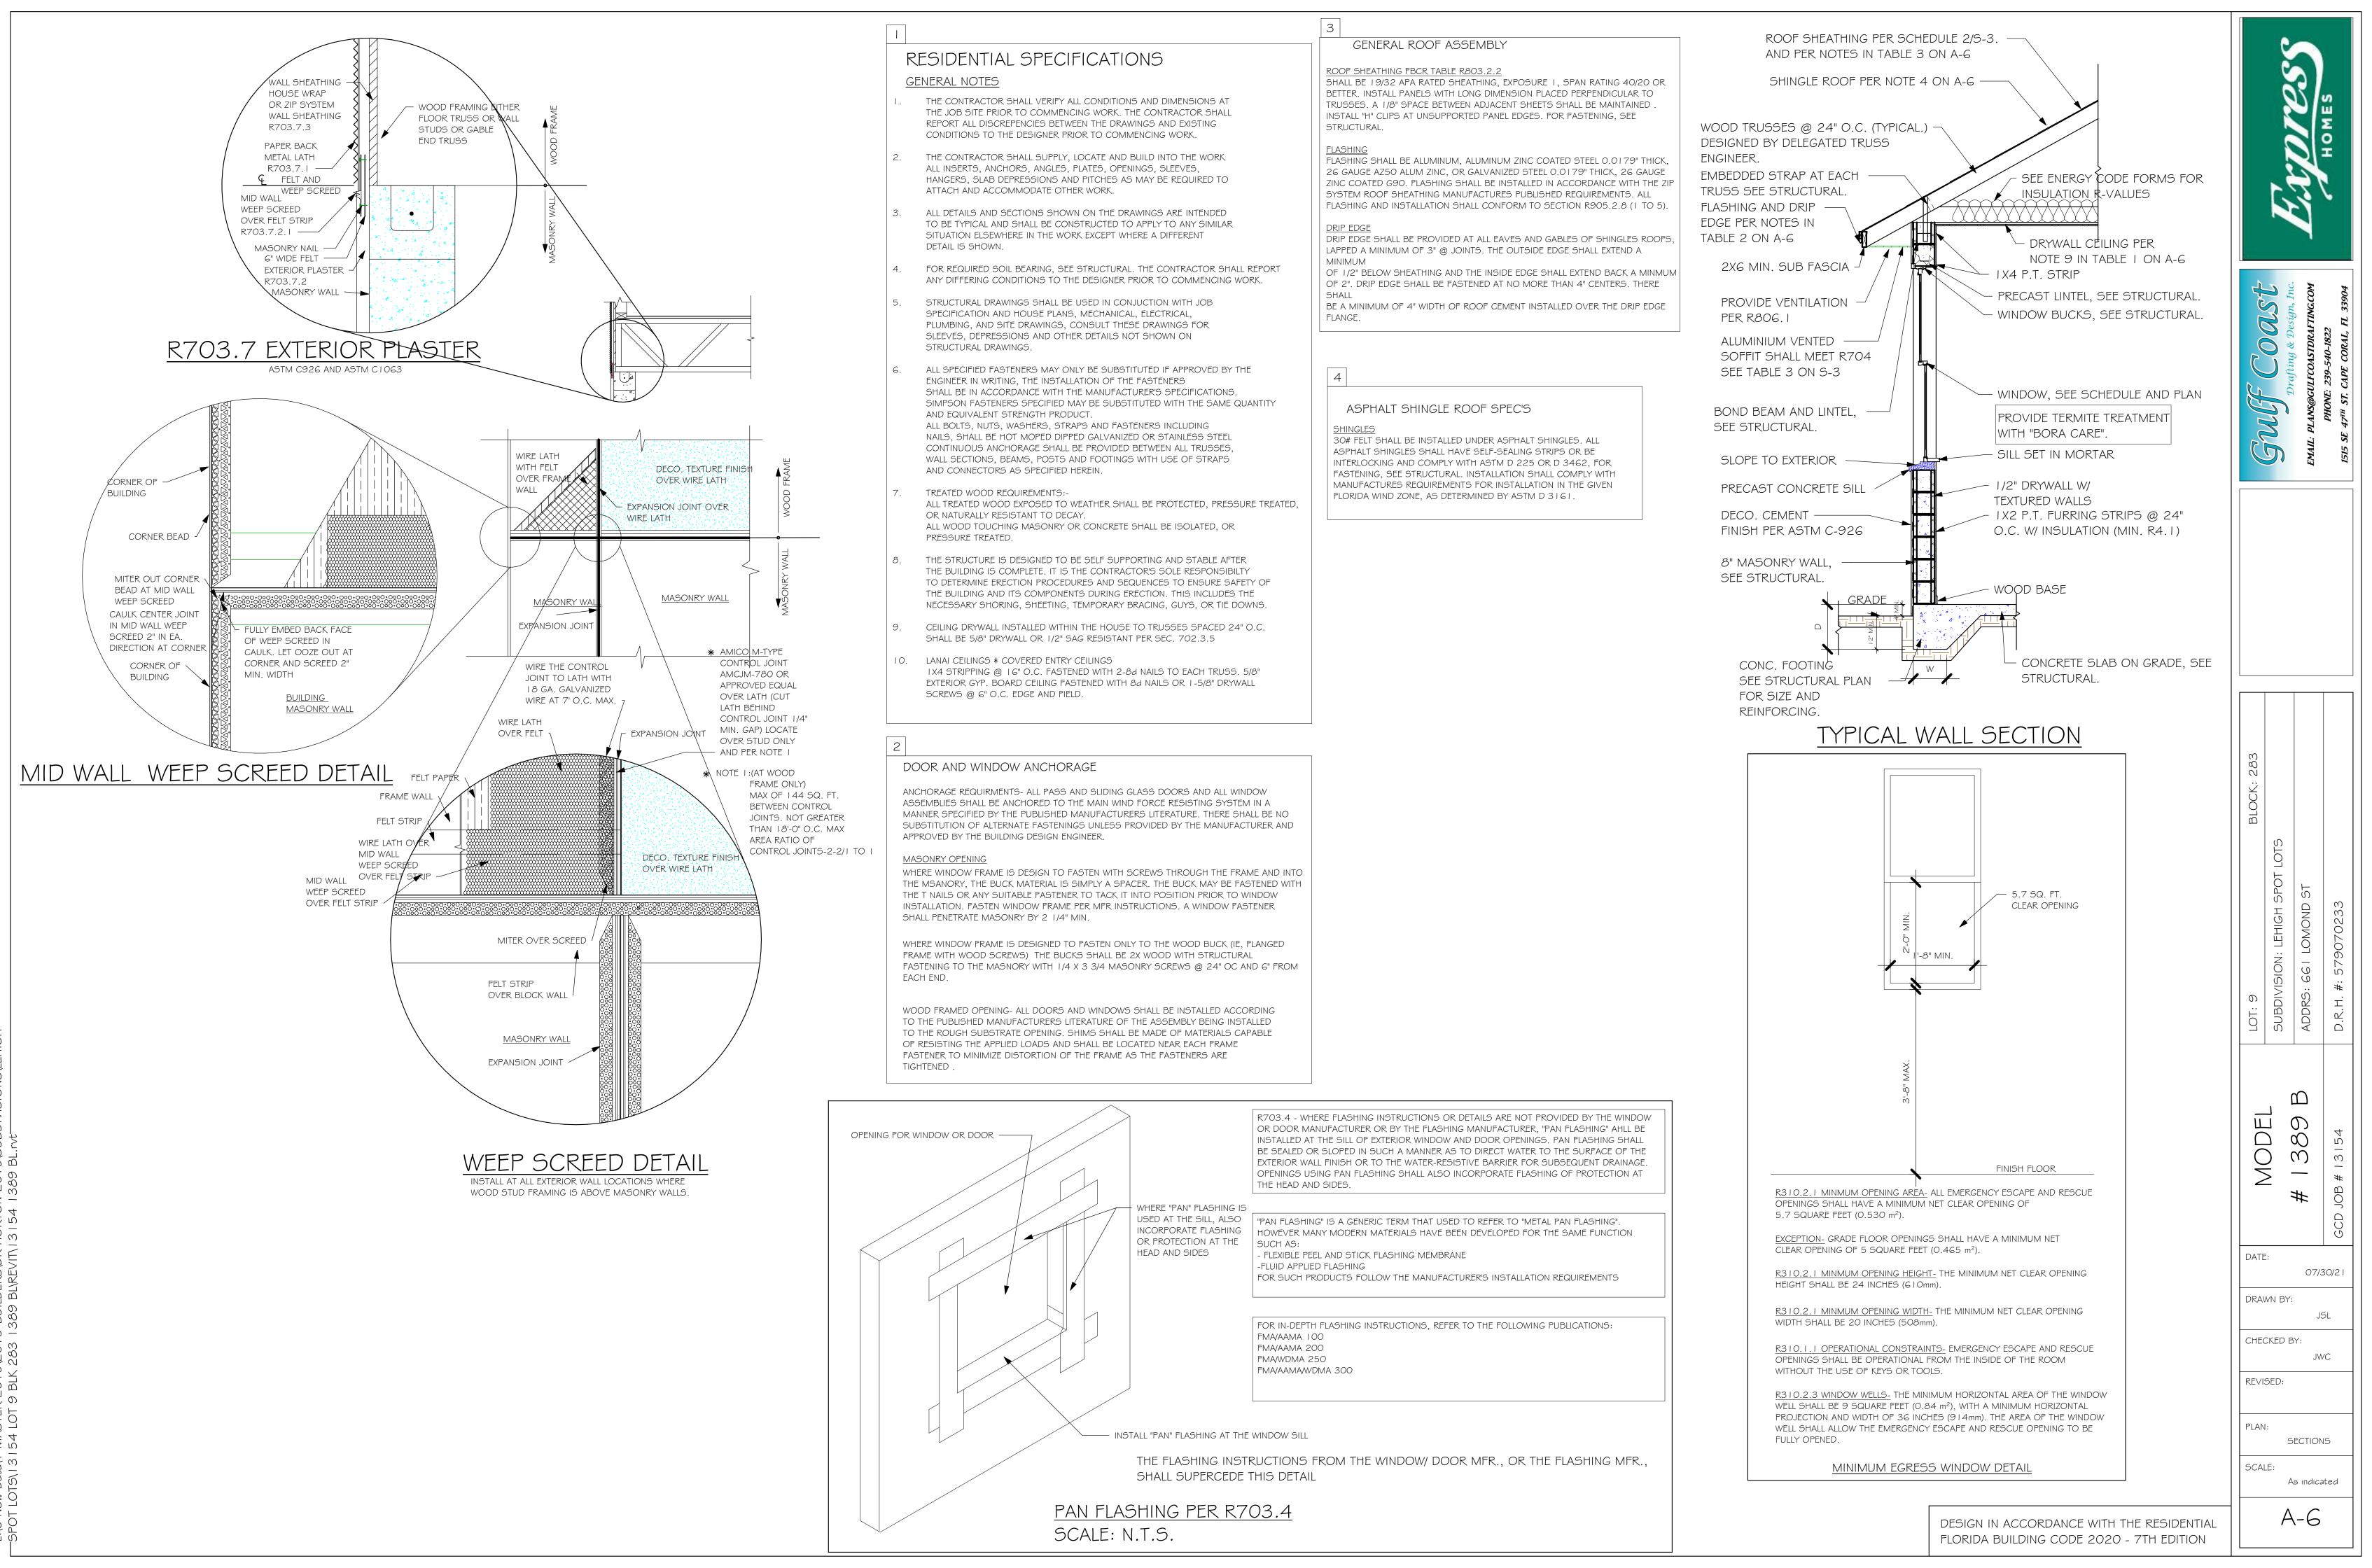


"F3" FOOTING 1/2" = 1'-0"

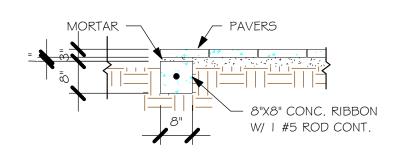


"P" PAVERS DETAIL ENTRY/ LANAI 1/2" = 1'-0"

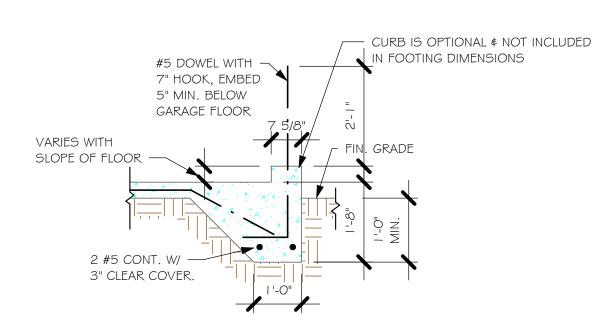

"F3" WITH CURB AT GARAGE 1/2" = 1'-0"

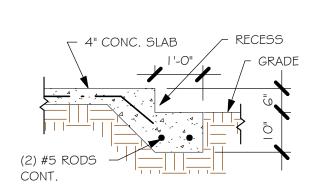

GARAGE DOOR RECESS 1/2" = 1'-0"

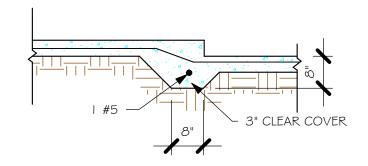

 $\frac{\text{"F6A" STEP DOWN}}{1/2\text{"} = 1\text{'-0"}}$

	PAD FOOTING SCHEDULE										
ü					ВОТТ	OM REINF.					
USED	TYPE	LENGTH	WIDTH	DEPTH	LONG WAY	SHORT WAY	REMARKS				
X	$\langle \mathbf{A} \rangle$	2'-6"	2'-6"	1'-0"	3-#5	3-#5	-				
	B	3'-0"	3'-0"	1'-0"	4-#5	4-#5	-				
	(C)	3'-6"	3'-6"	1'-0"	4-#5	4-#5	-				
	(D)	4'-0"	4'-0"	1'-2"	5-#5	5-#5	-				
	(E)	5'-0"	5'-0"	1'-2"	6-#5	6-#5	-				

	WALL FOOTING SCHEDULE						
USED	TYPE	LENGTH	WIDTH	DEPTH	BOTTOM REINFORCING	SHAPE	
	F1	CONT.	1'-4"	0'-8"	2-#5		
	F2	CONT.	1'-8"	0'-10"	2-#5		
X	F3	CONT.	1'-0"	1'-8"	2-#5	₩	ADD CURB GARAGE, S DETAIL
	F4	CONT.	1'-4"	1'-8"	2-#5		DETAIL
	F5	CONT.	1'-4"	1'-0"	2-#5	—	
	F6	CONT.	1'-4"	1'-0"	2-#5		
X	F6A	CONT.	0'-8"	0'-8"	1-#5		


1-#5

| TE | CONT. | 0'-8" | 0'-8" PROVIDE CORNER BARS PER 6/S-3



SCALE: 1/4" = 1'-0"

- PLAN NOTES: TOP OF GROUND FLOOR SLAB DATUM ELEVATION 0'-0"
- "F#" DENOTES CONTINUOUS WALL FOOTING TYPE PER SCHEDULE THIS SHEET.
- PROVIDE #5 VERTICAL REINFORCING AT DOT LOCATIONS SHOWN ON PLAN FROM FOOTING
- ALL DIMENSIONS ARE TO OUTSIDE FACE OF MASONRY WALLS. SOME SLAB EDGES MAY EXTEND BEYOND FACE OF WALL. FOR DIMENSIONS OF ROUGH OPENINGS IN MASONRY WALLS, COORDINATE WITH WINDOW/
- PROVIDE PRESSURE TREATED BUCKS AT WINDOWS/ DOORS PER DETAIL 7/S-3.

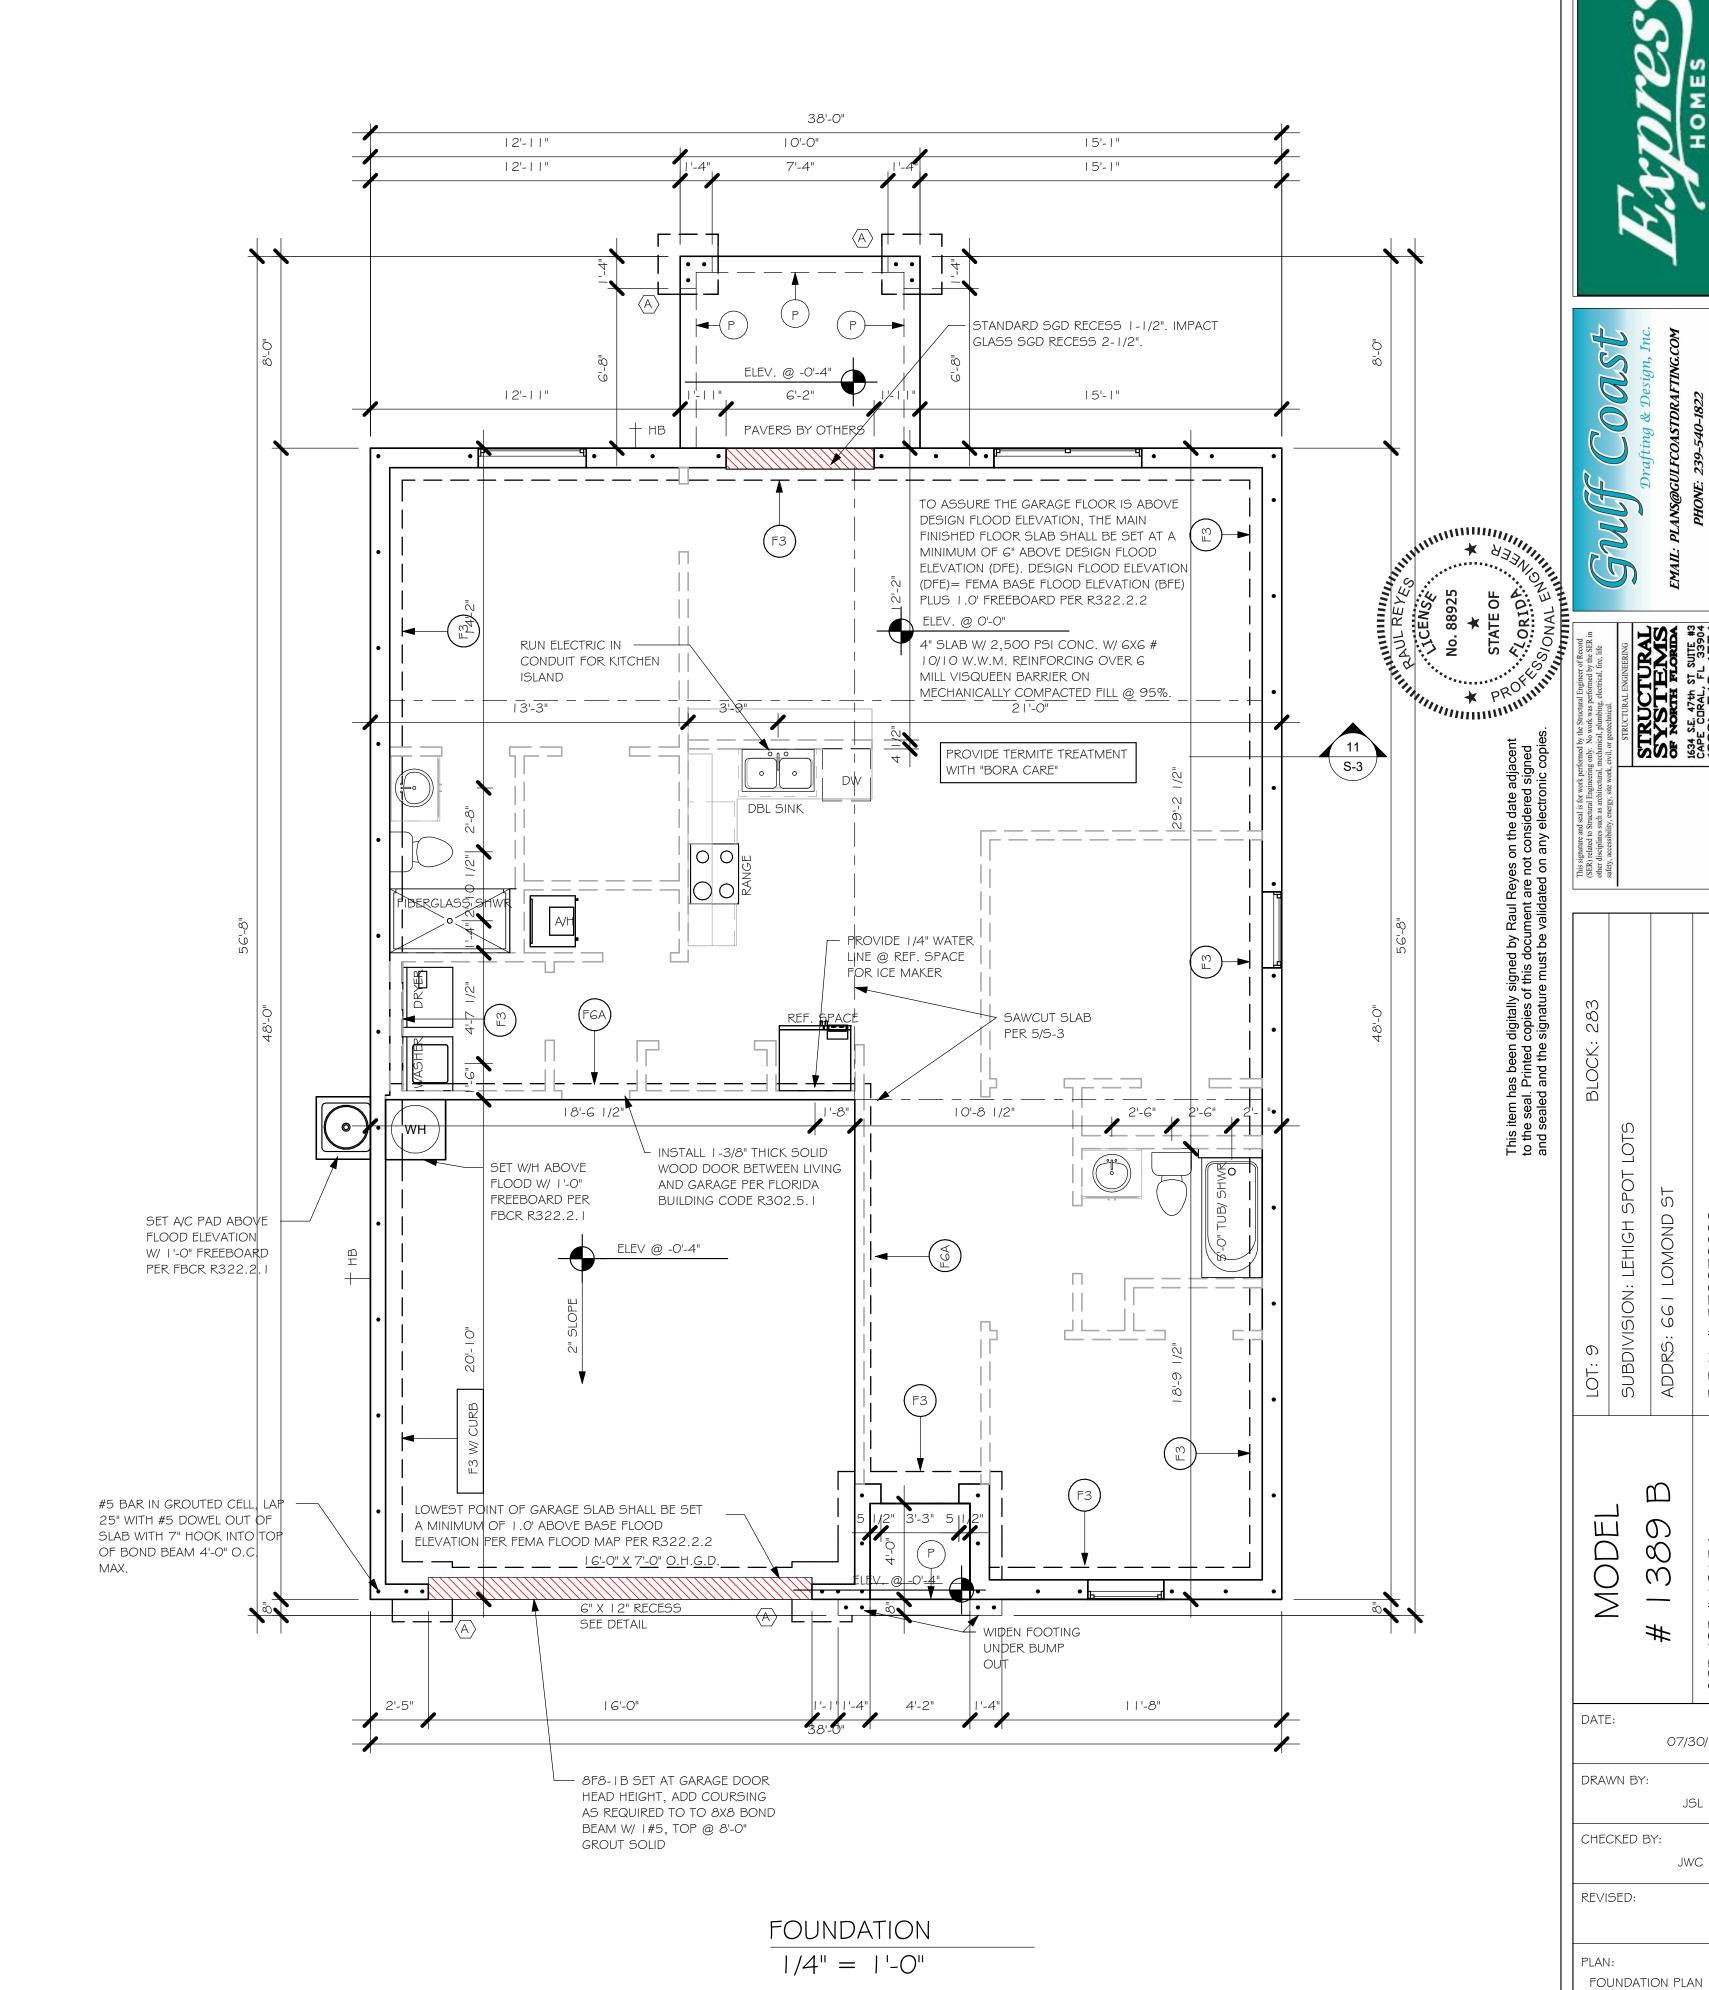

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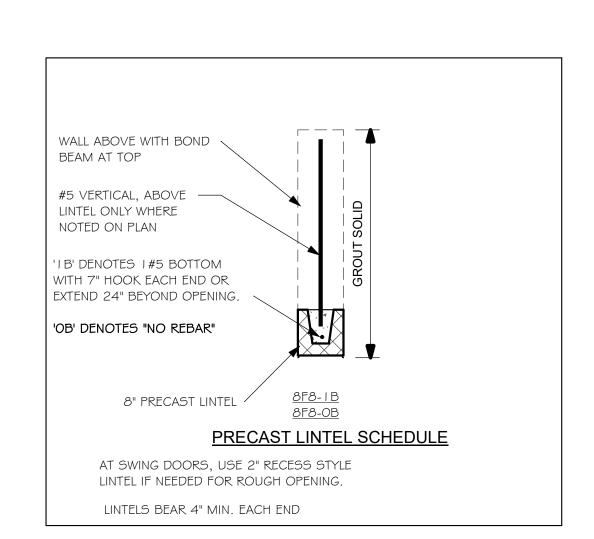
As indicated

SCALE:

- I. PROVIDE A STRAP FROM THE ABOVE LIST AT EACH ROOF TRUSS BEARING POINT, BASED ON THE TRUSS UPLIFT VALUES IN THE SIGNED AND SEALED TRUSS DESIGN PACKAGE AND SUITABLE FOR THE GEOMETRY. EMBED STRAP ON CENTERLINE OF WALL.
- ANY OF THE VALID LENGTHS SHOWN MAY BE USED IN PLACE OF THE LENGTH SPECIFIED ON PLAN.
- CONNECTORS ARE SIMPSON STRONG TIE. ALL CONNECTORS SHALL BE INSTALLED IN STRICT ACCORDANCE WITH SIMPSON PRINTED INSTUCTIONS. SUBSTITUTIONS MUST BE APPROVED IN
- WRITING BY THE ENGINEER OF RECORD. 4. WHERE EMBEDDED STRAPS ARE MISSING, OR MIS-LOCATED, INSTALL RETROFIT STRAP PER 10/S-3.

PER UPLIFT IN TRUSS ENGINEERING.


SIMPSON CATALOG C-C- 2019



PLAN NOTES:


- ROOF TRUSS BEARING @ 8'-0".
- ROOF FRAMING SHALL BE WOOD TRUSSES DESIGNED BYA DELEGATED TRUSS ENGINEER PER DESIGN CRITERIA ON SHEET S-3.
- PROVIDE STRAPPING AT TRUSSES PER NOTES ON THIS
- FOR NAILING OF ROOF AND FLOOR DECK, SEE I AND 2

- ON 5-3. 8F8-1B etc., DENOTES PRECAST LINTEL ABOVE DOOR/MINDOW OPENING PER SCHEDULE THIS SHEET. AT TRUSS BEARING, PROVIDE 8x8 MASONRY BOND BEAM W/ I #5 CONTINUOUS, SEE DETAIL I I/S-3.

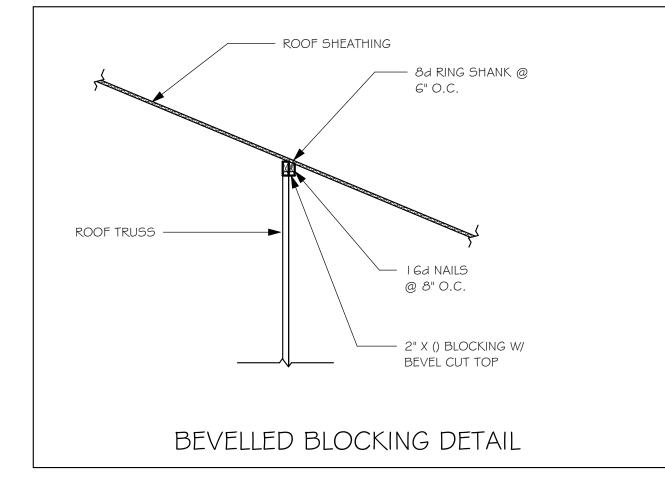

TRUSS BEARING CONDITIONS AND STRAPPING IS BASED ON TRUSS LAYOUT PREPARED BY SCOSTA JOB#: DR | 389BL DATED: | 1/30/20 REVISED: NONE



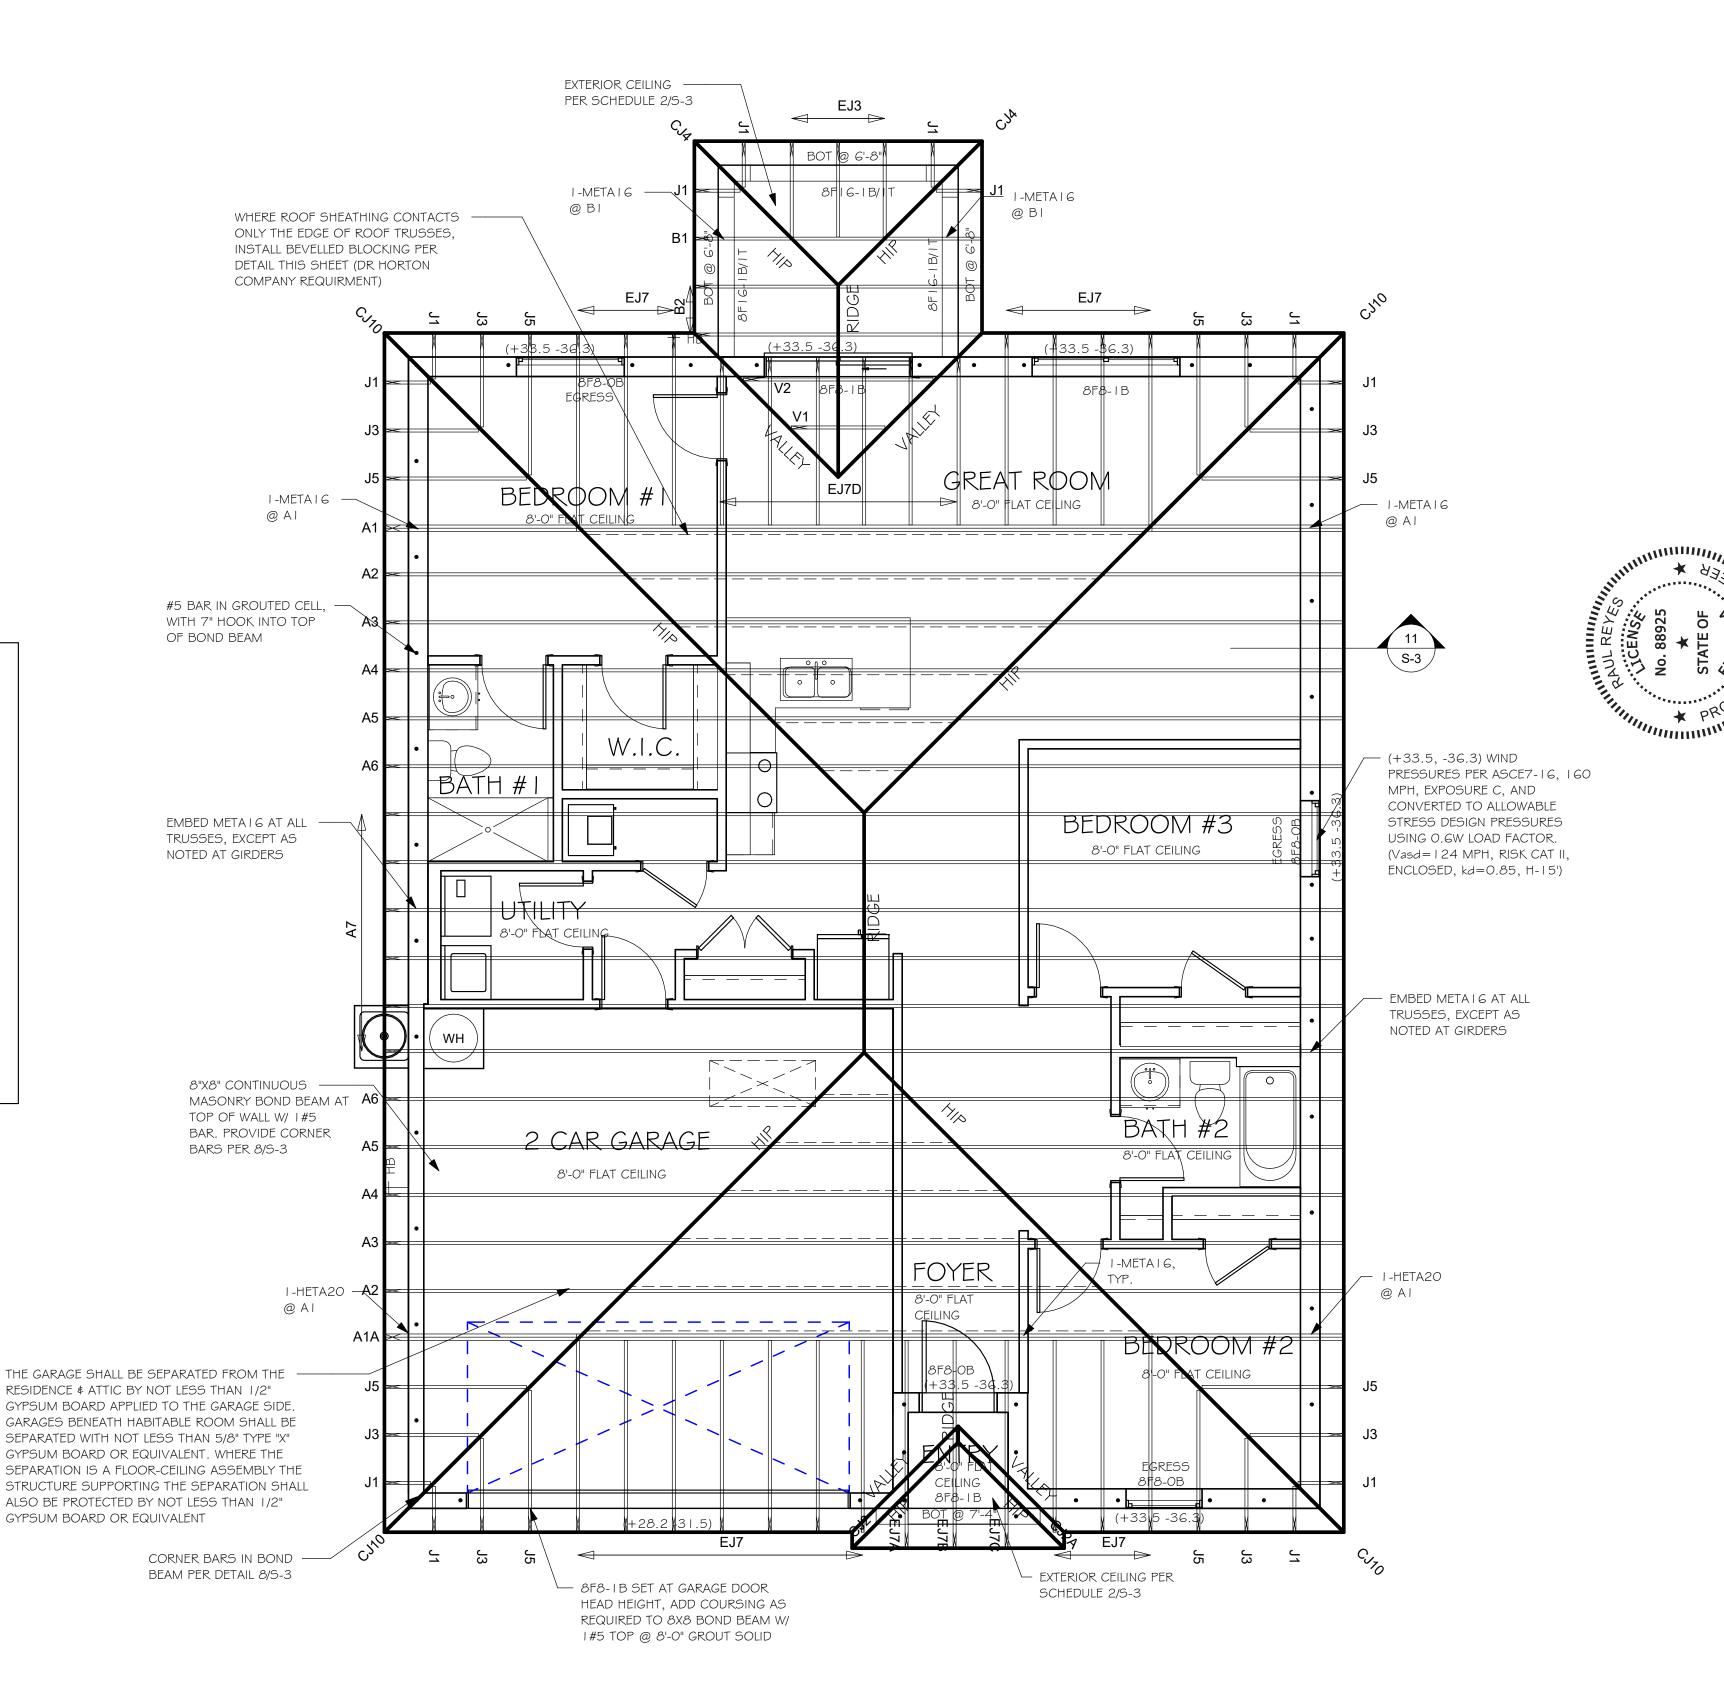

ROOF FRAMING PLAN 1/4" = 1'-0"

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ST

日

MOD

DATE:

DRAWN BY:

CHECKED BY:

ROOF FRAMING PLAN

As indicated

REVISED:

SCALE:

 \mathcal{O}

38

07/30/21

JSL

JWC

