


Engineer of Record for the Structure Structural Systems of N. Fl, Inc. Raul Reyes, PE 88925 1634 SE 47th Street #3 Cape Coral, FL 33904


This document has been reviewed for conformance with the design intent of the structure and specified design criteria.

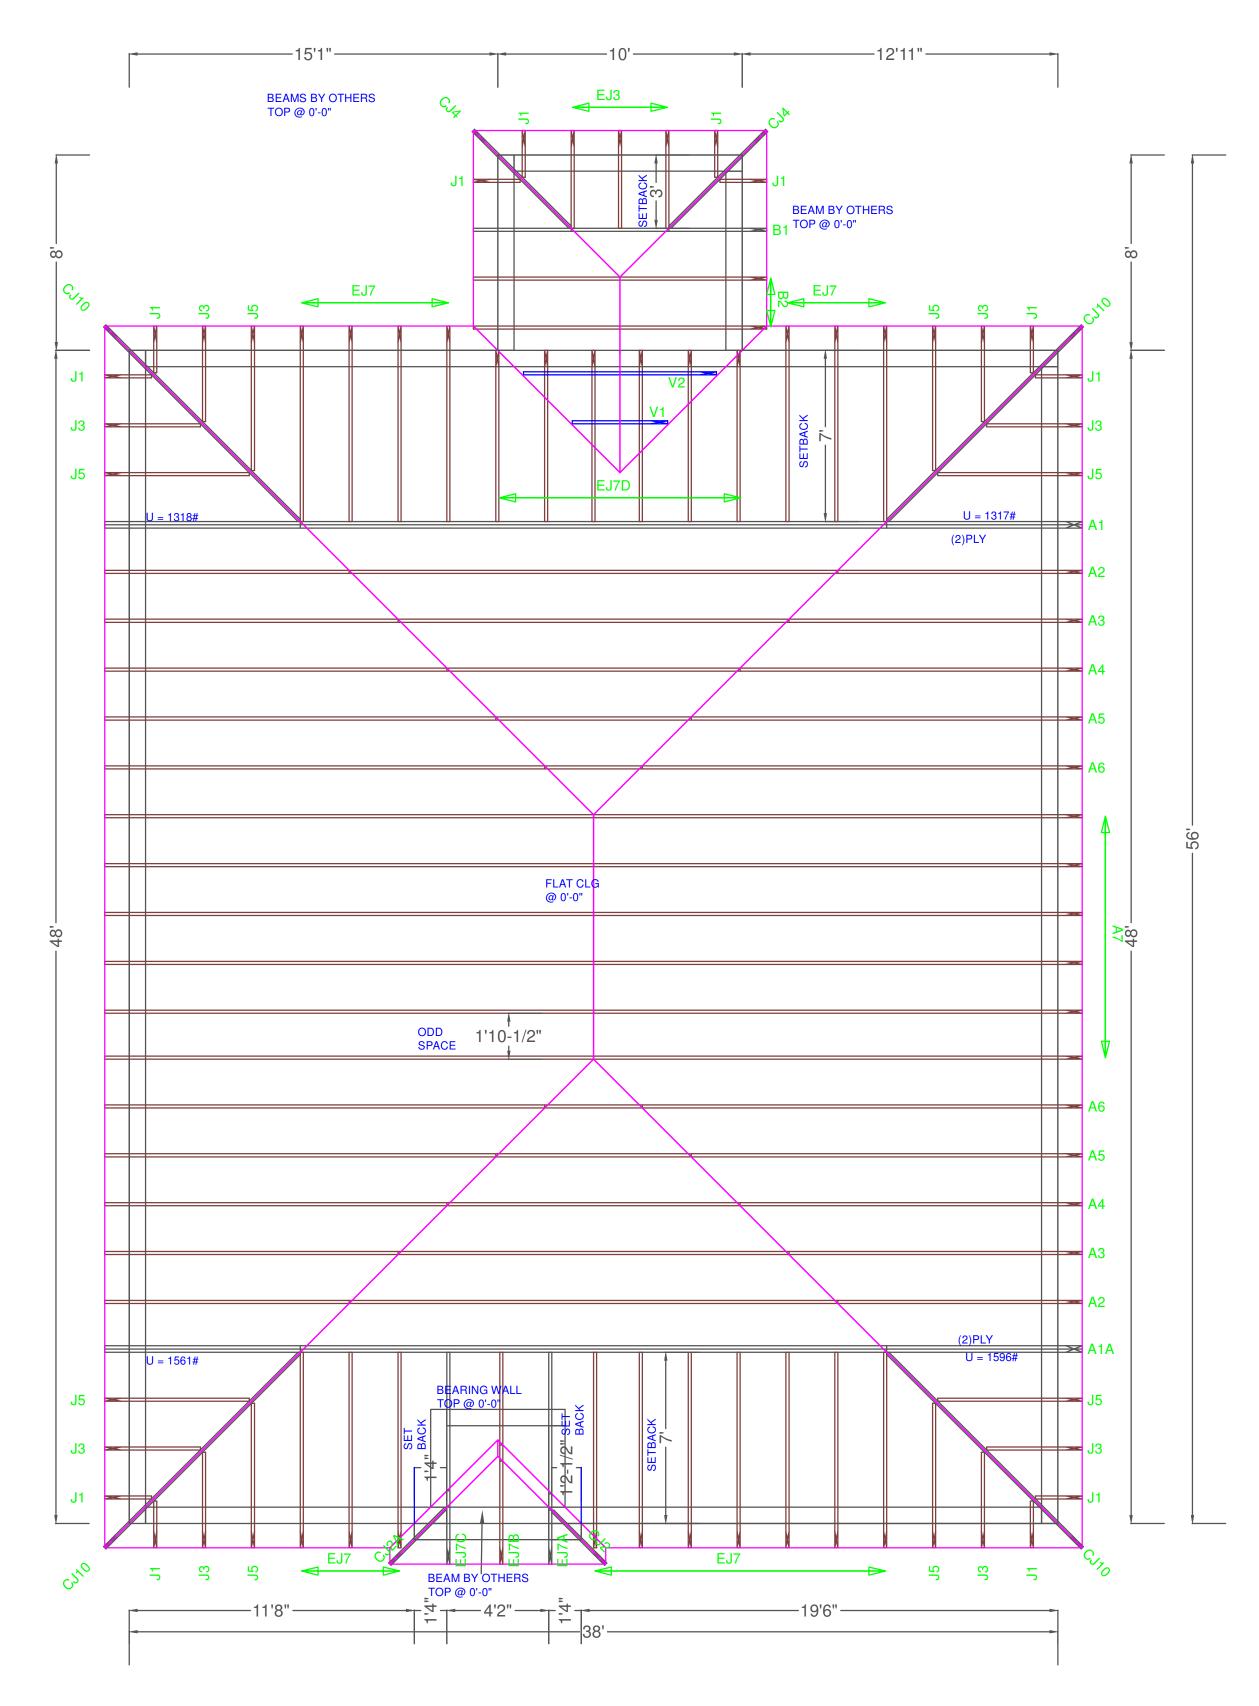

TYPICAL JACK CUTS

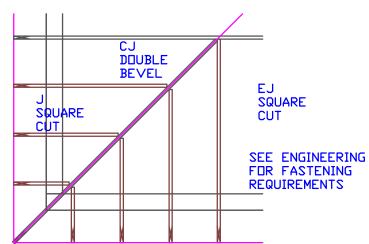

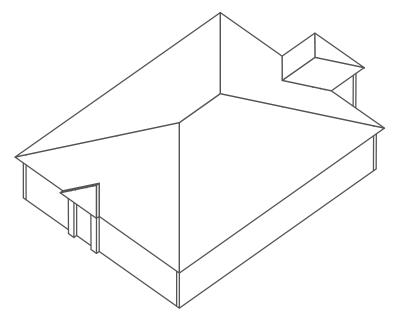

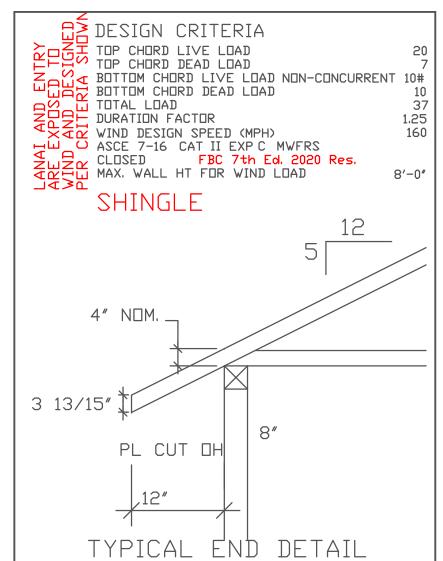

UNLESS NOTED

REACTION VALUES ARE UNDER 5000#

UPLIFT VALUES ARE UNDER 1000#

ALL TRUSSES 24"o.c. UNLESS NOTED OTHERWISE

DO NOT ATTEMPT TO ERECT TRUSSES WITH-

OUT REFERRING TO THE ENGINEERING DWGS.

IT IS NECESSARY TO REFER TO THE ENGINEERING DRAWINGS FOR NUMBER OF MEMBERS, BEARING LOCATION,

DRAWINGS FOR NUMBER OF MEMBERS, BEARING LOCATI
ORIENTATION AND WEB BRACING

REFER TO WTCA/TPI BSCI-B1 SUMMARY
SHEET FOR HANDLING METHODS & TEMPORARY
BRACING, WHICH IS ALWAYS REQUIRED
BEARING HEIGHTS BASED ON PLANS PROVIDED TO
SCOSTA CORP. "+/-" BEARING DIFFERENCES SHOWN ARE
CRITICAL. IF ANY HEIGHTS DEVIATE - INFORM SCOSTA
CORP.

0'-0"

ELEV.

BEARING WALL & BEAM HEIGHTS

7/////	ELE'
	ELE'
	ELE'
ERREGREE	ELE'
	ELE'
***************************************	ELE'

TYPICAL HANGER SCHEDULE

- C SIMPSON HUS 26 M SIMPSON HGUS 28-3

 (F) SIMPSON HUS 28 N SIMPSON HHUS 48
- H SIMPSON HGUS 28 P SIMPSON LUS 24
- I SIMPSON HGUS 28-2 B SIMPSON THA 422
- W SIMPSON THJA26 X

 HANGER VALUES HAVE BEEN BAS

HANGER VALUES HAVE BEEN BASED ON 16D COMMON NAILS EXCEPT THE FOLLOWING LUS24 - 10D COMMON THJA26 - 10D x 1-1/2

APPROVAL OF THIS TRUSS LAYOUT IS NECESSARY

BEFORE FABRICATION CAN BEGIN. VERIFY DIMENSIONS, PITCHES, OVERHANGS, ELEVATIONS, CEILING & BEARING CONDITIONS. SCOSTA CORPORATION IS RESPONSIBLE FOR ACCURACY IN ACCORDANCE WITH PLANS AND/OR INFORMATION PROVIDED BY CUSTOMER, WITH ANY DEVIATIONS NOTED HEREIN. CUSTOMER IS RESPONSIBLE TO VERIFY ACCURACY OF INFORMATION AND PLANS PROVIDED TO SCOSTA CORPORATION, AND TO VERIFY CONFORMANCE TO FIELD CONDITIONS, AND/OR OWNER CHANGES. TRUSSES WILL BE BUILT IN ACCORDANCE WITH THE APPROVED LAYOUT.


APPROVED BY: _____ REQUESTED DELIVERY DATE: _____

JOBSITE CONTACT NAME:


PHONE #: ____


E-MAIL: __



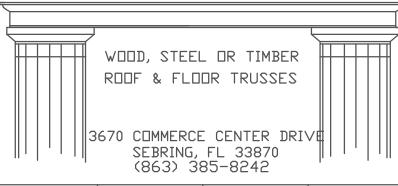

SCALE:	DATE:	REVISED BY:	DRAWN	BYı
1/4"=1'-0"	11/30/20		KJC	
	89 B W/ LA RAGE RIGHT E	NAI	1	of 1
CUSTOMER:			JOB #	
D.R. HORTON			DR13	89BI

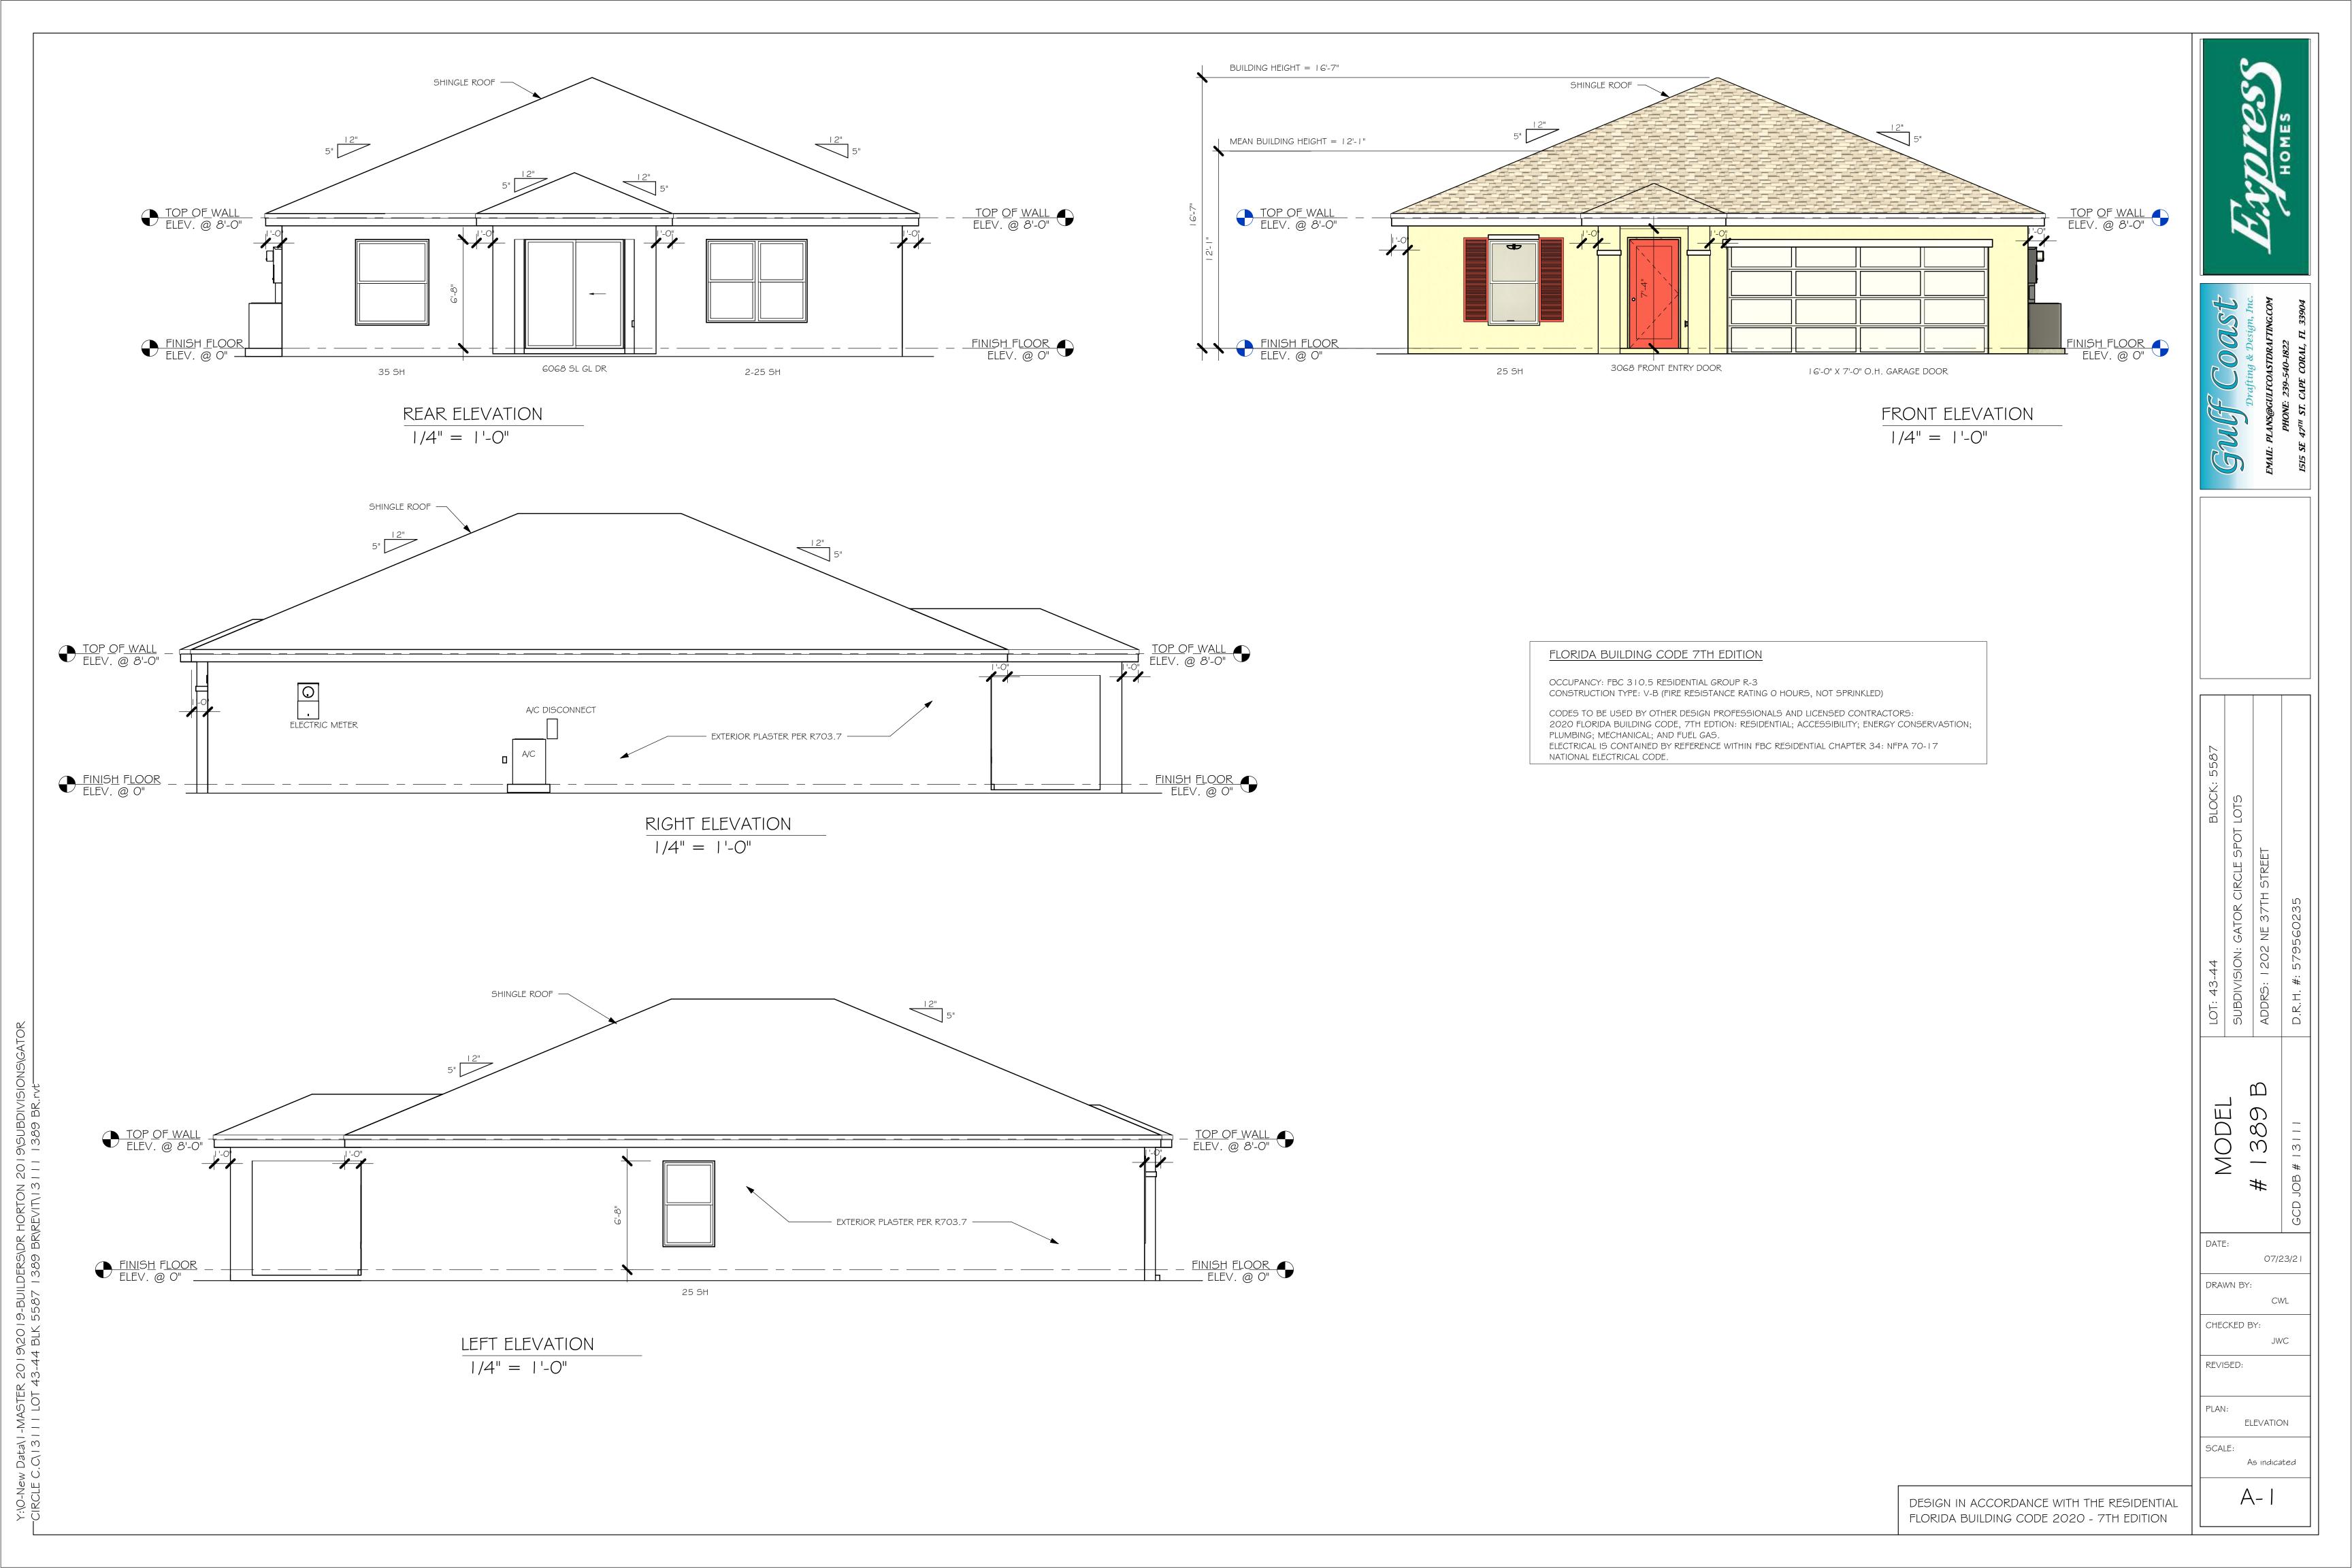


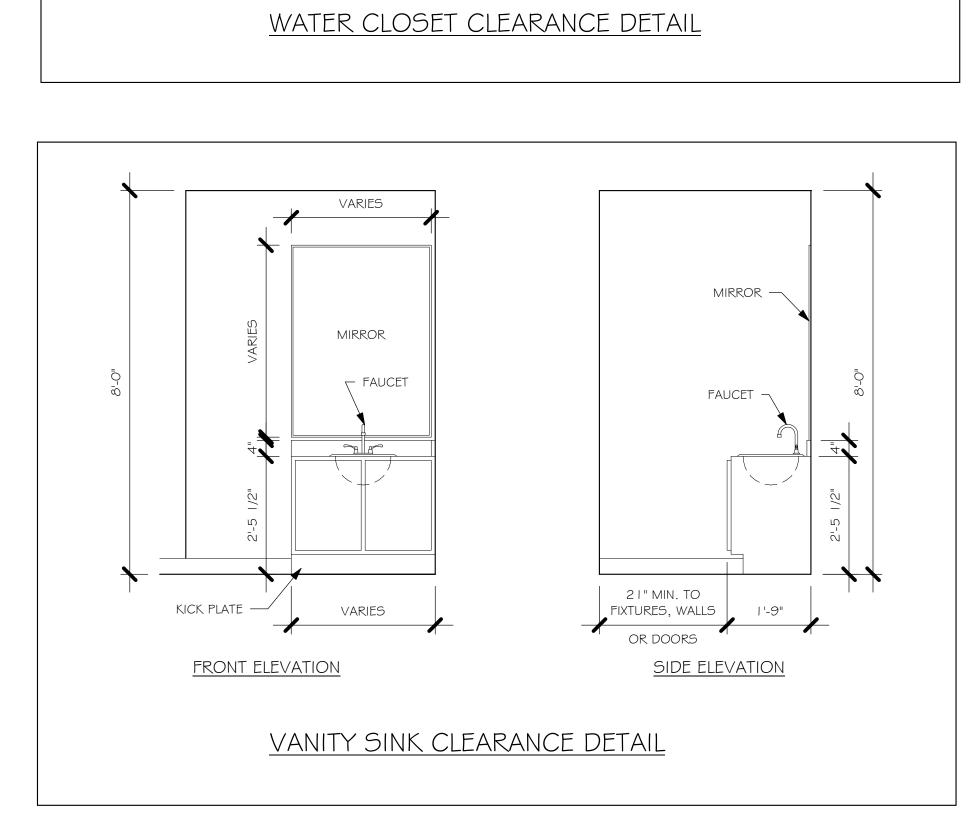

FRONT ELEVATION


36" MAX.

SIDE ELEVATION

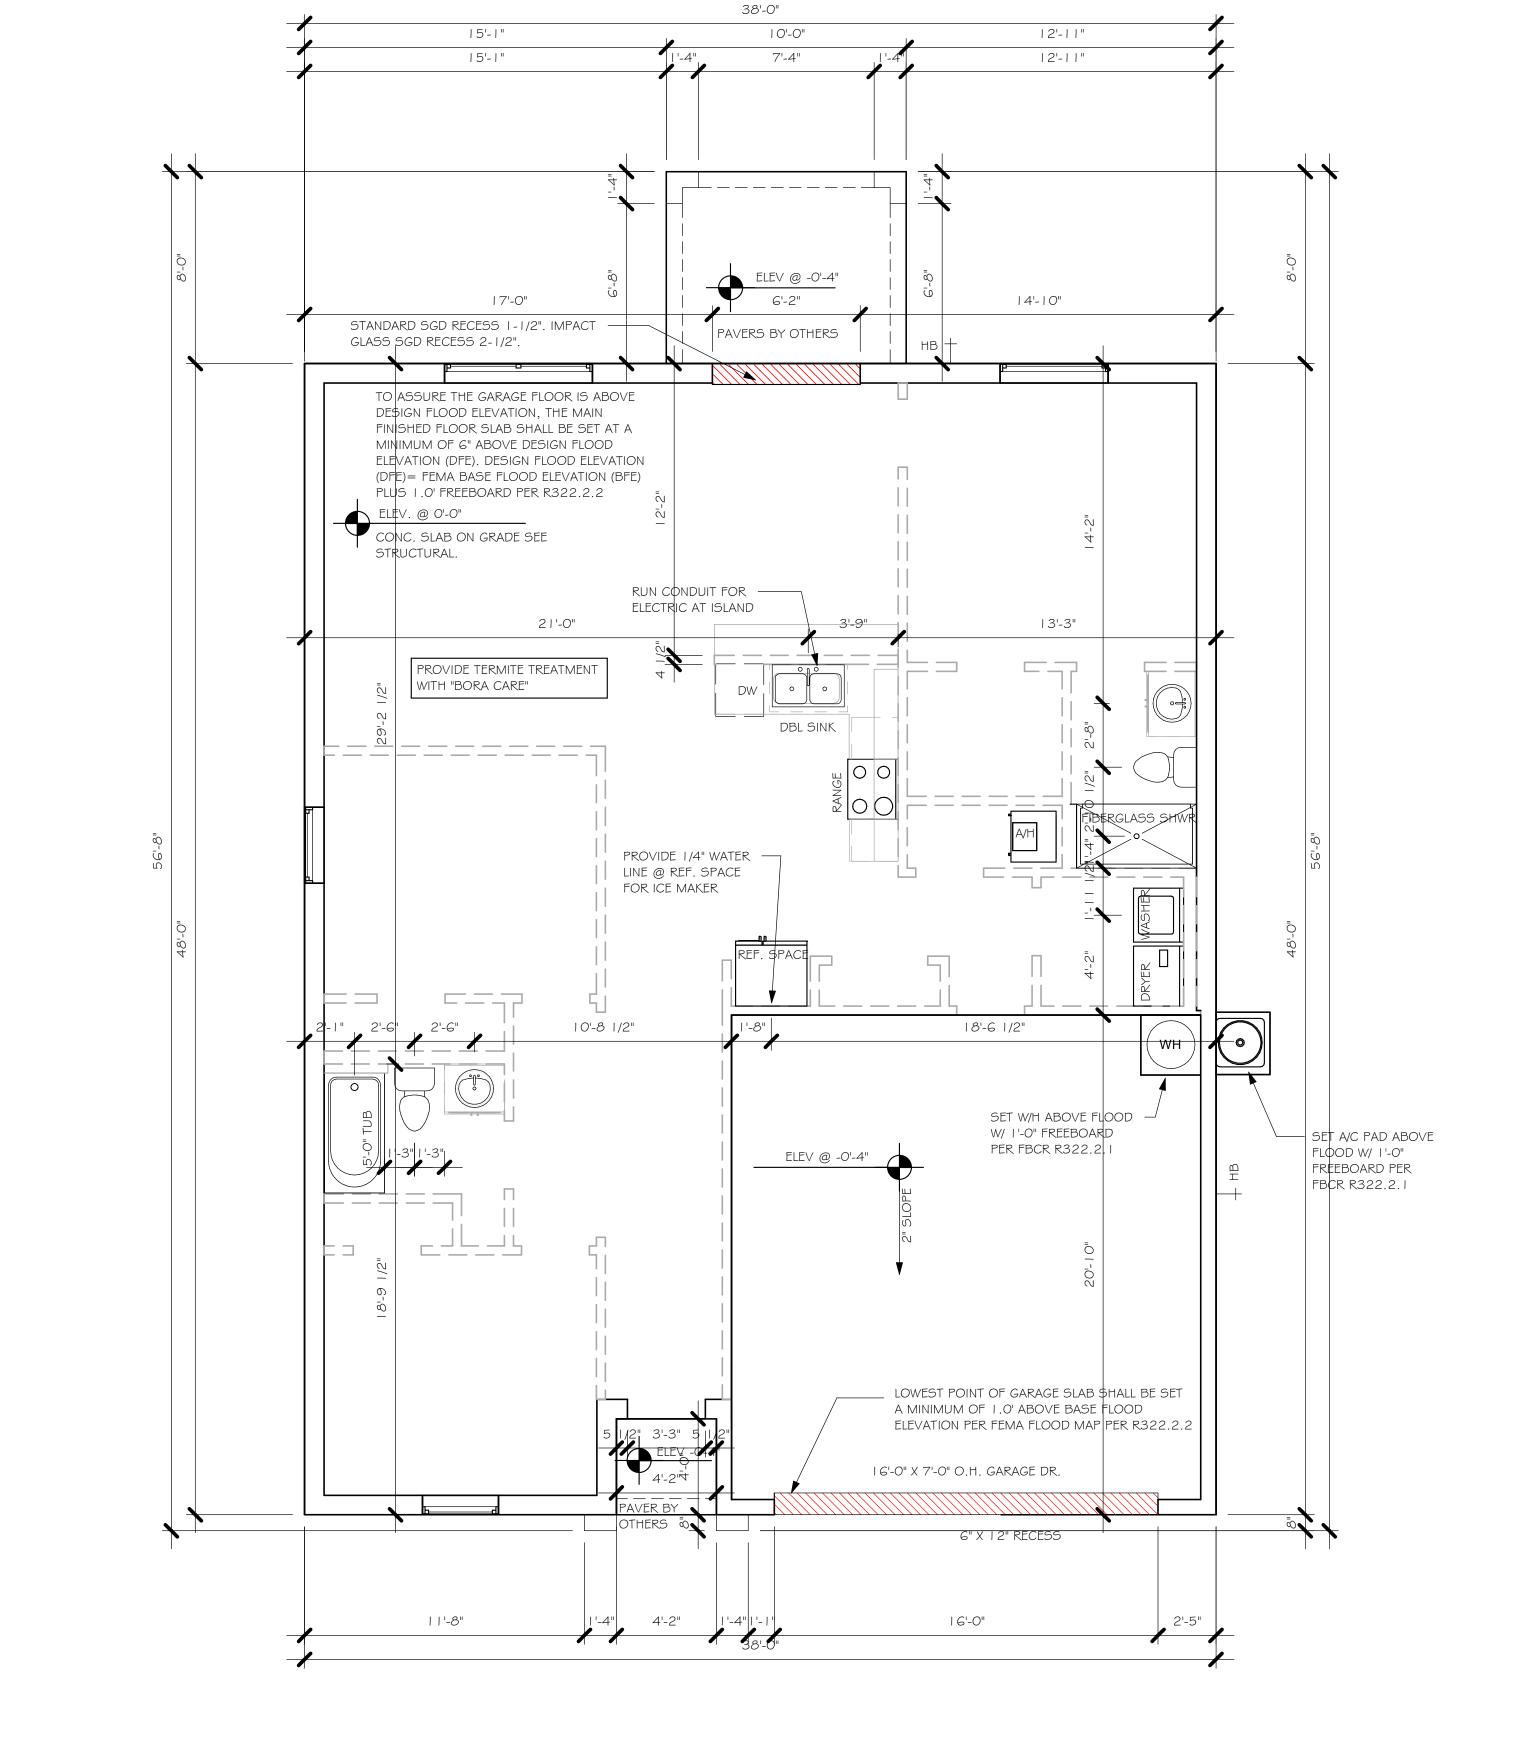

SLAB & PLUMBING 1/4" = 1'-0"

MODEL DATE: 07/23/21 DRAWN BY: CWL CHECKED BY: JWC REVISED: SLAB & PLUMBING SCALE: As indicated A-2 DESIGN IN ACCORDANCE WITH THE RESIDENTIAL FLORIDA BUILDING CODE 2020 - 7TH EDITION

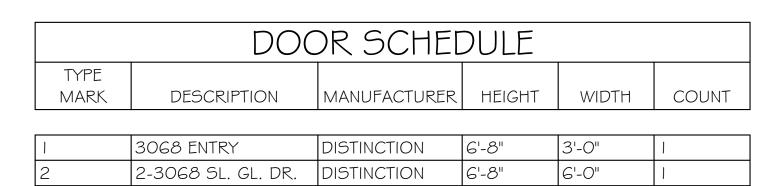

GARAGE DOOR

7'-0"

16'-0"

	WI	NDOW SC	CHEDU	ILE	
MARK	DESCRIPTION	MANUFACTURER	HEIGHT	WIDTH	COUNT
٨	0 05 64		L 0	CL 411	1

А	2-25 SH	5'-3"	6'-4"	1
В	25 SH	5'-5"	3'-4"	2
С	35 SH	5'-5"	4'-8"	1

D	OOR HEADE	RS .
6'-8" BI-FOLD	HEADER HEIGHT	82" A.F.F.
6'-8" SWING	HEADER HEIGHT	82 I/2" A.F.F.
8'-0" SWING	HEADER HEIGHT	98 1/2" A.F.F.

PLAN NOTES

VERIFY ALL ROUGH OPENING DIMENSIONS FOR ALL WINDOWS AND DOORS

16070 OHGD

- PROVIDE SAFETY GLAZING WITHIN 24" FROM EXIT PER FLORIDA BUILDING CODE R 308.4.2.
- PROVIDE SAFETY GLAZING AT BATH/ SHOWER PER FLORIDA BUILDING CODE R 308.4.5.
- NON BEARING INTERIOR FRAME WALLS SHALL BE FRAMED W/ WOOD OR METAL STUDS. SPACING SHALL NOT EXCEED 24" O.C. (NON BEARING WALLS ONLY)
- PROVIDE DEAD WOOD IN ATTIC FOR OVERHEAD GARAGE DOOR HARDWARE
- KITCHEN KNEE WALL TO BE FRAMED W/ TOP @
- 34 I/2" A.F.F.
- INSTALL SMOOTH WALLS IN KITCHEN AND ALL BATHROOM AREAS
- WHERE DRYWALL CEILING IS APPLIED TO TRUSSES @ 24" O.C. USE 5/8" DRYWALL OR 1/2" SAG RESISTANT PER SEC. R702.3.5
- THE GARAGE SHALL BE SEPARATED FROM THE RESIDENCE & ATTIC BY NOT LESS THEN 1/2" GYPSUM BOARD APPLIED TO THE GARAGE SIDE. GARAGES BENEATH HABITABLE ROOMS SHALL BE SEPARATED WITH NOT LESS THAN 5/8" TYPE "X" GYPSUM BOARD OR EQUIVALENT. WHERE THE SEPARATIION IS A FLOOR - CEILING ASSEMBLY, THE STRUCTURE SUPPORTING THE SEPARTION SHALL ALSO BE PROTECTED BY NOT LESS THAN 1/2" GYPSOM BOARD OR EQUIVALENT
- 10) INSTALL 1 3/8" THICK SOLID WOOD DOOR BETWEEN LIVING AND GARAGE PER FLORIDA BUILDING CODE R302.5.1,
- II) ALL WINDOWS INSTALLED 72" ABOVE GRADE MUST COMPLY WITH R3 | 2.2 MIN 24" SILL HEIGHT OR PROVIDED WITH AN APPROVED WINDOW FALL PREVENTION DEVICE
- 12) ALL CLOSET SHELVES TO BE 12". ALL PANTRY \$ LINEN TO BE (4)-16" SHELVES 18" O.F.F. W/ 15" INCREMENT.
- 13) ALL MECHANICAL AND ELECTRICAL EQIUPMENT TO BE INSTALLED AT OR ABOVE FLOOD PLUS 1'-0" FREEBOARD.

IN.	TERIOR DO	OR SCHEDULE
MARK	DOOR WIDTH	NOTES
	3'-0"	P.K. = POCKET DOOR
2	2'-8"	B.F. = BI-FOLD DOOR
3	2'-6"	D.1 DI-1 OLD DOOK
4	2'-4"	B.P. = BI-PASS DOOR
5	2'-0"	L.V. = LOUVERED DOOF
6	1'-8"	
7	1'-6"	
8	2'-11"	


SQUARE FOOTAGE		
LIVING AREA	1,389	
GARAGE AREA	419	
LANAI AREA	80	
FRONT PORCH/ ENTRY AREA	16	
TOTAL SQUARE FOOTAGE	1,904	

CABINET BACKING			
KITCHEN	UPPER TOP @ 84"	BASE TOP @ 35"	
MASTER BATH	UPPER	BASE TOP @ 35"	
GUEST BATH	UPPER	BASE TOP @ 31"	
LAUNDRY ROOM	UPPER TOP @ 84"	BASE	


TYPICAL DIMENSION STRING

FACE OF OUTSIDE WALL TO FACE OF STUD WALL FACE OF STUD TO FACE OF STUD

TP	TOILET PAPER	ALL BLOCKING TO BE PT IN SHOWERS
	4-0"	TOWEL BAR TOILET PAPER ROLL A" 4" 4" MINMIN.

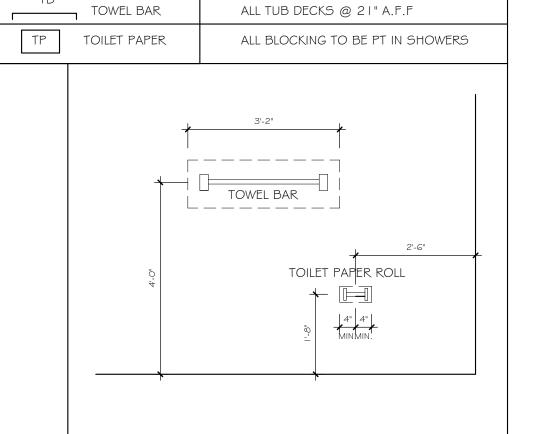

BATHROOM NOTES

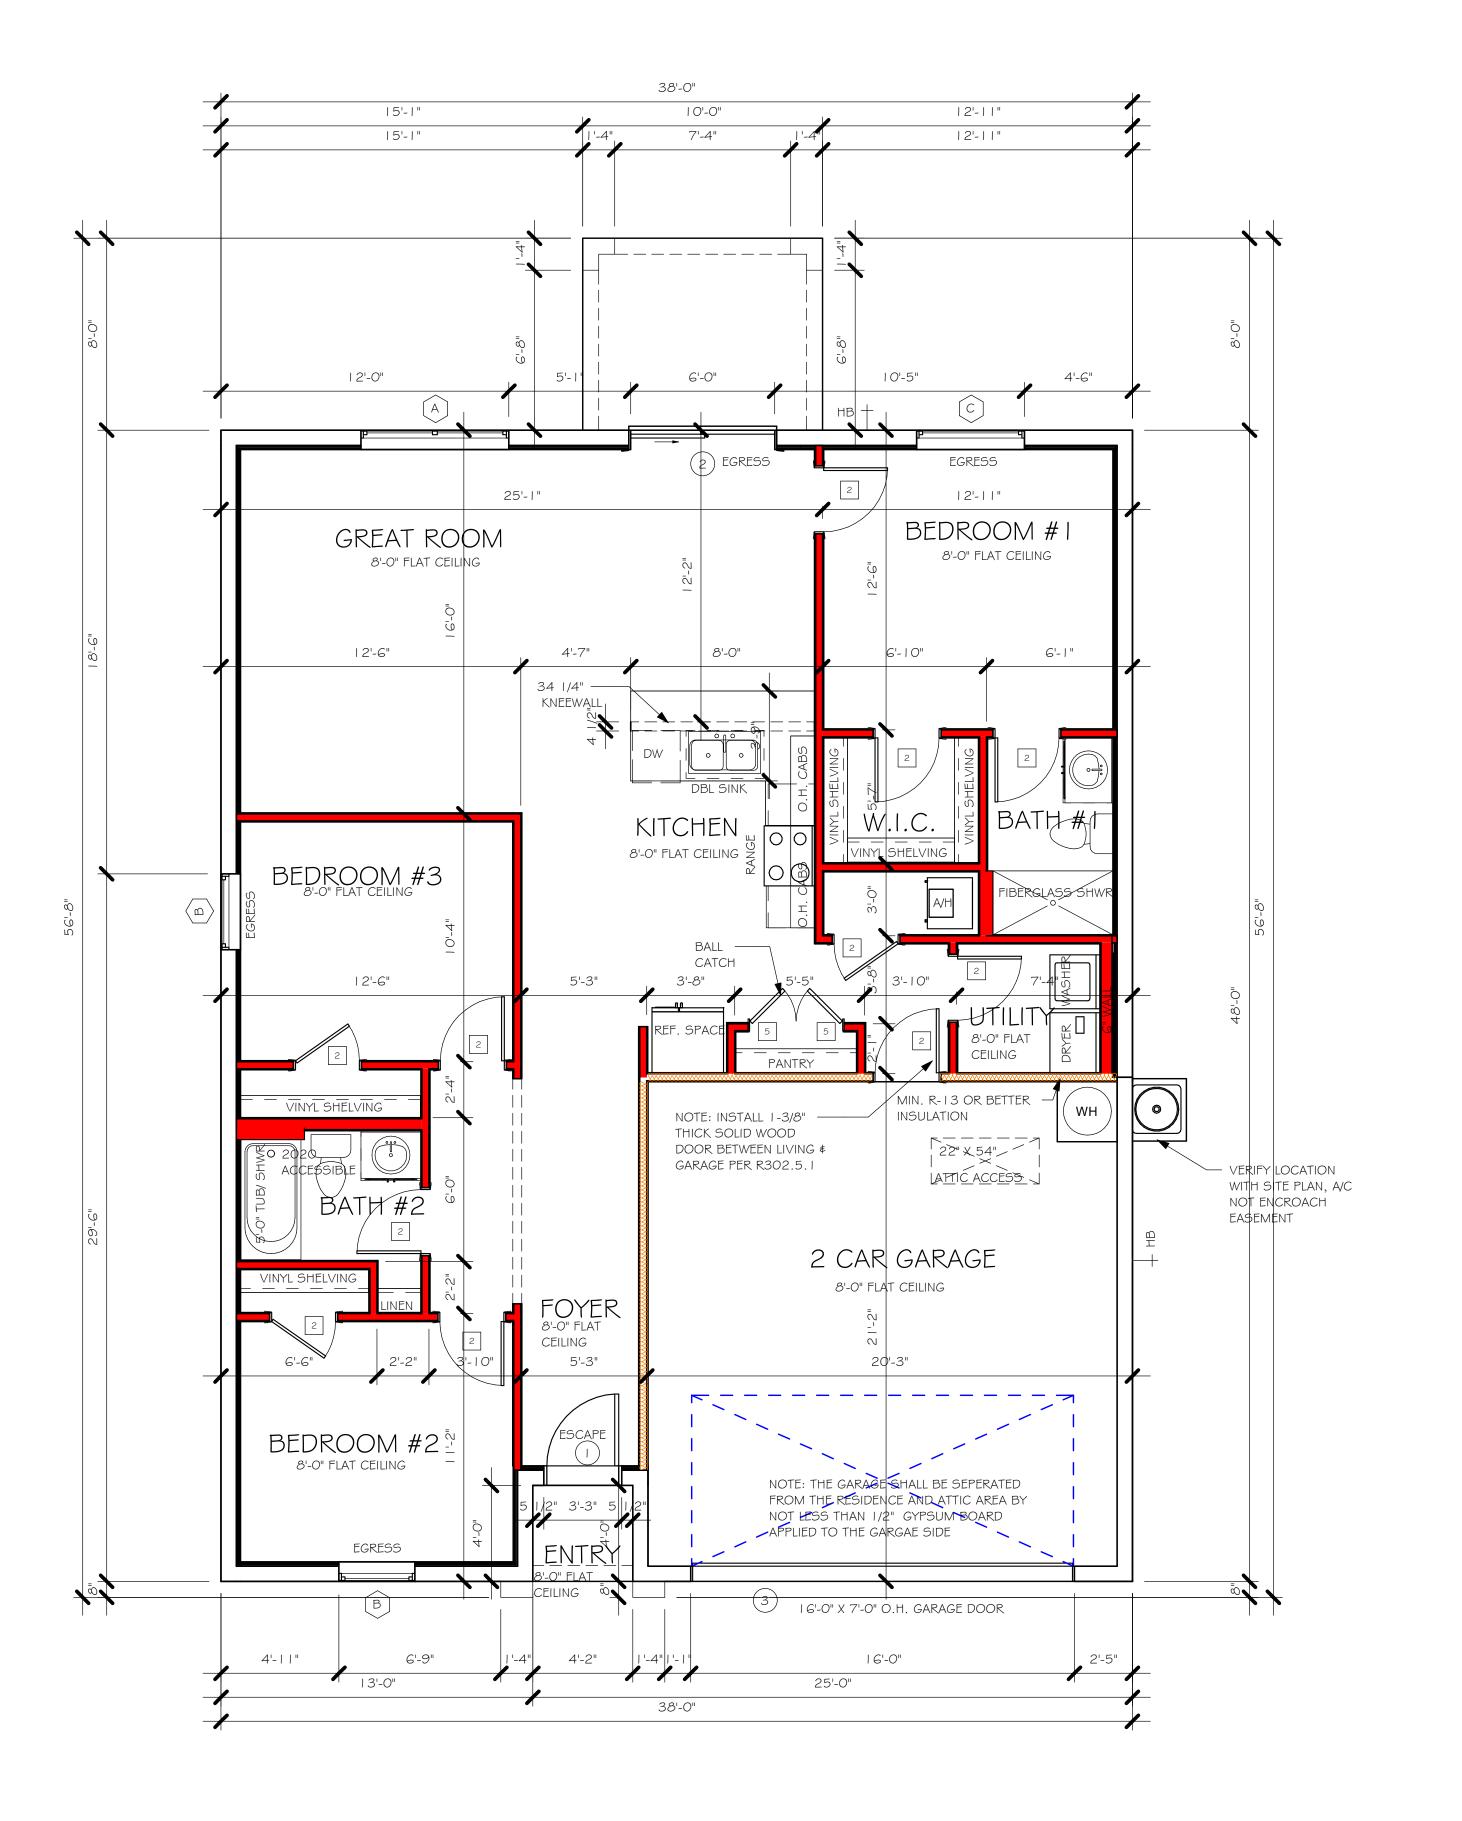

FLOOR PLAN 1/4" = 1'-0"

> DESIGN IN ACCORDANCE WITH THE RESIDENTIAL FLORIDA BUILDING CODE 2020 - 7TH EDITION

FACE OF EXTERIOR WALL —

DATE:

DRAWN BY:

CHECKED BY:

REVISED:

SCALE:

07/23/21

CWL

JWC

FLOOR

As indicated

ROOF PLAN 1/4" = 1'-0"

MODEL 1389 B: ATTIC VENTILATION FBCR R806 COORDINATE VENTING REQUIREMENTS WITH ENERGY CALCULATIONS SOFFIT ONLY (1/150) (NO ROOF VENTS) WITH ROOF VENTS (1/300) (R.V.) AREAS (SQ. FT.) ATTIC VENTILATION REQUIRED ATTIC VENTILATION REQUIRED ATTIC AREA/150 | REQ'D AIR FLOW | QUAD 4 SOFFIT | HAS | 13.33 SQ. FT. | 7.57% | 8.15% ATTIC AREA/300 QUANTITY OF ROOF VENTS MIN AIR FLOW OF SOFFIT MARK ATTIC SOFFIT 1st STORY 2000.0 SQ. FT. 176.0 SQ. FT. -.-- SQ. FT. -"SOFFIT ONLY" QUALIFIES ROOF VENTS ARE NOT REQUIRED ROOF VENT MODEL SOFFIT MODEL ACM QUAD 4, FULL VENT, NARROW PATTERN, 8.15% FREE AIR FLOW LOMANCO 770-D 0.97 SQ. FT. FREE AIR WALL HEIGHT

= WALL @ 8'-0"

BEDROOM #3 2 CAR GARAGE FOYER 8'-0" FLAT CEILING

MODEL

DATE:

DRAWN BY:

CHECKED BY:

REVISED:

PLAN:

SCALE:

07/23/21

CWL

JWC

ROOF

As indicated

A-4

DESIGN IN ACCORDANCE WITH THE RESIDENTIAL FLORIDA BUILDING CODE 2020 - 7TH EDITION

	4-PLEX RECEPTACLE OUTLET
\ominus	DUPLEX RECEPTACLE OUTLET
\ominus	1/2 SWITCHED DUPLEX OUTLET
AFF	DUPLEX RECEPTACLE AT ELEV. A.F.F.
$\overline{}$	DUPLEX RECEPTACLE - ABOVE COUNTER
Θ	SINGLE POLE SWITCH
() 3	3 WAY SWITCH
() □	DIMMER SWITCH
₩ ^S	MOTION SENSOR SWITCH
SD SCD	AC/DC SMOKE DETECTOR TO BE INTERCONNECTED ANY RESIDENT HAVING A FOSSIL-BURNING HEATER OR APPLIANCE, A FIREPLACE, OR AN ATTACHED GARAGE SHALL HAVE AN OPERATIONAL CARBON MONOXIDE ALARM INSTALLED WITHIN 10 FEET OF EACH ROOM USED FOR SLEEPING PERPOSES. PER RULE 9B-3.04.72 SD (SMOKE DETECTOR) SCD (CARBON MONOXIDE/ SMOKE DETECTOR)
-[TELEPHONE OUTLET
-TV	TELEVISION RECEPTION OUTLET
<u></u>	SURFACE MOUNTED CEILING LIGHT
	FLUSH MOUNTED LIGHT
Ю	WALL MTD. BRACKET LIGHT
46	DUPLEX FLOOD LIGHT
	EXHAUST FAN
	TRACK MTD. LIGHTS
마	A/C DISCONNECT
Ю	PUSH BUTTON (PB) / DOOR BELL (DB)
(10)	INTERCOM
	KEYPAD
<u> </u>	4' FLUORESCENT LIGHT
<u> </u>	2' UNDER COUNTER LIGHT
NOTE: NO	2' UNDER COUNTER LIGHT OT ALL SYMBOLS ARE USED FOR THIS
ARC-FAUL RESISTAN IN DWELLI ALL ELECT OR ABOV	LT CIRCUIT-INTERRUPTERS AND TAMPER IT RECEPTACLES SHALL BE INSTALLED ING UNITS PER N.E.C 210.12 AND 406.11 IRIC, ELECTRICAL EQUIPMENT AND APPLIANCES TO BE SET AT 'E BASE FLOOD ELEVATION PLUS 1'-0" FREEBOARD. ETS IN WET AREAS AND ALL

EXTERIOR OUTLETS TO BE GFI'S.

INSTALL PHONE AND T.V PER CONTRACT.

INSTALL ALL ELECTRICAL PER NEC 2014

ELECTRICAL LEGEND

ELECTRICAL METER

I 20 V JUNCTION BOX


SINGLE RECEPTACLE OUTLET


220 V RECEPTACLE OUTLET

ELECTRICAL PANEL

ELECTRICAL PLAN 1389

	ELECTRIC	AL PLAN 1389	
200	AMP SERVICE		
4G	QUANTITY	PRODUCT	
Α	(X)	(FLUSH MOUNTED LT)	
A B C	(X)	(VAPORS)	
С	(X)	(PENDANT LIGHT	
D	(10)	(10" MUSHROOMS)	
D E F	(2)	(24" 3 LT)	
F	(X)	(36" 4 LT)	
G	(X)	(NOT USED)	
Н	(2)	(COACH LIGHTS)	
1	(X)	(COACH LIGHTS)	
	(X)	(J BOX)	
J K	(1)	(4' FLUORESCENT)	
L	(X)	(2' FLUORESCENT)	
M	(X)	(5LT CHANDELIER)	
Ν	(X)	(3 LT)	
O	(X)	(PENDANT/ NOOK)	
Р	(X)	(X)	
Q	(X)	(X)	

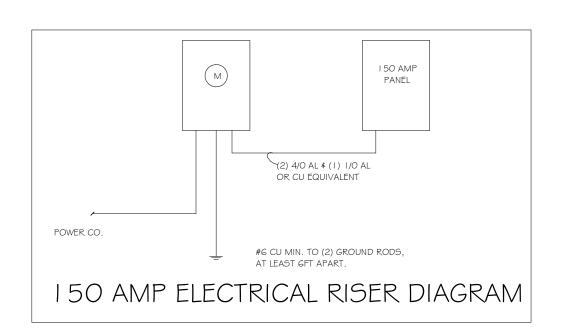

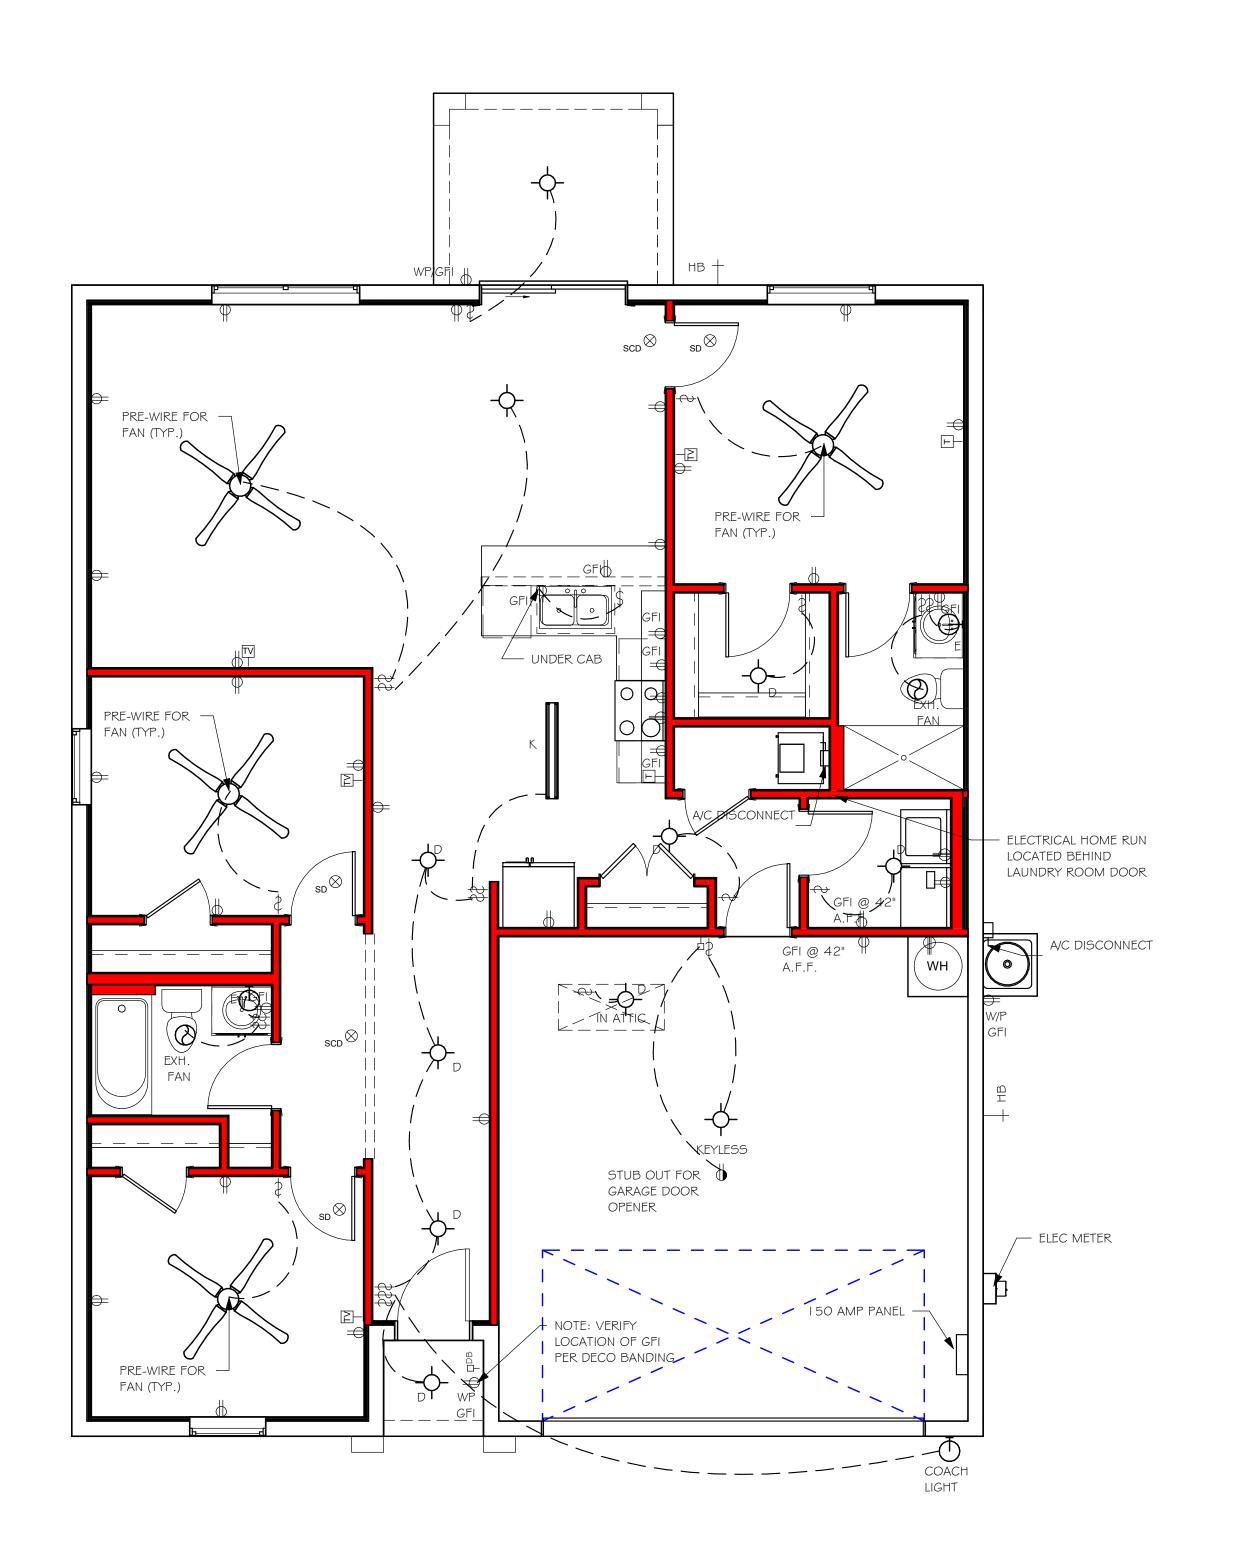



DESIGN IN ACCORDANCE WITH THE RESIDENTIAL FLORIDA BUILDING CODE 2020 - 7TH EDITION

DATE:

DRAWN BY:

CHECKED BY:

REVISED:

PLAN:

SCALE:


07/23/21


CWL

JWC


ELECTRIC

As indicated

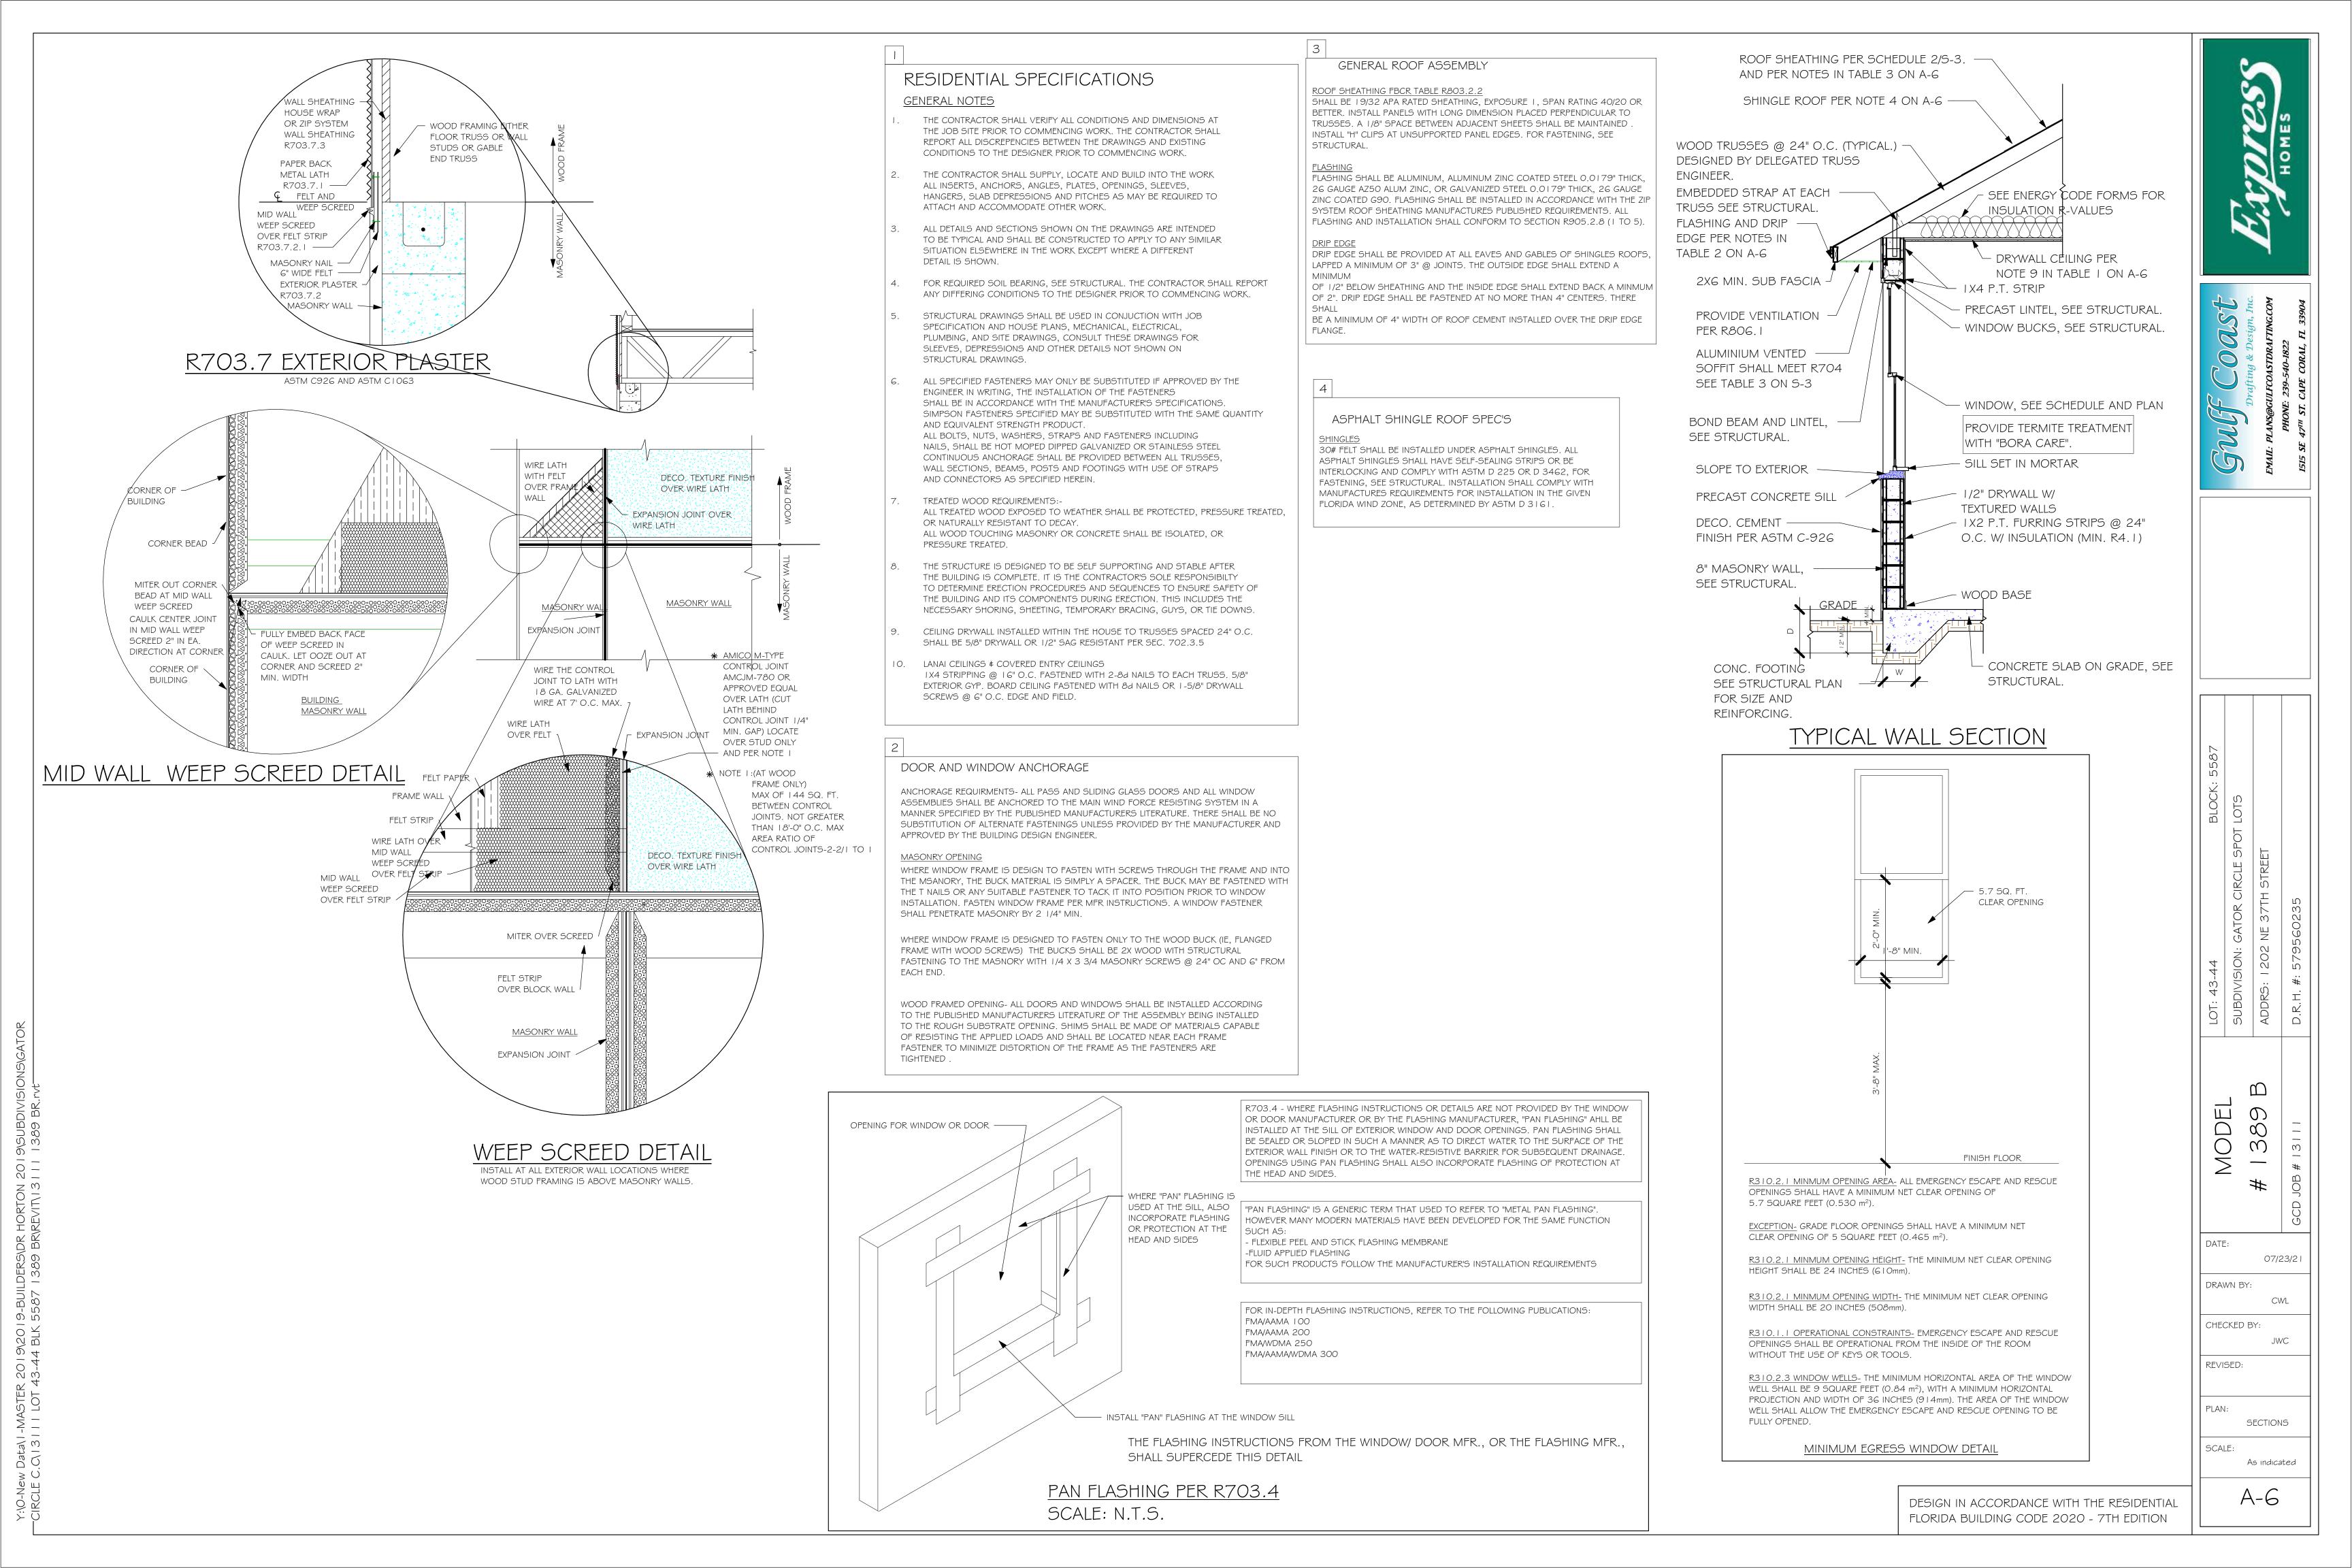


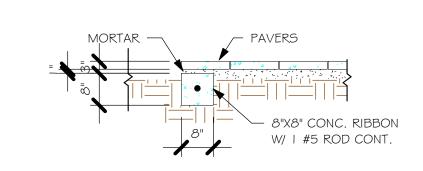


 $\frac{\text{"P" PAVERS DETAIL ENTRY/ LANAI}}{1/2" = 1'-0"}$

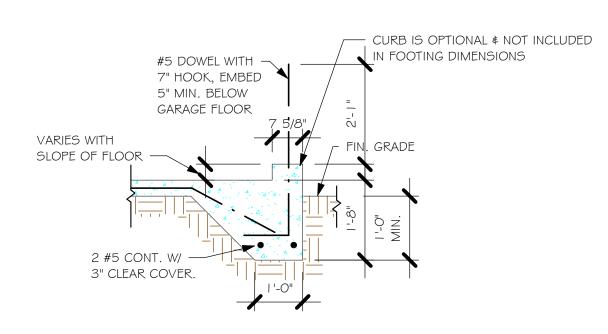



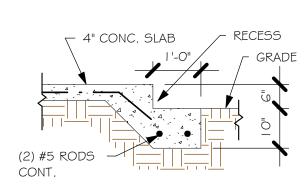

 $\frac{\text{GARAGE DOOR RECESS}}{1/2" = 1'-0"}$

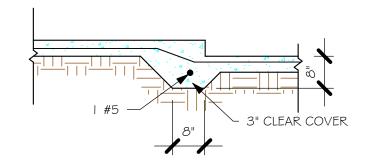

 $\frac{\text{"F6A" STEP DOWN}}{1/2\text{"} = 1\text{'-0"}}$

		PAD FOOTING SCHEDULE										
ü		BOTTOM REINF.				OM REINF.	D=144D1/0					
USED	TYPE	LENGTH	WIDTH	DEPTH	LONG WAY	SHORT WAY	REMARKS					
X	(A)	2'-6"	2'-6"	1'-0"	3-#5	3-#5	-					
	B	3'-0"	3'-0"	1'-0"	4-#5	4-#5	-					
	(C)	3'-6"	3'-6"	1'-0"	4-#5	4-#5	-					
	(D)	4'-0"	4'-0"	1'-2"	5-#5	5-#5	-					
	(E)	5'-0"	5'-0"	1'-2"	6-#5	6-#5	-					

	WALL FOOTING SCHEDULE									
USED	TYPE	LENGTH	WIDTH	DEPTH	BOTTOM REINFORCING	SHAPE				
	F1	CONT.	1'-4"	0'-8"	2-#5					
	F2	CONT.	1'-8"	0'-10"	2-#5]			
X	F3	CONT.	1'-0"	1'-8"	2-#5		ADD CURB GARAGE, S DETAIL			
	F4	CONT.	1'-4"	1'-8"	2-#5	\vdash	DETAIL			
	F5	CONT.	1'-4"	1'-0"	2-#5	—				
	F6	CONT.	1'-4"	1'-0"	2-#5		1			
X	F6A	CONT.	0'-8"	0'-8"	1-#5					

1-#5


PROVIDE CORNER BARS PER 6/S-3



SCALE: 1/4" = 1'-0"

- PLAN NOTES:
 1. TOP OF GROUND FLOOR SLAB DATUM ELEVATION 0'-0"
- 2. "F#" DENOTES CONTINUOUS WALL FOOTING TYPE PER SCHEDULE THIS SHEET.
- PROVIDE #5 VERTICAL REINFORCING AT DOT LOCATIONS SHOWN ON PLAN FROM FOOTING TO BOND BEAM.
 ALL DIMENSIONS ARE TO OUTSIDE FACE OF MASONRY WALLS. SOME SLAB EDGES MAY
- EXTEND BEYOND FACE OF WALL.

 FOR DIMENSIONS OF ROUGH OPENINGS IN MASONRY WALLS, COORDINATE WITH WINDOW/
- DOOR SUPPLIER.
 6. PROVIDE PRESSURE TREATED BUCKS AT WINDOWS/ DOORS PER DETAIL 7/S-3.

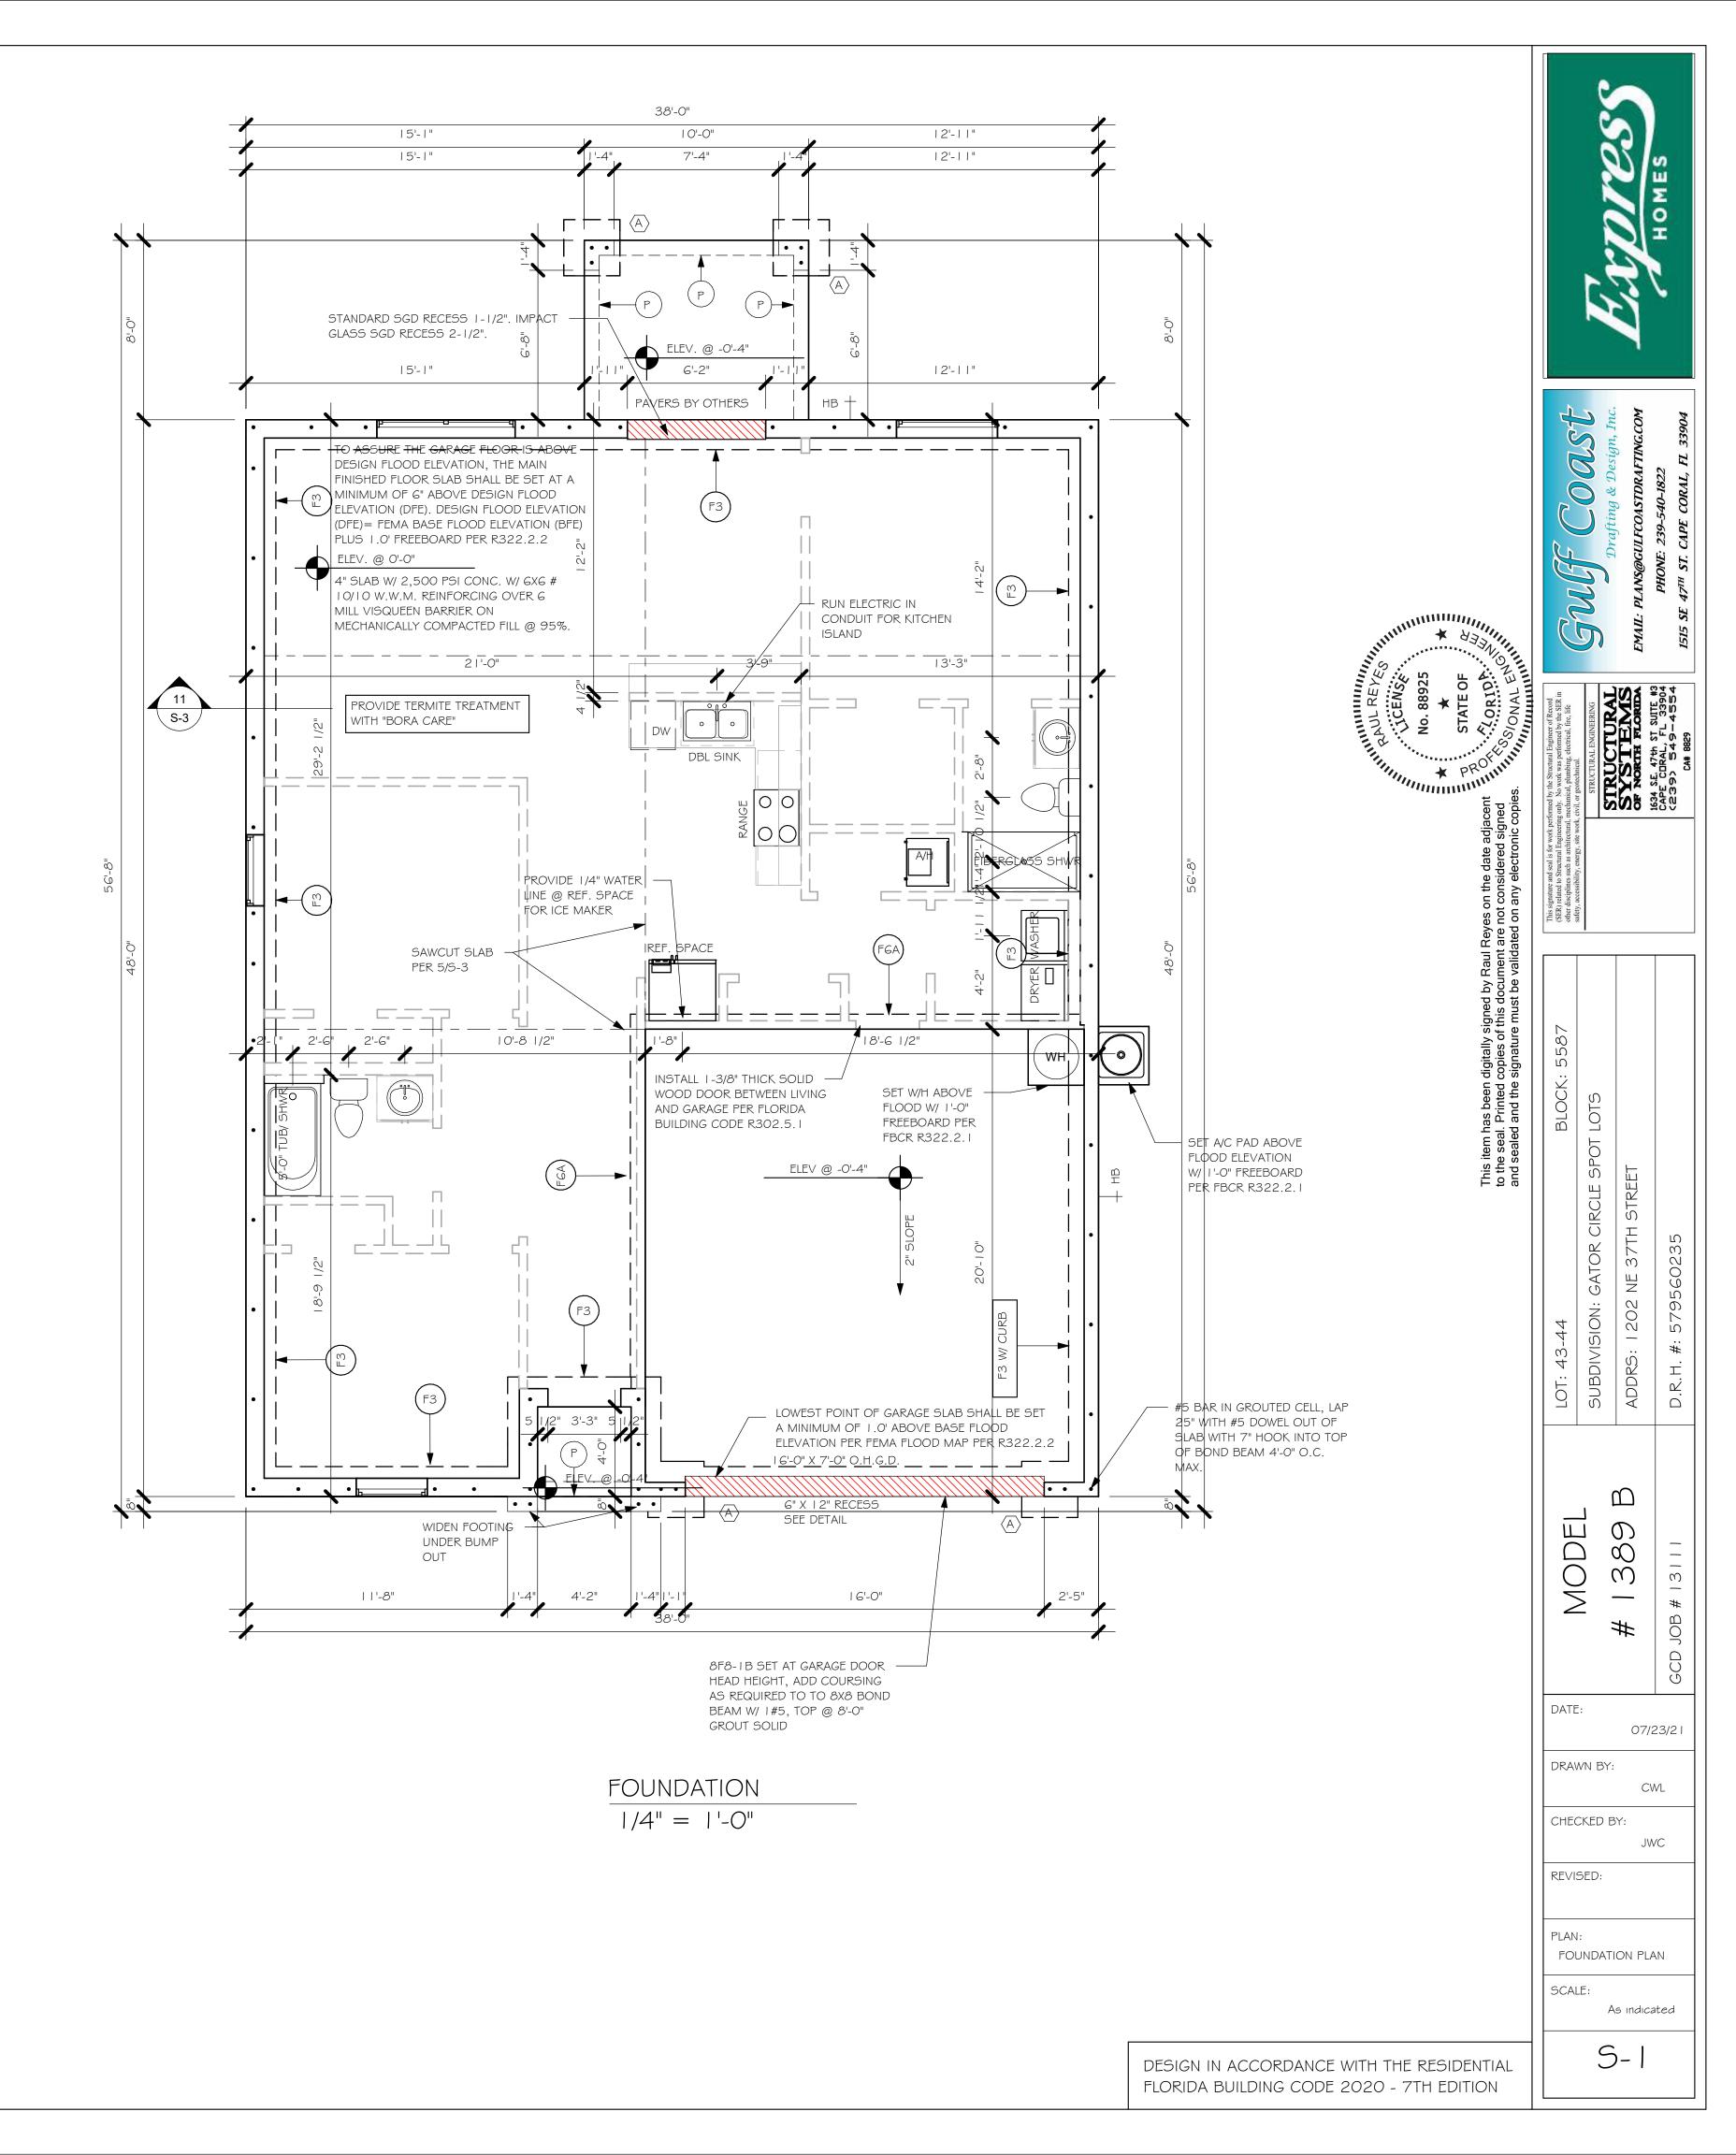

META 16 AT

TRUSSES

HIGHER

UPLIFTS,


ON PLAN.

SEE NOTES

UPLIFT. FOR


- I. PROVIDE A STRAP FROM THE ABOVE LIST AT EACH ROOF TRUSS BEARING POINT. BASED ON THE TRUSS UPLIFT VALUES IN THE SIGNED AND SEALED TRUSS DESIGN PACKAGE AND SUITABLE FOR THE GEOMETRY. EMBED STRAP ON CENTERLINE OF WALL.
- ANY OF THE VALID LENGTHS SHOWN MAY BE USED IN PLACE OF THE LENGTH SPECIFIED ON PLAN.
- CONNECTORS ARE SIMPSON STRONG TIE. ALL CONNECTORS SHALL BE INSTALLED IN STRICT ACCORDANCE WITH SIMPSON PRINTED INSTUCTIONS. SUBSTITUTIONS MUST BE APPROVED IN WRITING BY THE ENGINEER OF RECORD.
- 4. WHERE EMBEDDED STRAPS ARE MISSING, OR MIS-LOCATED, INSTALL RETROFIT STRAP PER 10/S-3. PER UPLIFT IN TRUSS ENGINEERING.

SIMPSON CATALOG C-C- 2019

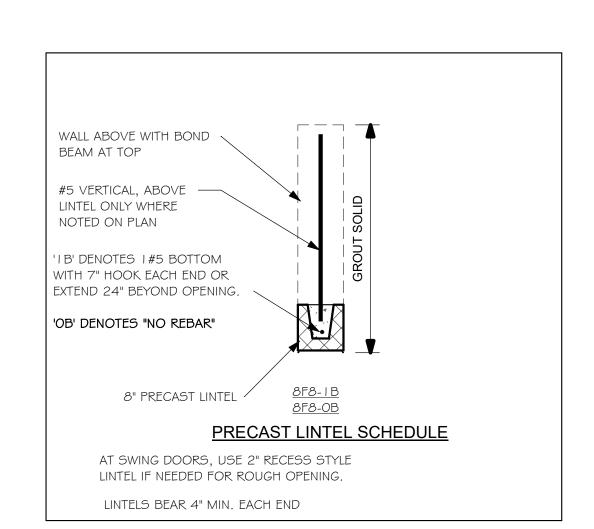

PLAN NOTES:


- ROOF TRUSS BEARING @ 8'-0".
- ROOF FRAMING SHALL BE WOOD TRUSSES DESIGNED BYA DELEGATED TRUSS ENGINEER PER DESIGN CRITERIA ON SHEET S-3.
- PROVIDE STRAPPING AT TRUSSES PER NOTES ON THIS
- FOR NAILING OF ROOF AND FLOOR DECK, SEE | AND 2
- ON 5-3.
- 8F8-1B etc., DENOTES PRECAST LINTEL ABOVE DOORWINDOW OPENING PER SCHEDULE THIS SHEET. AT TRUSS BEARING, PROVIDE 8x8 MASONRY BOND BEAM W/ I #5 CONTINUOUS, SEE DETAIL I I/S-3.

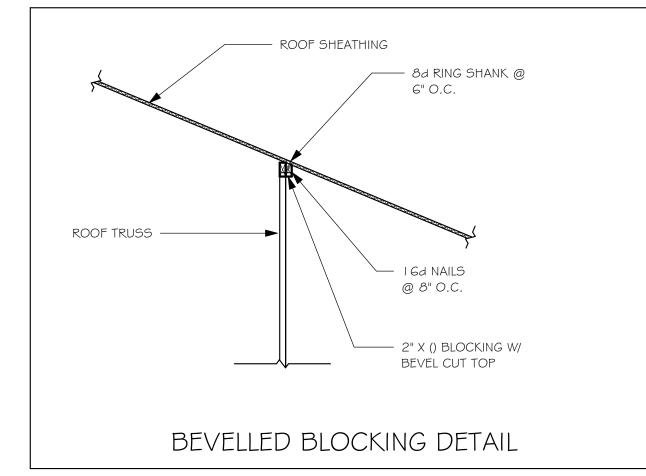

TRUSS BEARING CONDITIONS AND STRAPPING IS BASED ON TRUSS LAYOUT PREPARED BY SCOSTA JOB#: DR | 389BL DATED: | 1/30/20 REVISED: NONE

BEARING HEIGHT

= BEARING @ 8'-0"

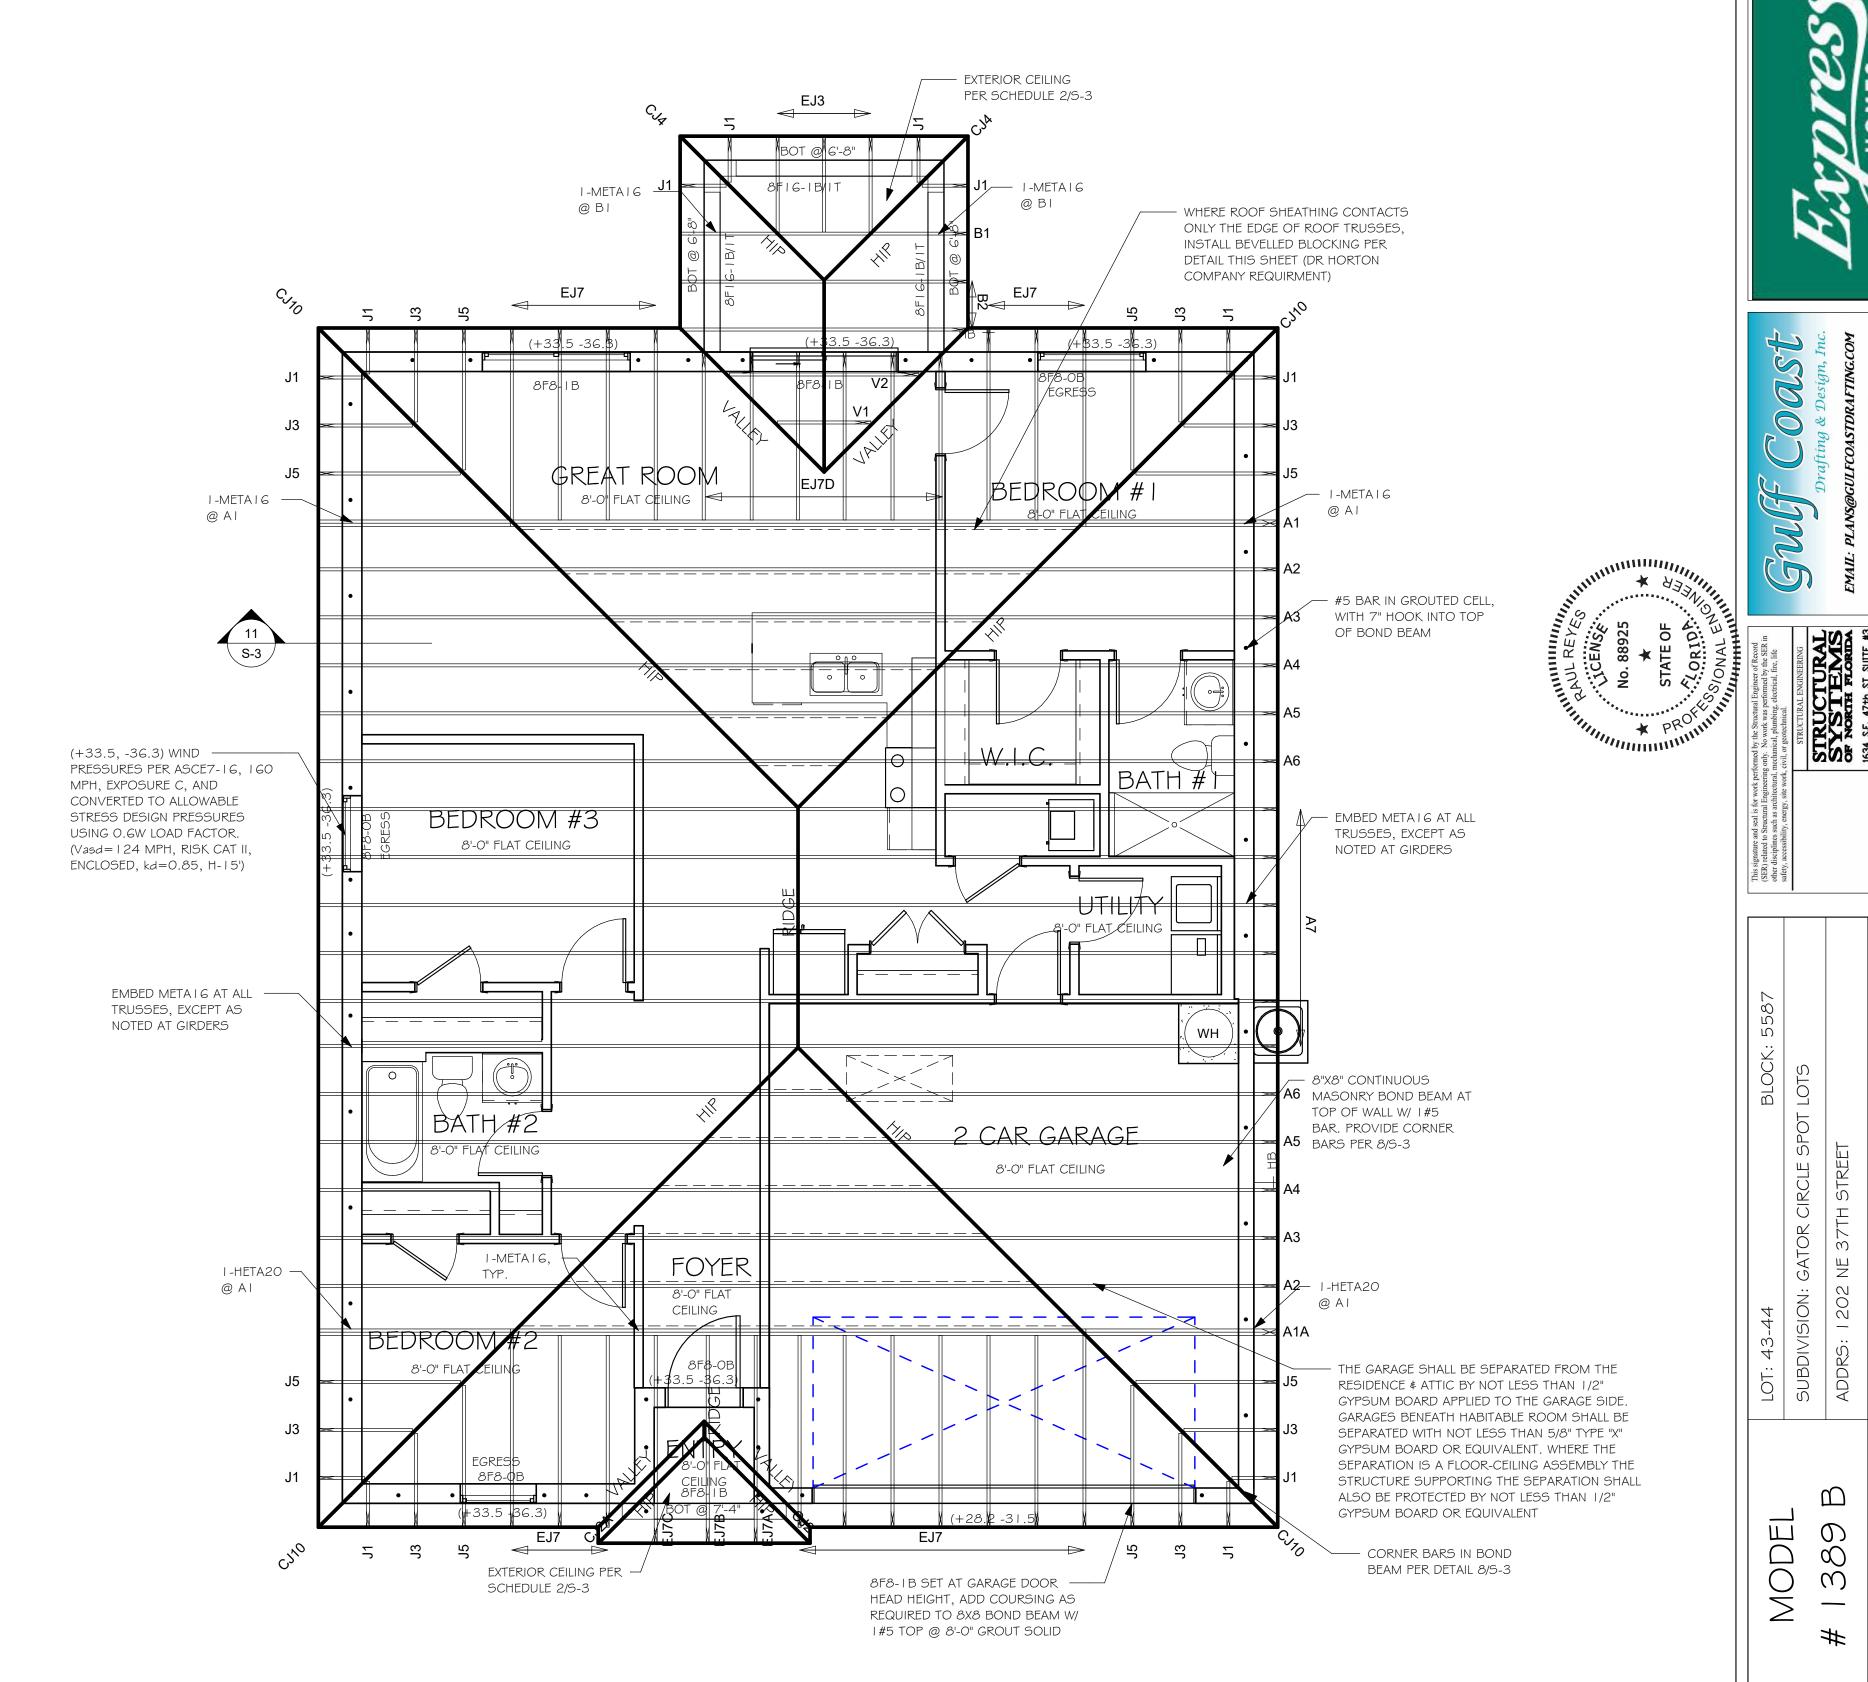

ROOF FRAMING PLAN 1/4" = 1'-0"

ROOF FRAMING PLAN SCALE: As indicated FLORIDA BUILDING CODE 2020 - 7TH EDITION

 \mathcal{O}

 \mathcal{C}

07/23/21

CWL

JWC

DATE:

DRAWN BY:

CHECKED BY:

REVISED:

DESIGN IN ACCORDANCE WITH THE RESIDENTIAL

