


VANITY SINK CLEARANCE DETAIL

36" MAX.

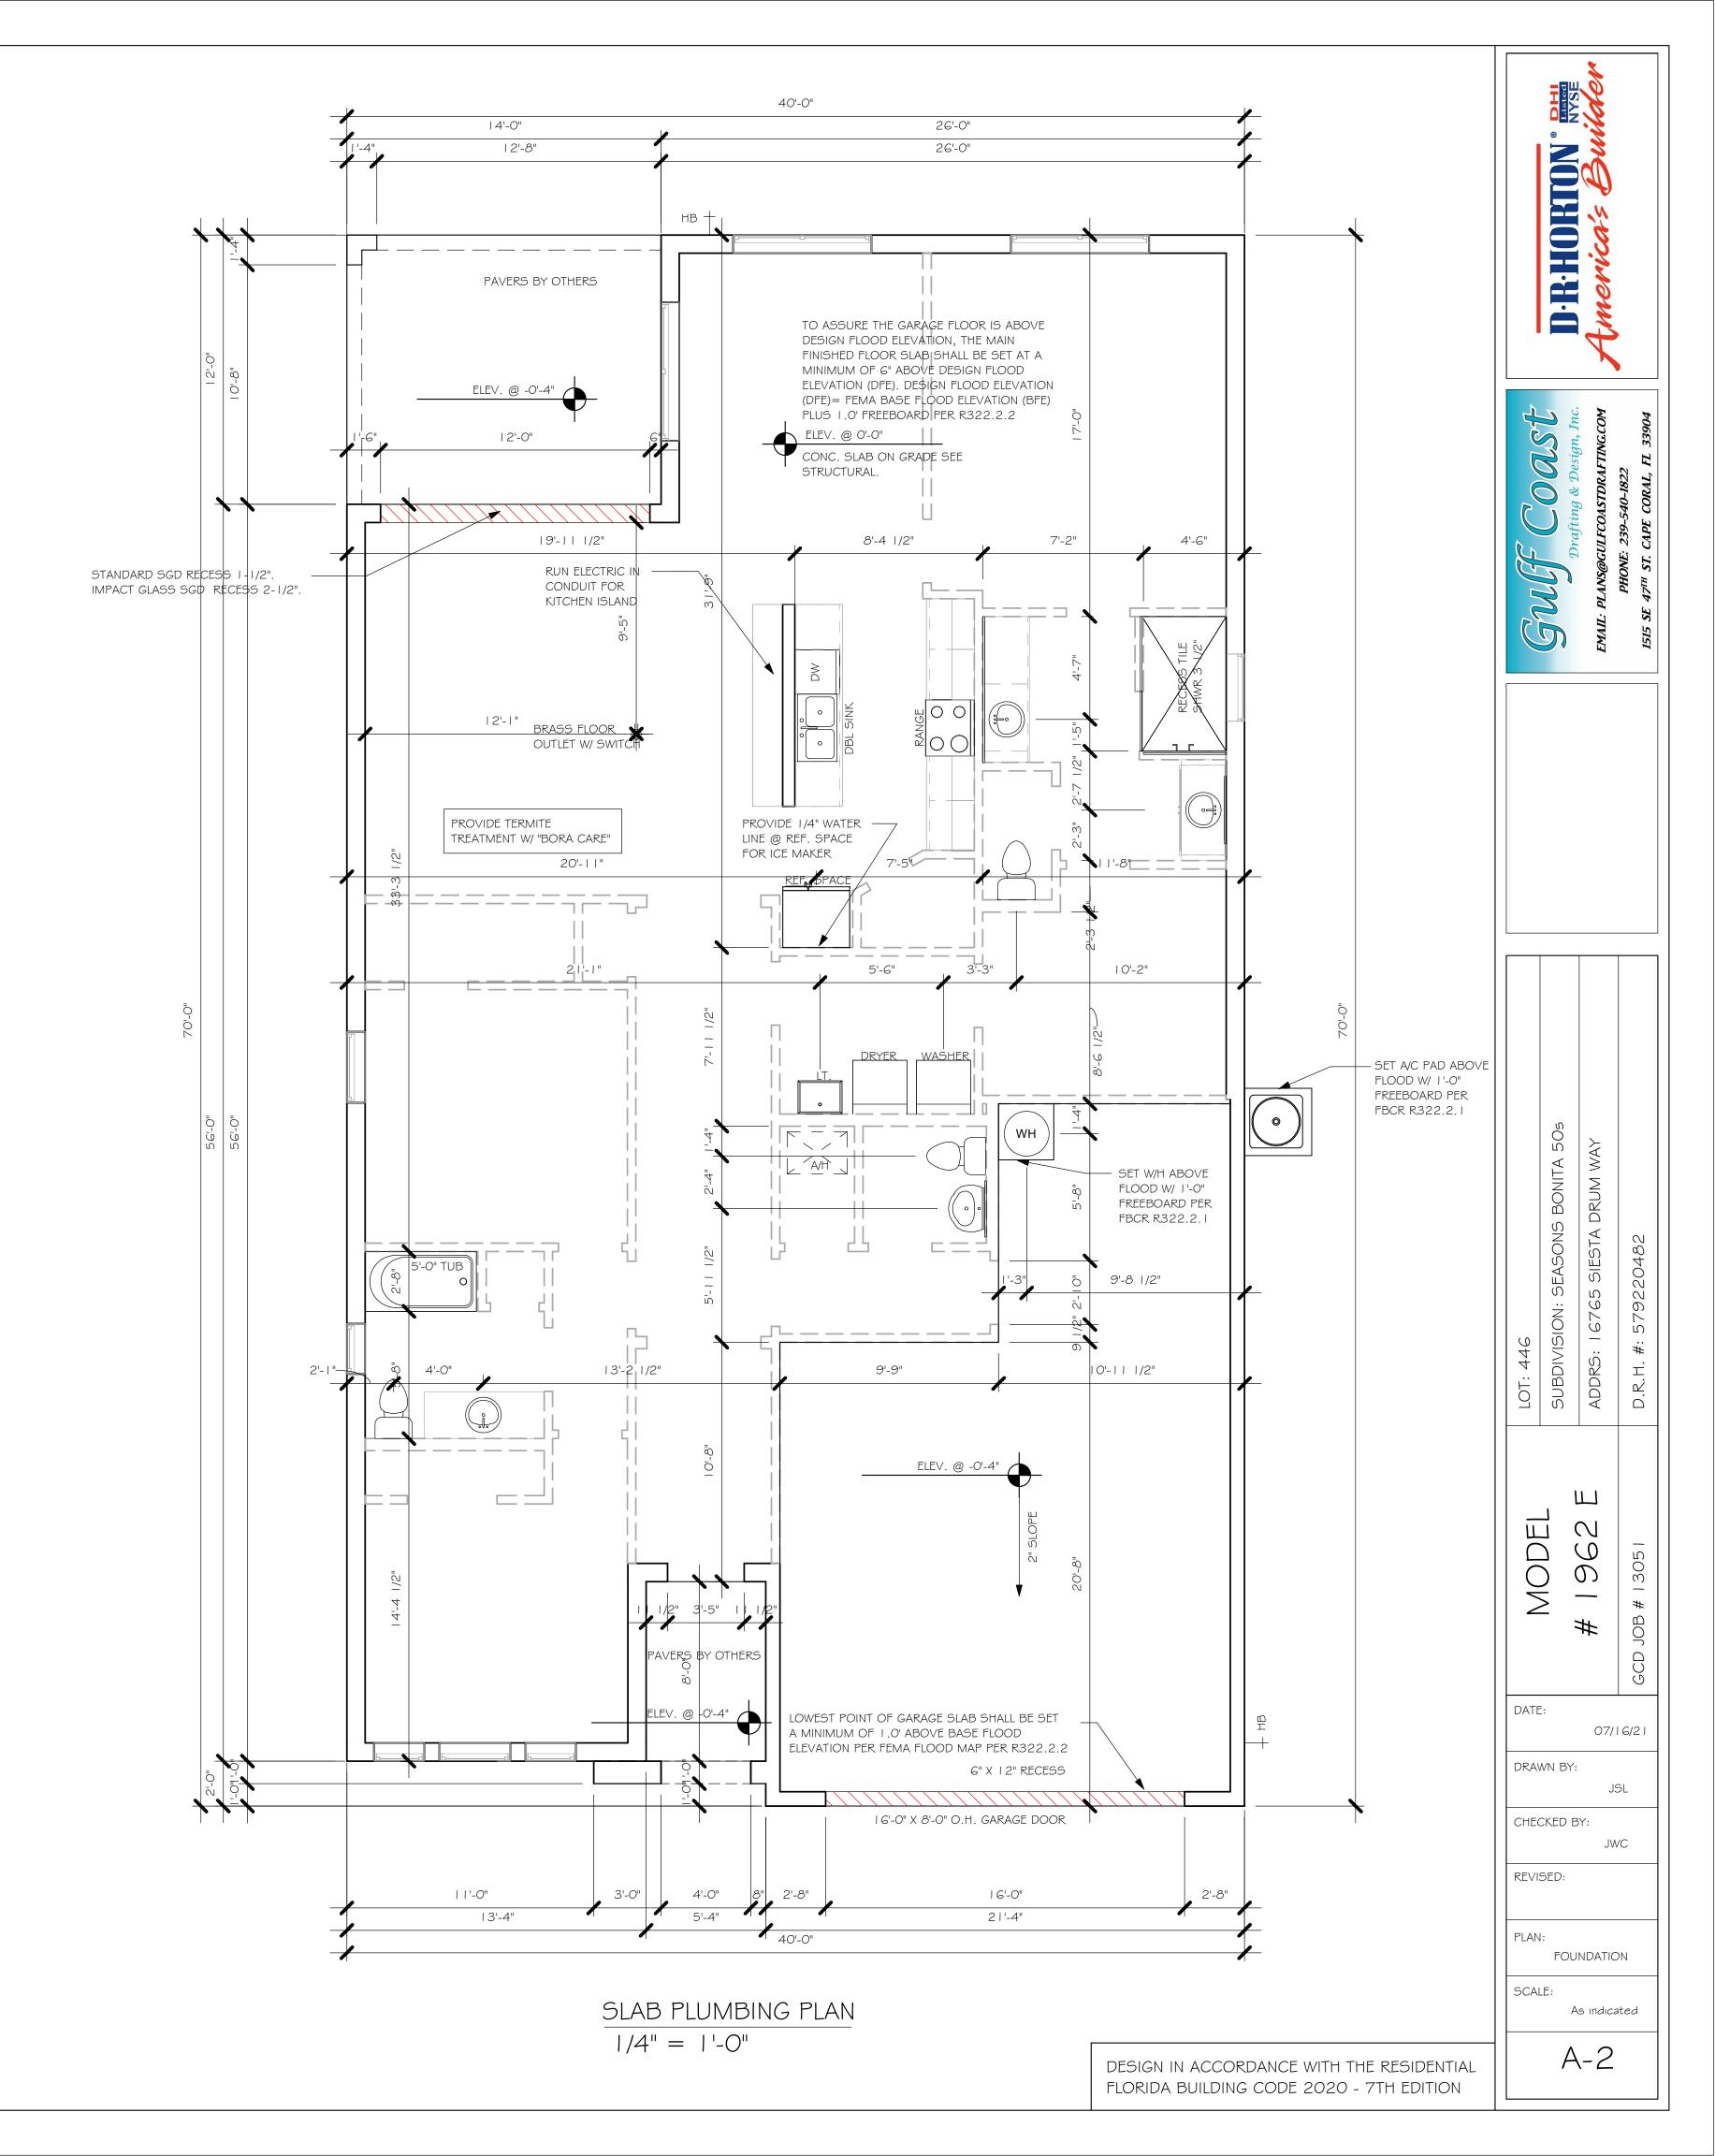

	DOOR SCHEDULE						
TYPE MARK	DESCRIPTION	MANUFACTURER	HEIGHT	WIDTH	COMMENTS	QTY	
			•	•			
1	3080 ENTRY	DISTINCTION	8'-0"	3'-0"		1	
2	(3)-4080 SL. GL. DR.	DISTINCTION	8'-0"	12'-0"			
3	16080 OHGD	GARAGE DOOR	8'-0"	16'-0"		1	

	WINDOW SCHEDULE						
MARK	DESCRIPTION	HEIGHT	WIDTH	COMMENTS	QTY		
Α	1/2 34 SH	4'-5"	2'-5"		1		
В	1/2 35 SH	5'-5"	2'-5"		2		
С	25 SH	5'-5"	3'-4"		2		
D	2-25 SH	5'-3"	6'-4"		3		
E	12" X 36" FIXED GLASS	1'-2"	3'-2"		1		

OPT. IMPACT GLASS MAY BE INSTALLED IN LIEU OF SHUTTERS VERIFY W/ CONTRACT

DOOR HEADERS				
6'-8" BI-FOLD	HEADER HEIGHT	82" A.F.F.		
6'-8" SWING	HEADER HEIGHT	82 I/2" A.F.F.		
8'-0" SWING	HEADER HEIGHT	98 I/2" A.F.F.		

PLAN NOTES

- I) VERIFY ALL ROUGH OPENING DIMENSIONS FOR ALL WINDOWS AND DOORS
- 2) PROVIDE SAFETY GLAZING WITHIN 24" FROM EXIT PER FLORIDA BUILDING CODE R 308.4.2.
- 3) PROVIDE SAFETY GLAZING AT BATH/ SHOWER
- 4) NON BEARING INTERIOR FRAME WALLS SHALL BE FRAMED W/ WOOD OR METAL STUDS. SPACING SHALL

NOT EXCEED 24" O.C. (NON BEARING WALLS ONLY)

PER FLORIDA BUILDING CODE R 308.4.5.

- 5) PROVIDE DEAD WOOD IN ATTIC FOR OVERHEAD GARAGE DOOR HARDWARE
- 6) KITCHEN KNEE WALL TO BE FRAMED W/ TOP @ 34 1/2" A.F.F.
- 7) INSTALL SMOOTH WALLS IN KITCHEN AND ALL BATHROOM AREAS
- 8) WHERE DRYWALL CEILING IS APPLIED TO TRUSSES
 @ 24" O.C. USE 5/8" DRYWALL OR 1/2" SAG
 RESISTANT PER SEC. R702.3.5
- THE GARAGE SHALL BE SEPARATED FROM THE
 RESIDENCE & ATTIC BY NOT LESS THEN 1/2" GYPSUM
 BOARD APPLIED TO THE GARAGE SIDE. GARAGES
 BENEATH HABITABLE ROOMS SHALL BE SEPARATED
 WITH NOT LESS THAN 5/8" TYPE "X" GYPSUM BOARD
 OR EQUIVALENT. WHERE THE SEPARATION IS A
 FLOOR CEILING ASSEMBLY, THE STRUCTURE
 SUPPORTING THE SEPARTION SHALL ALSO BE
 PROTECTED BY NOT LESS THAN 1/2" GYPSOM BOARD
 OR EQUIVALENT
- 10) INSTALL I 3/8" THICK SOLID WOOD DOOR BETWEEN LIVING AND GARAGE PER FLORIDA BUILDING CODE R302.5.1.
- 11) ALL WINDOWS INSTALLED 72" ABOVE GRADE MUST COMPLY WITH R312.2 MIN 24" SILL HEIGHT OR PROVIDED WITH AN APPROVED WINDOW FALL PREVENTION DEVICE
- 12) ALL CLOSET SHELVES TO BE 12". ALL PANTRY \$
 LINEN TO BE (4)-16" SHELVES 18" O.F.F. W/ 15"
- 13) ALL MECHANICAL AND ELECTRICAL EQUIPMENT TO BE INSTALLED AT OR ABOVE FLOOD PLUS 1'-0" FREEBOARD.


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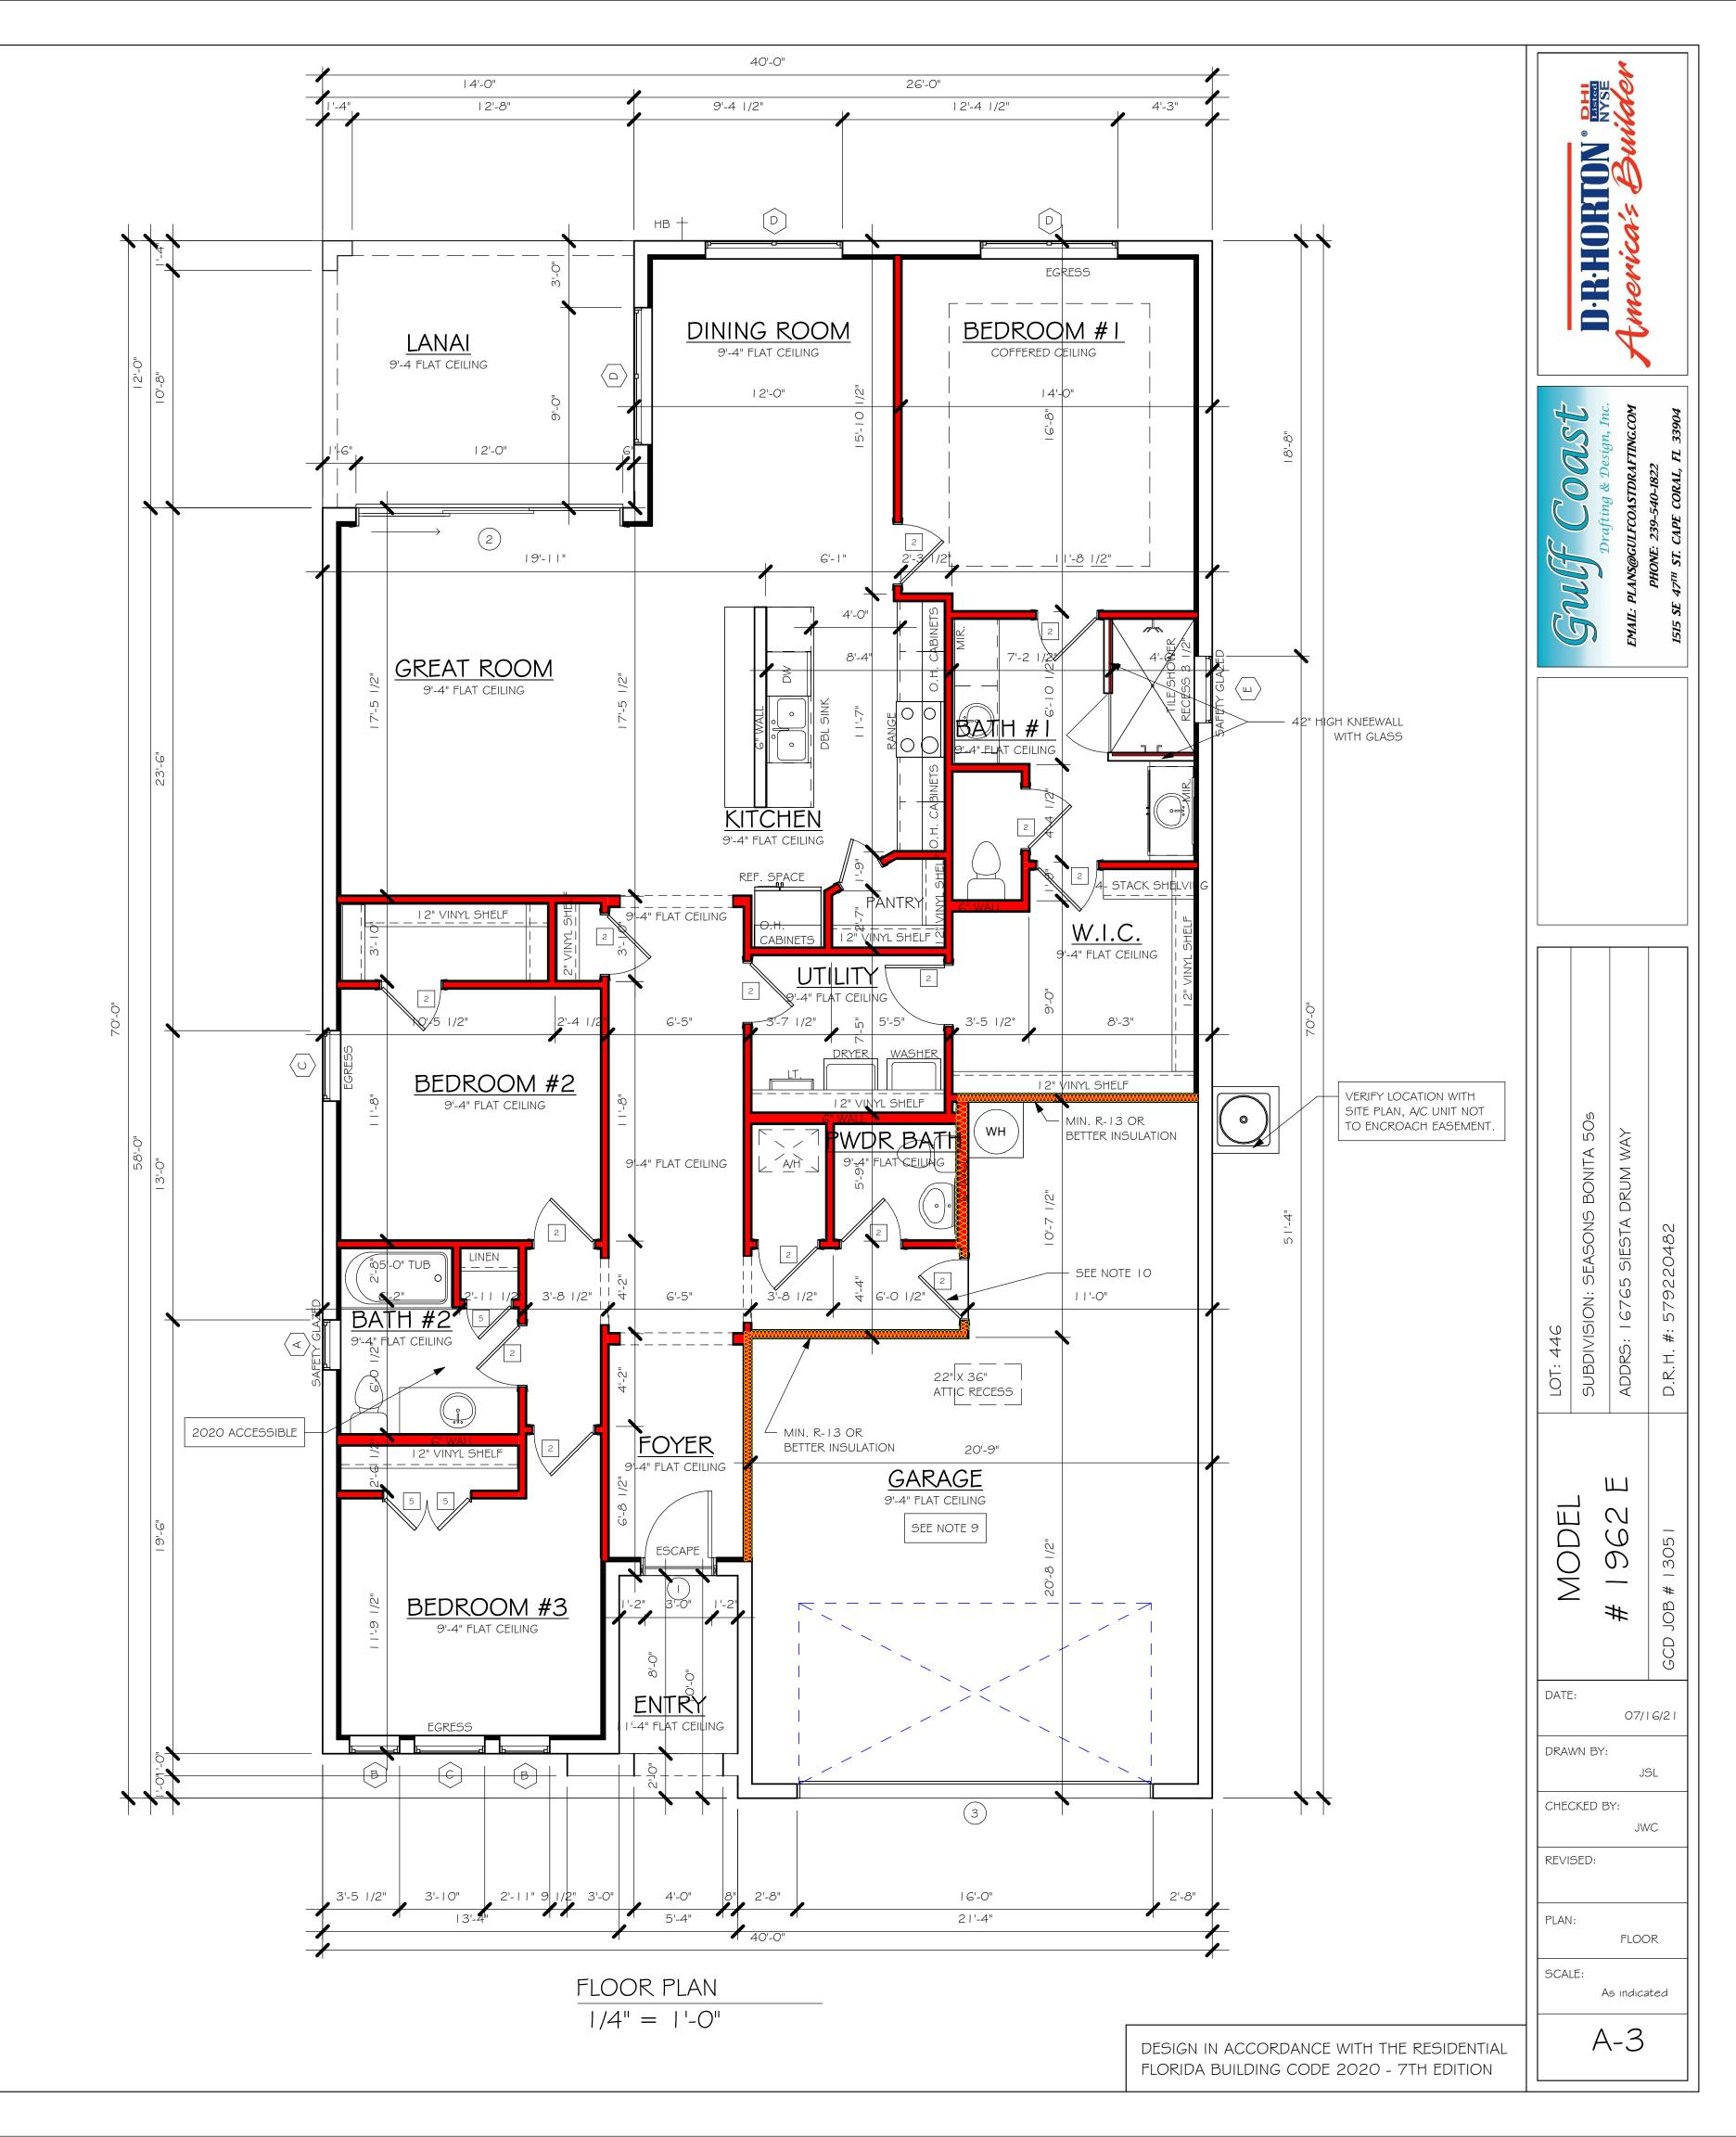
O 7	DITTEL DITTO	
KITCHEN	UPPER TOP @ 84"	BASE TOP @ 35"
MASTER BATH	UPPER	BASE TOP @ 35"
GUEST BATH	UPPER	BASE TOP @ 31"
LAUNDRY ROOM	UPPER TOP @ 84"	BASE

		BATHROOM NOTES
TB	TOWEL BAR	ALL TUB DECKS @ 21" A.F.F
TP	TOILET PAPER	ALL BLOCKING TO BE PT IN SHOWERS
	1.O.14	TOWEL BAR TOILET PAPER ROLL A" A" A" MINMIN:

SQUARE FOOTAGE				
ENTRY AREA	50 SF			
LANAI AREA	167 SF			
GARAGE AREA	552 SF			
LIVING AREA	2000 SF			
TOTAL SQAURE FOOTAGE	2769 SF			

INTERIOR DOOR SCHEDULE				
MARK	DOOR WIDTH	NOTES		
	3'-0"	P.K. = POCKET DOOR		
2	2'-8"	B.F. = BI-FOLD DOOR		
3	2'-6"	D.I. DITOLD DOOK		
4	2'-4"	B.P. = BI-PASS DOOR		
5	2'-0"	L.V. = LOUVERED DOOR		
6	1'-8"			
7	1'-6"			
8	2'-11"			




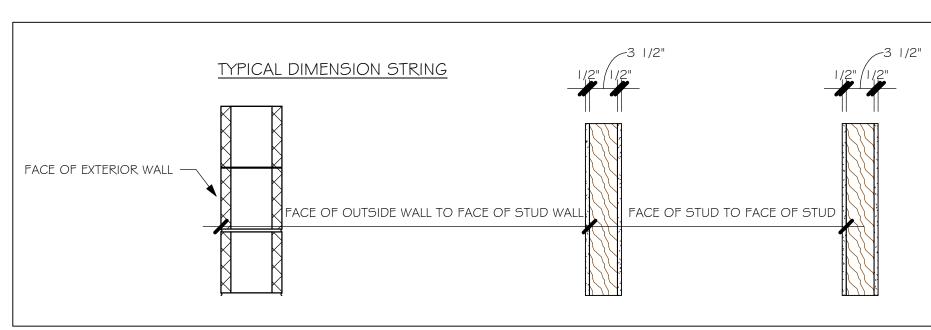

L:\O-New Data\I-MASTER 2019\2019-BUILDERS\DR HORTON —2019\SUBDIVISIONS\SEASONS BONITA 50's\13051 LOT 446 1962 ER\REVII

MC	DEL				VENTIL WITH ENERGY CALC		N FB	CR R806
				SOFFIT ONLY (NO ROOF VE		WI ⁻	ΓΗ ROOF VE (R.V.)	NTS (1/300)
AREAS (SQ. FT.)		FT.)	ATTIC VENTILATION REQUIRED		ATTIC VENTILATION REQUIRED		N REQUIRED	
MARK	ATTIC	SOFFIT	ATTIC AREA/150	REQ'D AIR FLOW OF SOFFIT	QUAD 4 SOFFIT HAS	ATTIC AREA/300	QUANTITY OF ROOF VENTS	MIN AIR FLOW OF SOFFIT
1st STORY	3066.0 SQ. FT.	297.0 SQ. FT.	20.44 SQ.FT.	6.88%	8.15%	SQ. FT.	-	%
			"SOF	FIT ONLY" QU	JALIFIES	ROOF	F VENTS ARE	E NOT REQUIRED
SOFFIT MODEL ACM QUAD 4, FULL VENT, NARROW PATTERN, 8.15% FREE AIR FLOW		TULL VENT, RN,	22-3/8" BASE	COOF VENT N 32" BAS COMANCO TO 0.97 SQ. F	770-D			



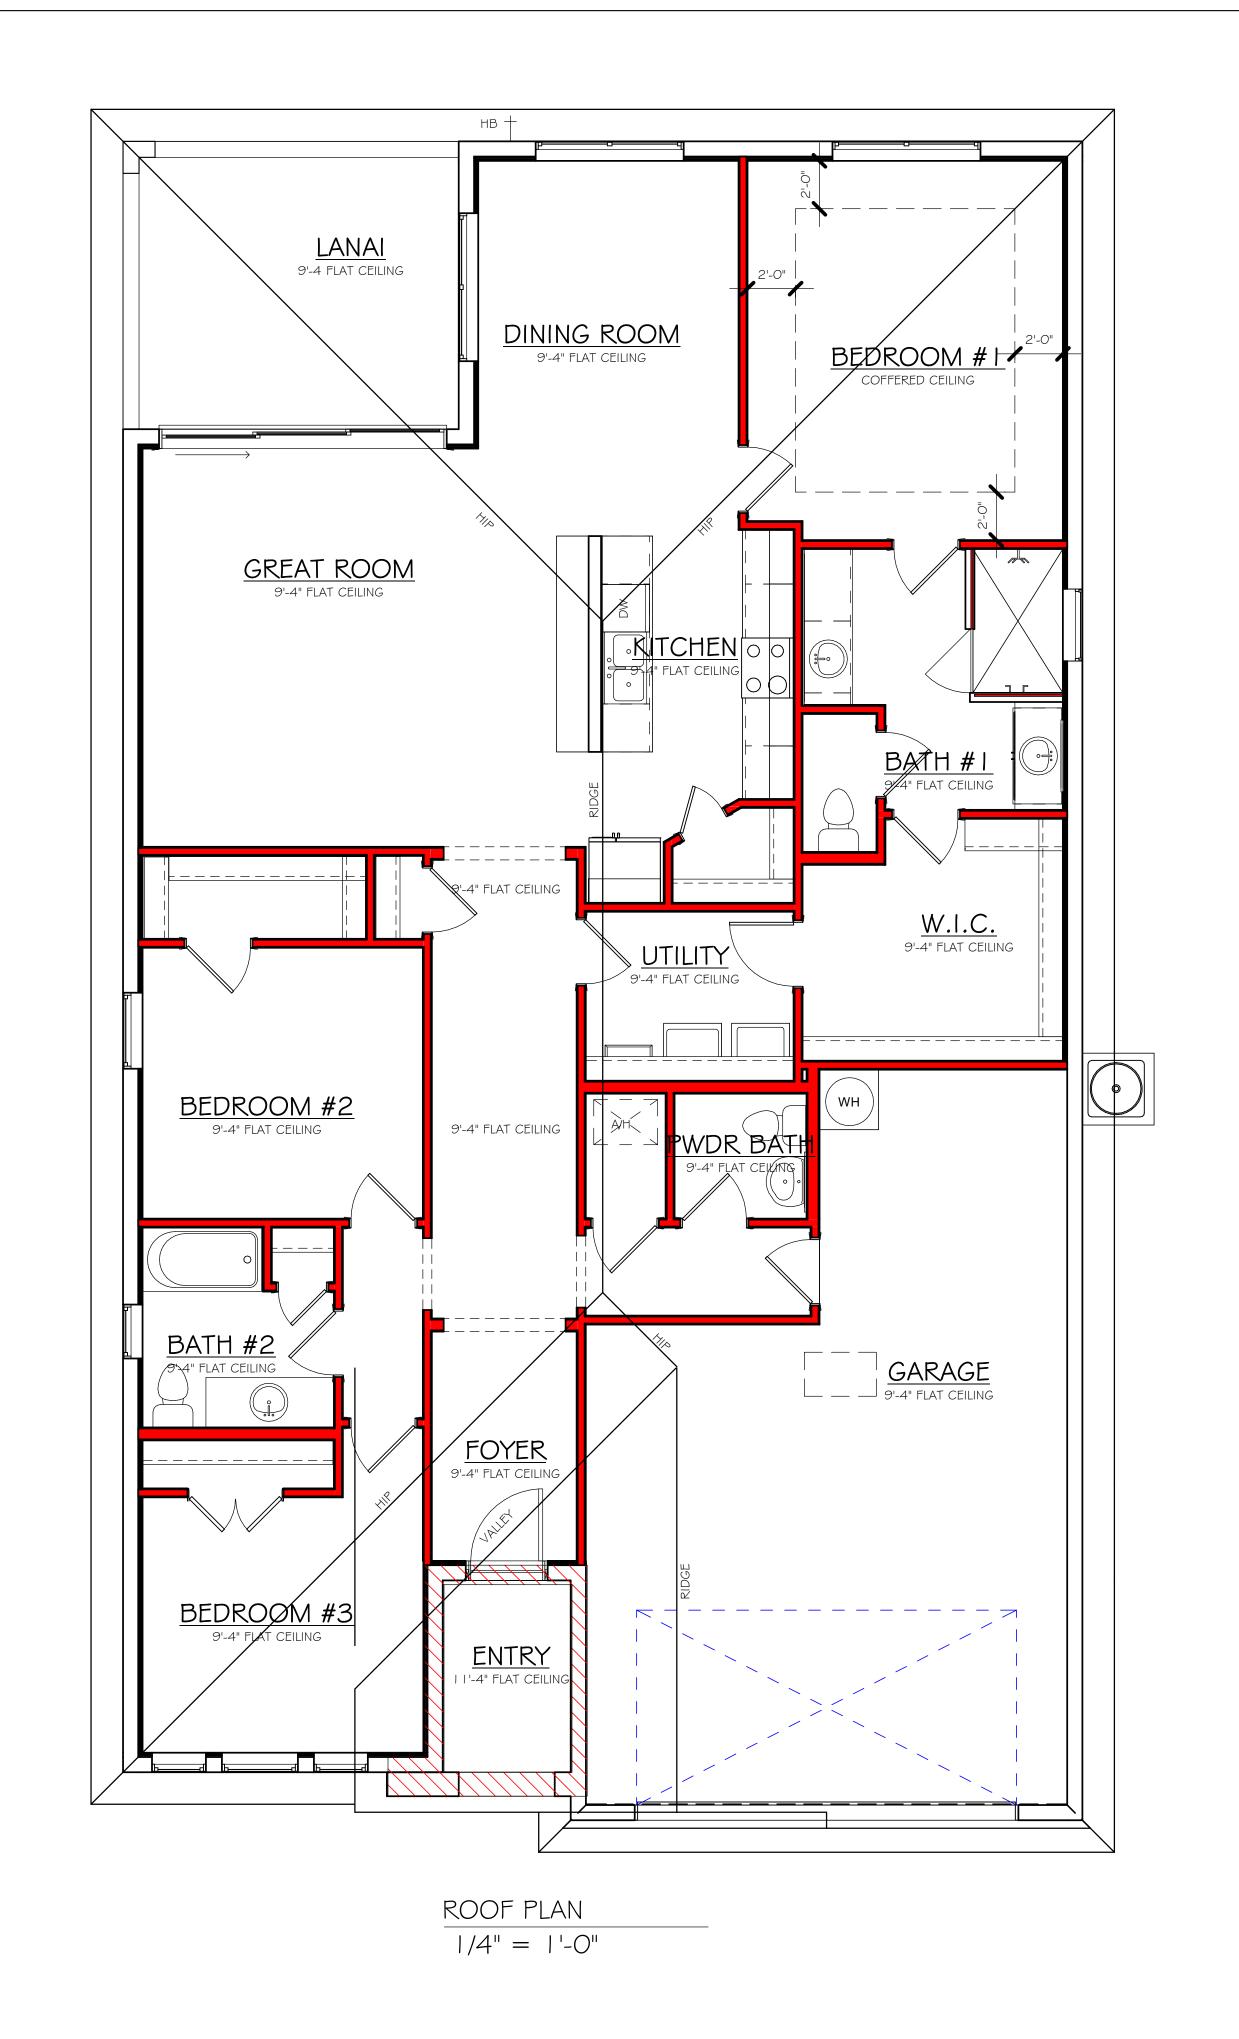

MODEL 962 DATE: 07/16/21 DRAWN BY: CHECKED BY: JWC REVISED: PLAN: ROOF SCALE: As indicated A-4 DESIGN IN ACCORDANCE WITH THE RESIDENTIAL

FLORIDA BUILDING CODE 2020 - 7TH EDITION


R.r.

ELECTRICAL METER ELECTRICAL PANEL I 20 V JUNCTION BOX SINGLE RECEPTACLE OUTLET 220 V RECEPTACLE OUTLET 4-PLEX RECEPTACLE OUTLET DUPLEX RECEPTACLE OUTLET 1/2 SWITCHED DUPLEX OUTLET DUPLEX RECEPTACLE AT ELEV. A.F.F. DUPLEX RECEPTACLE - ABOVE COUNTER SINGLE POLE SWITCH √ 3 WAY SWITCH O DIMMER SWITCH MOTION SENSOR SWITCH AC/DC SMOKE DETECTOR TO BE INTERCUNNLUILD
ANY RESIDENT HAVING A FOSSIL-BURNING
A FIREPLACE OR HEATER OR APPLIANCE, A FIREPLACE, OR AN ATTACHED GARAGE SHALL HAVE AN OPERATIONAL CARBON MONOXIDE ALARM INSTALLED WITHIN 10 FEET OF EACH ROOM USED FOR SLEEPING PERPOSES. PER RULE 9B-3.04.72 SD (SMOKE DETECTOR) SCD (CARBON MONOXIDE/ SMOKE DETECTOR) TELEPHONE OUTLET TELEVISION RECEPTION OUTLET SURFACE MOUNTED CEILING LIGHT FLUSH MOUNTED LIGHT | WALL MTD. BRACKET LIGHT DUPLEX FLOOD LIGHT EXHAUST FAN | <u>□ □ □ </u> | TRACK MTD. LIGHTS ☐ A/C DISCONNECT H☐ PUSH BUTTON (PB) / DOOR BELL (DB) (IC) INTERCOM KEYPAD 4' FLUORESCENT LIGHT 2' UNDER COUNTER LIGHT NOTE: NOT ALL SYMBOLS ARE USED FOR THIS PROJECT. ELECTRICAL NOTES: ARC-FAULT CIRCUIT-INTERRUPTERS AND TAMPER RESISTANT RECEPTACLES SHALL BE INSTALLED IN DWELLING UNITS PER N.E.C 210.12 AND 406.11 ALL ELECTRIC, ELECTRICAL EQUIPMENT AND APPLIANCES TO BE SET AT OR ABOVE BASE FLOOD ELEVATION PLUS I'-O" FREEBOARD. ALL OUTLETS IN WET AREAS AND ALL EXTERIOR OUTLETS TO BE GFI'S.

INSTALL PHONE AND T.V PER CONTRACT.

INSTALL ALL ELECTRICAL PER NEC 2014

ELECTRICAL LEGEND

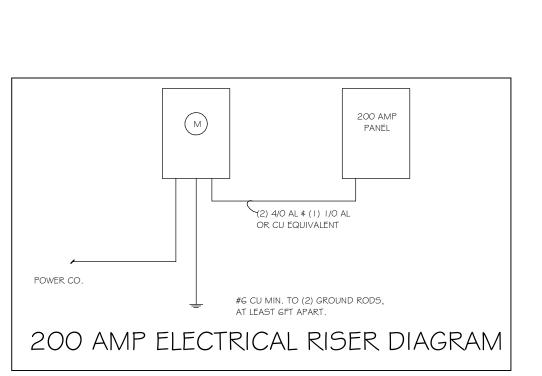

ELECTRICAL PLAN 1962 E

(FLUSH MOUNTED LT)
(VAPORS)
(PENDANT LIGHT

(10" MUSHROOMS) (24" 3 LT)

(36" 4 LT) (NOT USED)

(J BOX)

(COACH LIGHTS) (COACH LIGHTS)


(4' FLUORESCENT)
(2' FLUORESCENT)

(5LT CHANDELIER)

(PENDANT/ NOOK)

200 AMP SERVICE

TAG QUANTITY PRODUCT

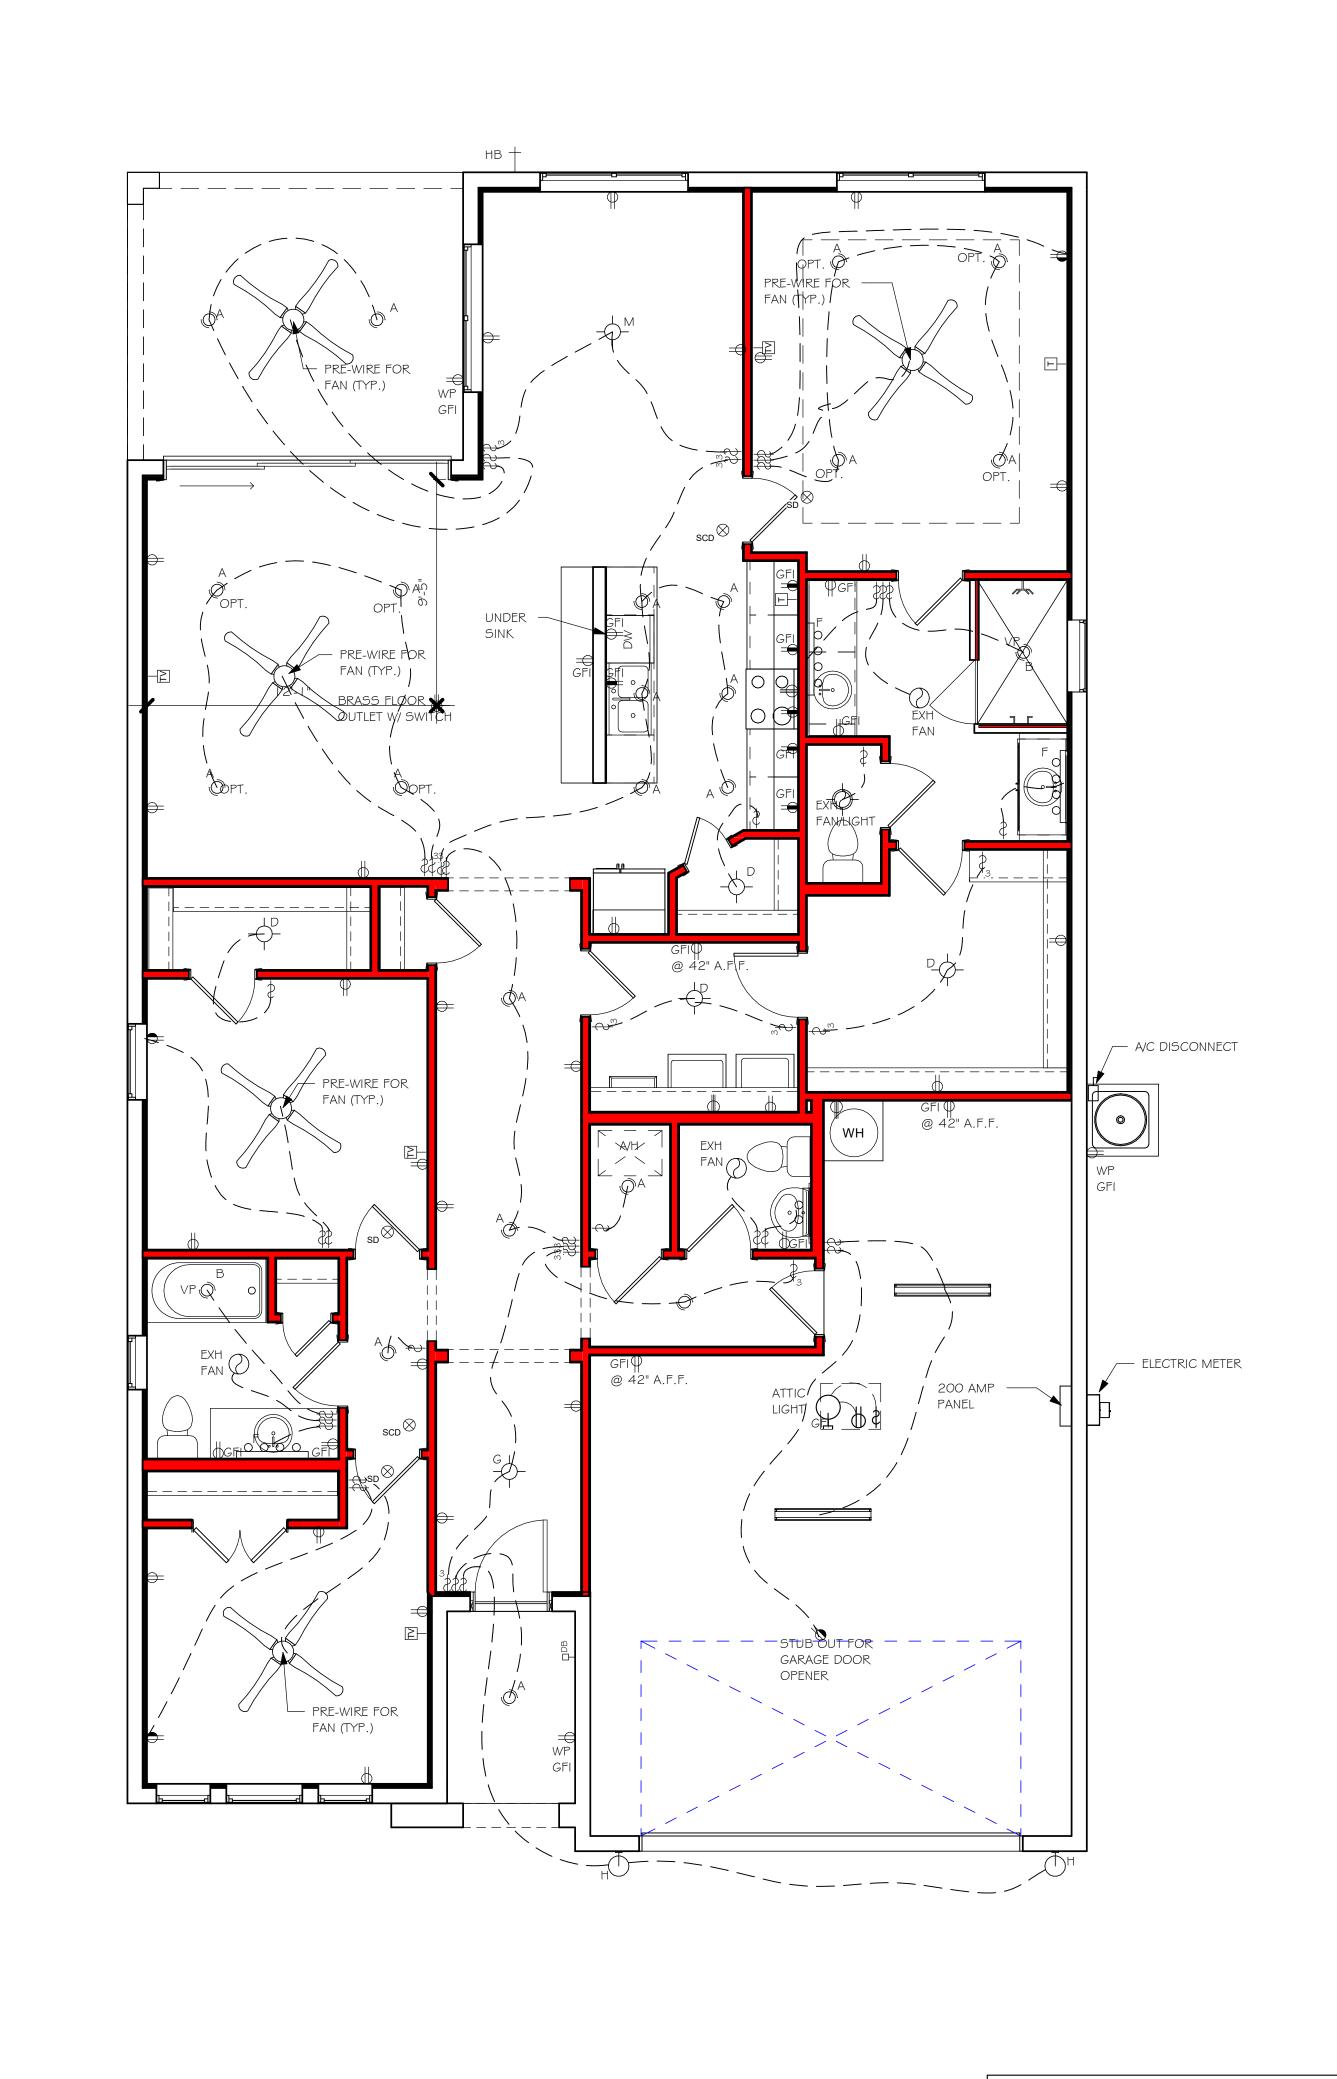

口

DATE:

DRAWN BY:

CHECKED BY:

REVISED:

PLAN:

SCALE:


DESIGN IN ACCORDANCE WITH THE RESIDENTIAL FLORIDA BUILDING CODE 2020 - 7TH EDITION


07/16/21

JWC

ELECTRICAL

As indicated

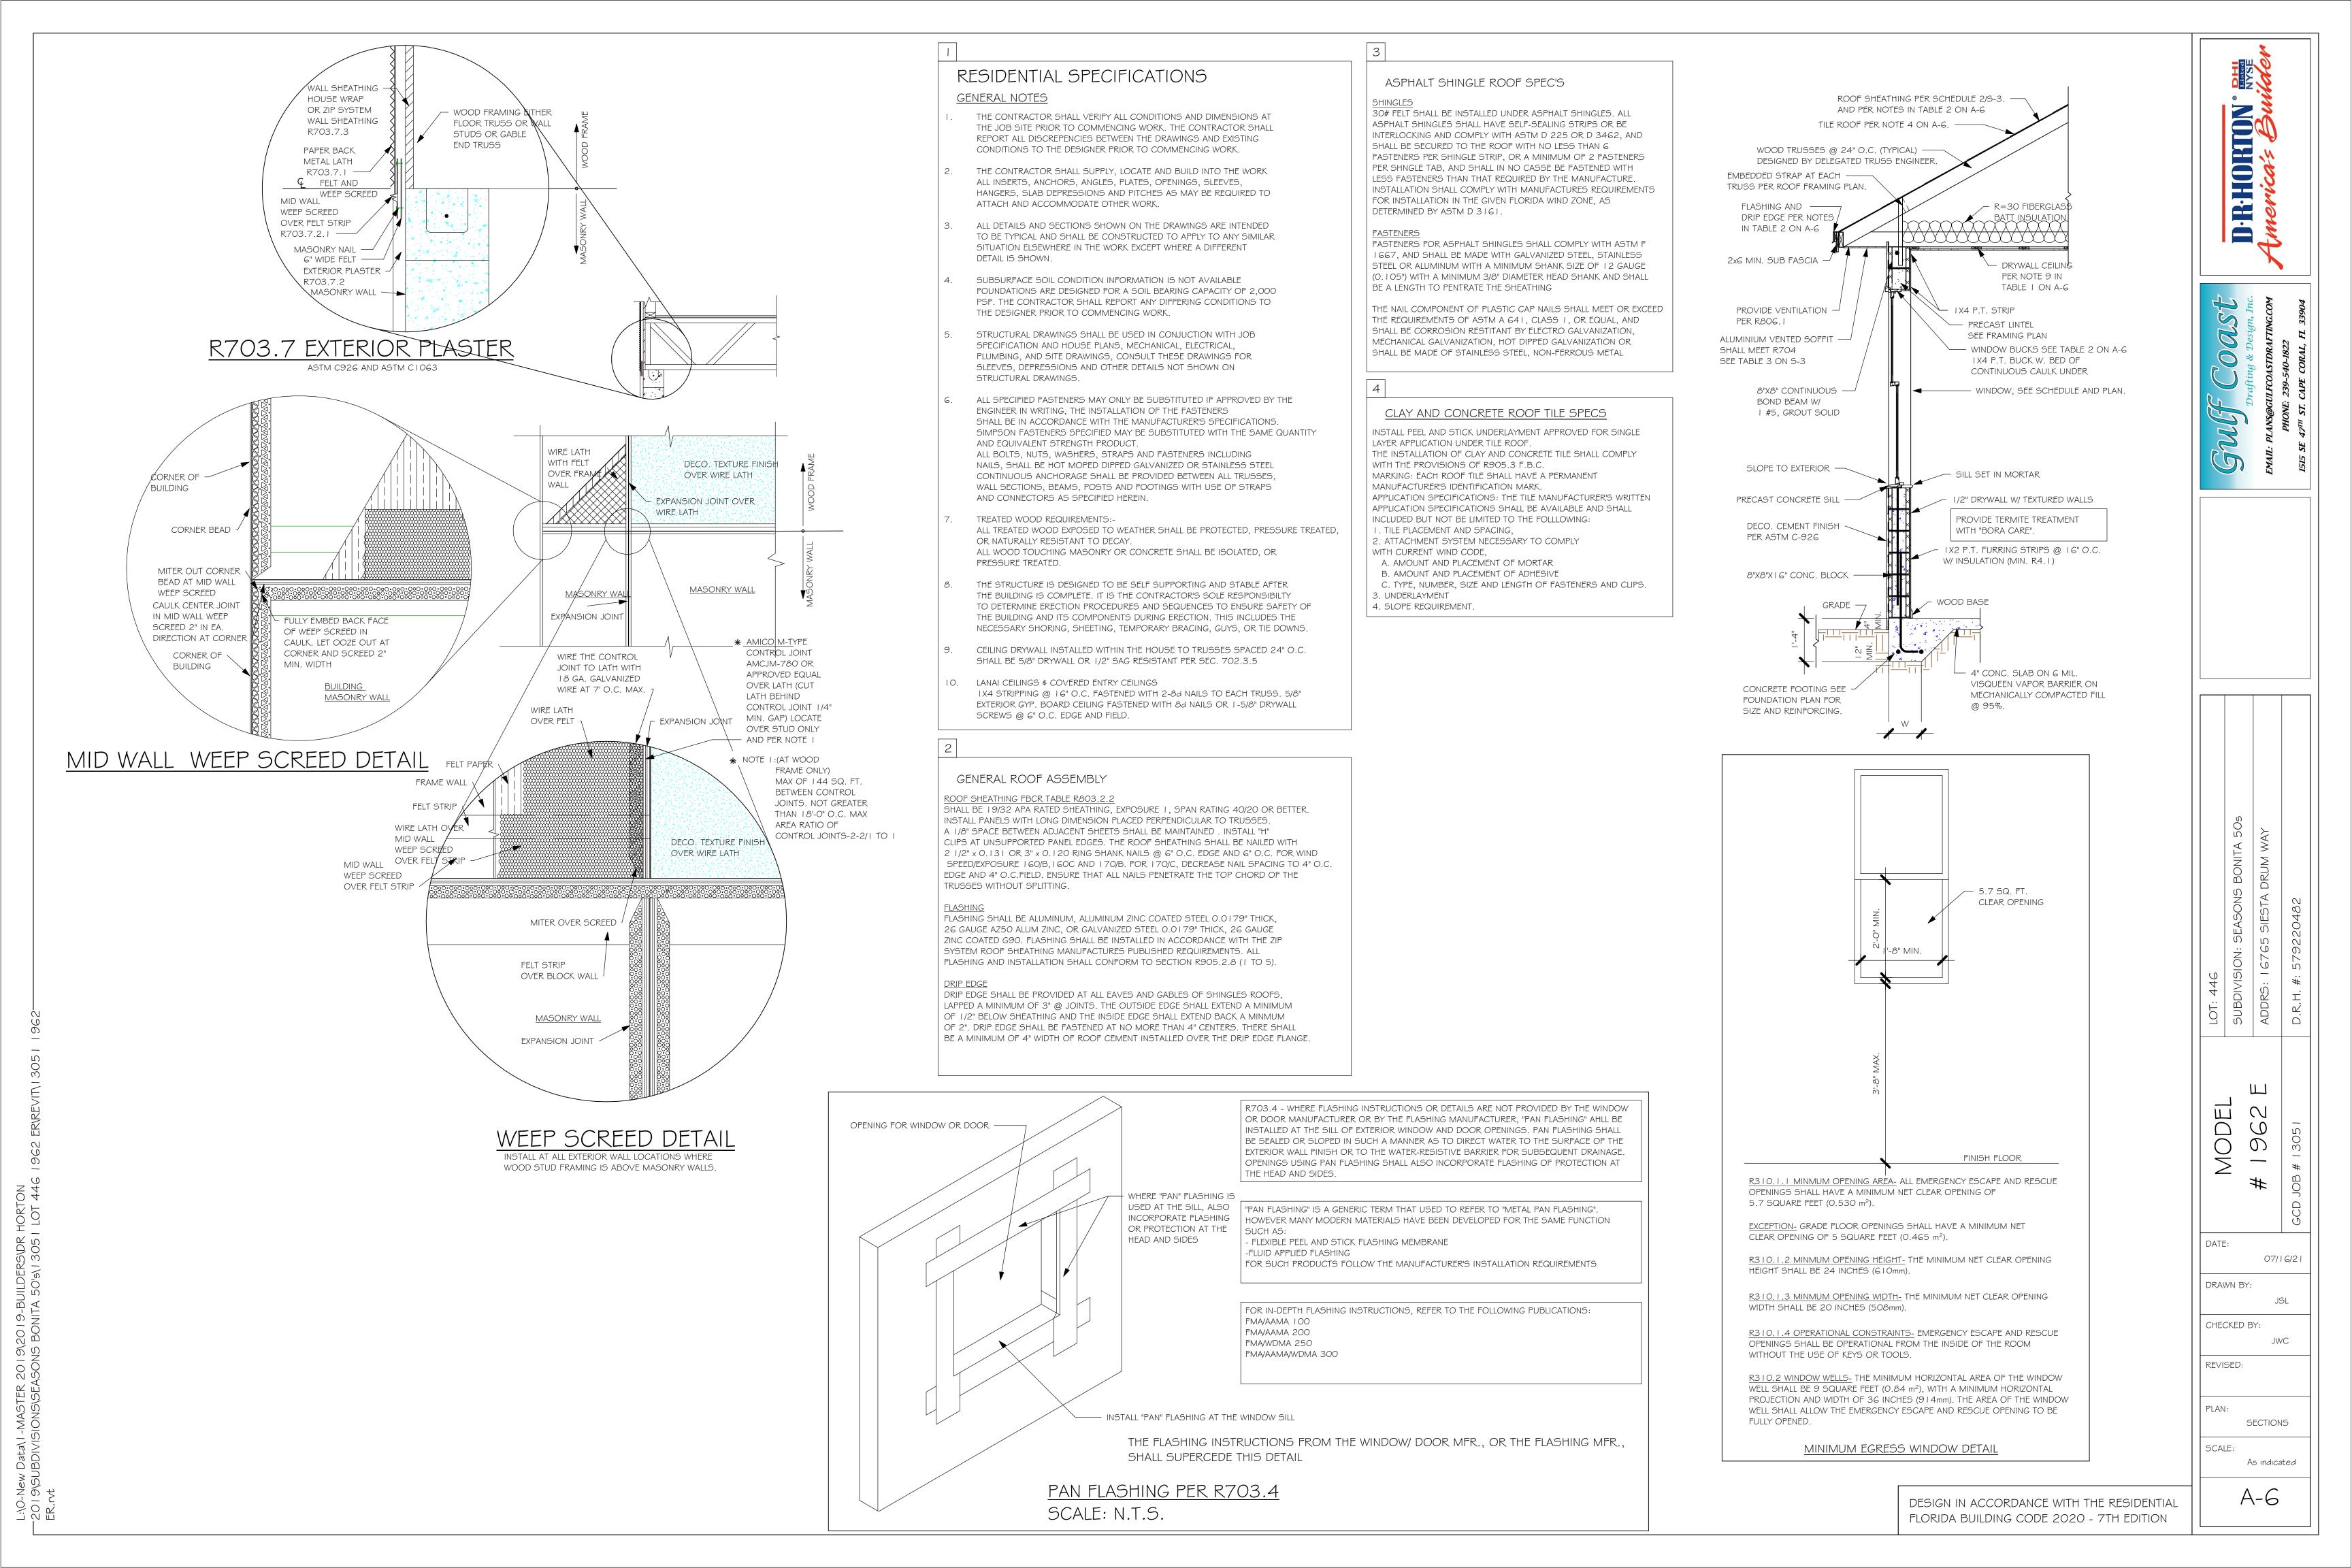

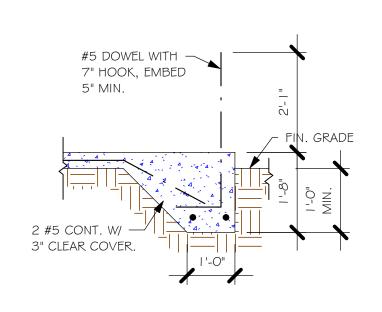


"F3" FOOTING


1/2" = 1'-0"

CURB IS OPTIONAL \$ NOT INCLUDED IN FOOTING DIMENSIONS #5 DOWEL WITH —. 7" HOOK, EMBED 5" MIN. BELOW GARAGE FLOOR VARIES WITH SLOPE OF FLOOR 2 #5 CONT. W/ — 3" CLEAR COVER.


> "F3" WITH CURB AT GARAGE 1/2" = 1'-0"

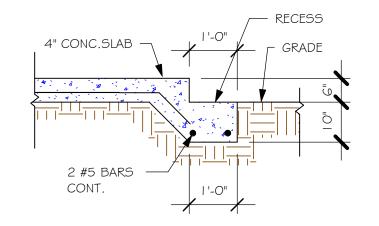

"GARAGE DOOR RECESS 1/2" = 1'-0"

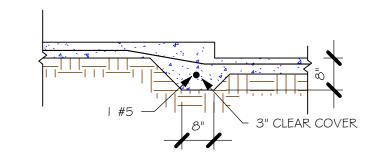

"F6A" STEP DOWN 1/2" = 1'-0"

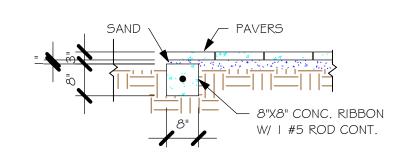

"P" PAVERS DETAIL ENTRY/ LANAI 1/2" = 1'-0"

WALL FOOTING SCHEDULE TYPE LENGTH WIDTH DEPTH BOTTOM REINFORCING SHAPE F1 CONT. 1'-4" 0'-8" F2 CONT. 1'-8" 0'-10" ADD CURB TO GARAGE, SEE DETAIL F3 CONT. 1'-0" 1'-8" F4 CONT. 1'-4" 1'-8" 2-#5 F5 CONT. 1'-4" 1'-0" | F6 | CONT. | 1'-4" | 1'-0" 2-#5 ±____ F6A CONT. 0'-8" 0'-8" **-**TE CONT. 0'-8" 0'-8" 1-#5

	PA	AD F	IITOC	٧G	SCHEDU	_E
_					BOTTOM REINF.	_

PROVIDE CORNER BARS PER 6/S-3


		. ,					
USED	TVDE	LENGTH	MIDTH	BOTTOM REINF.		DEMARKS	
nS	ITPE	LENGIA	חוטוייי	DEPTH	LONG WAY	SHORT WAY	REMARKS
X	$\langle \mathbf{A} \rangle$	2'-6"	2'-6"	1'-0"	3-#5	3-#5	-
	(B)	3'-0"	3'-0"	1'-0"	4-#5	4-#5	-
	(C)	3'-6"	3'-6"	1'-0"	4-#5	4-#5	-
	(D)	4'-0"	4'-0"	1'-2"	5-#5	5-#5	-
	(E)	5'-0"	5'-0"	1'-2"	6-#5	6-#5	-
X	(F)	2'-6"	3'-6"	1'-0"	3-#5	4-#5	-
	•		•				•

FOUNDATION PLAN

SCALE: 1/4" = 1'-0"

PLAN NOTES:

- 1. TOP OF GROUND FLOOR SLAB DATUM ELEVATION 0'-0" 2. "F#" DENOTES CONTINUOUS WALL FOOTING TYPE PER SCHEDULE THIS SHEET.
- PROVIDE #5 VERTICAL REINFORCING AT DOT LOCATIONS SHOWN ON PLAN FROM FOOTING TO BOND BEAM.
- ALL DIMENSIONS ARE TO OUTSIDE FACE OF MASONRY WALLS. SOME SLAB EDGES MAY EXTEND BEYOND FACE OF WALL.
- FOR DIMENSIONS OF ROUGH OPENINGS IN MASONRY WALLS, COORDINATE WITH WINDOW/
- PROVIDE PRESSURE TREATED BUCKS AT WINDOWS/ DOORS PER DETAIL 7/S-3.

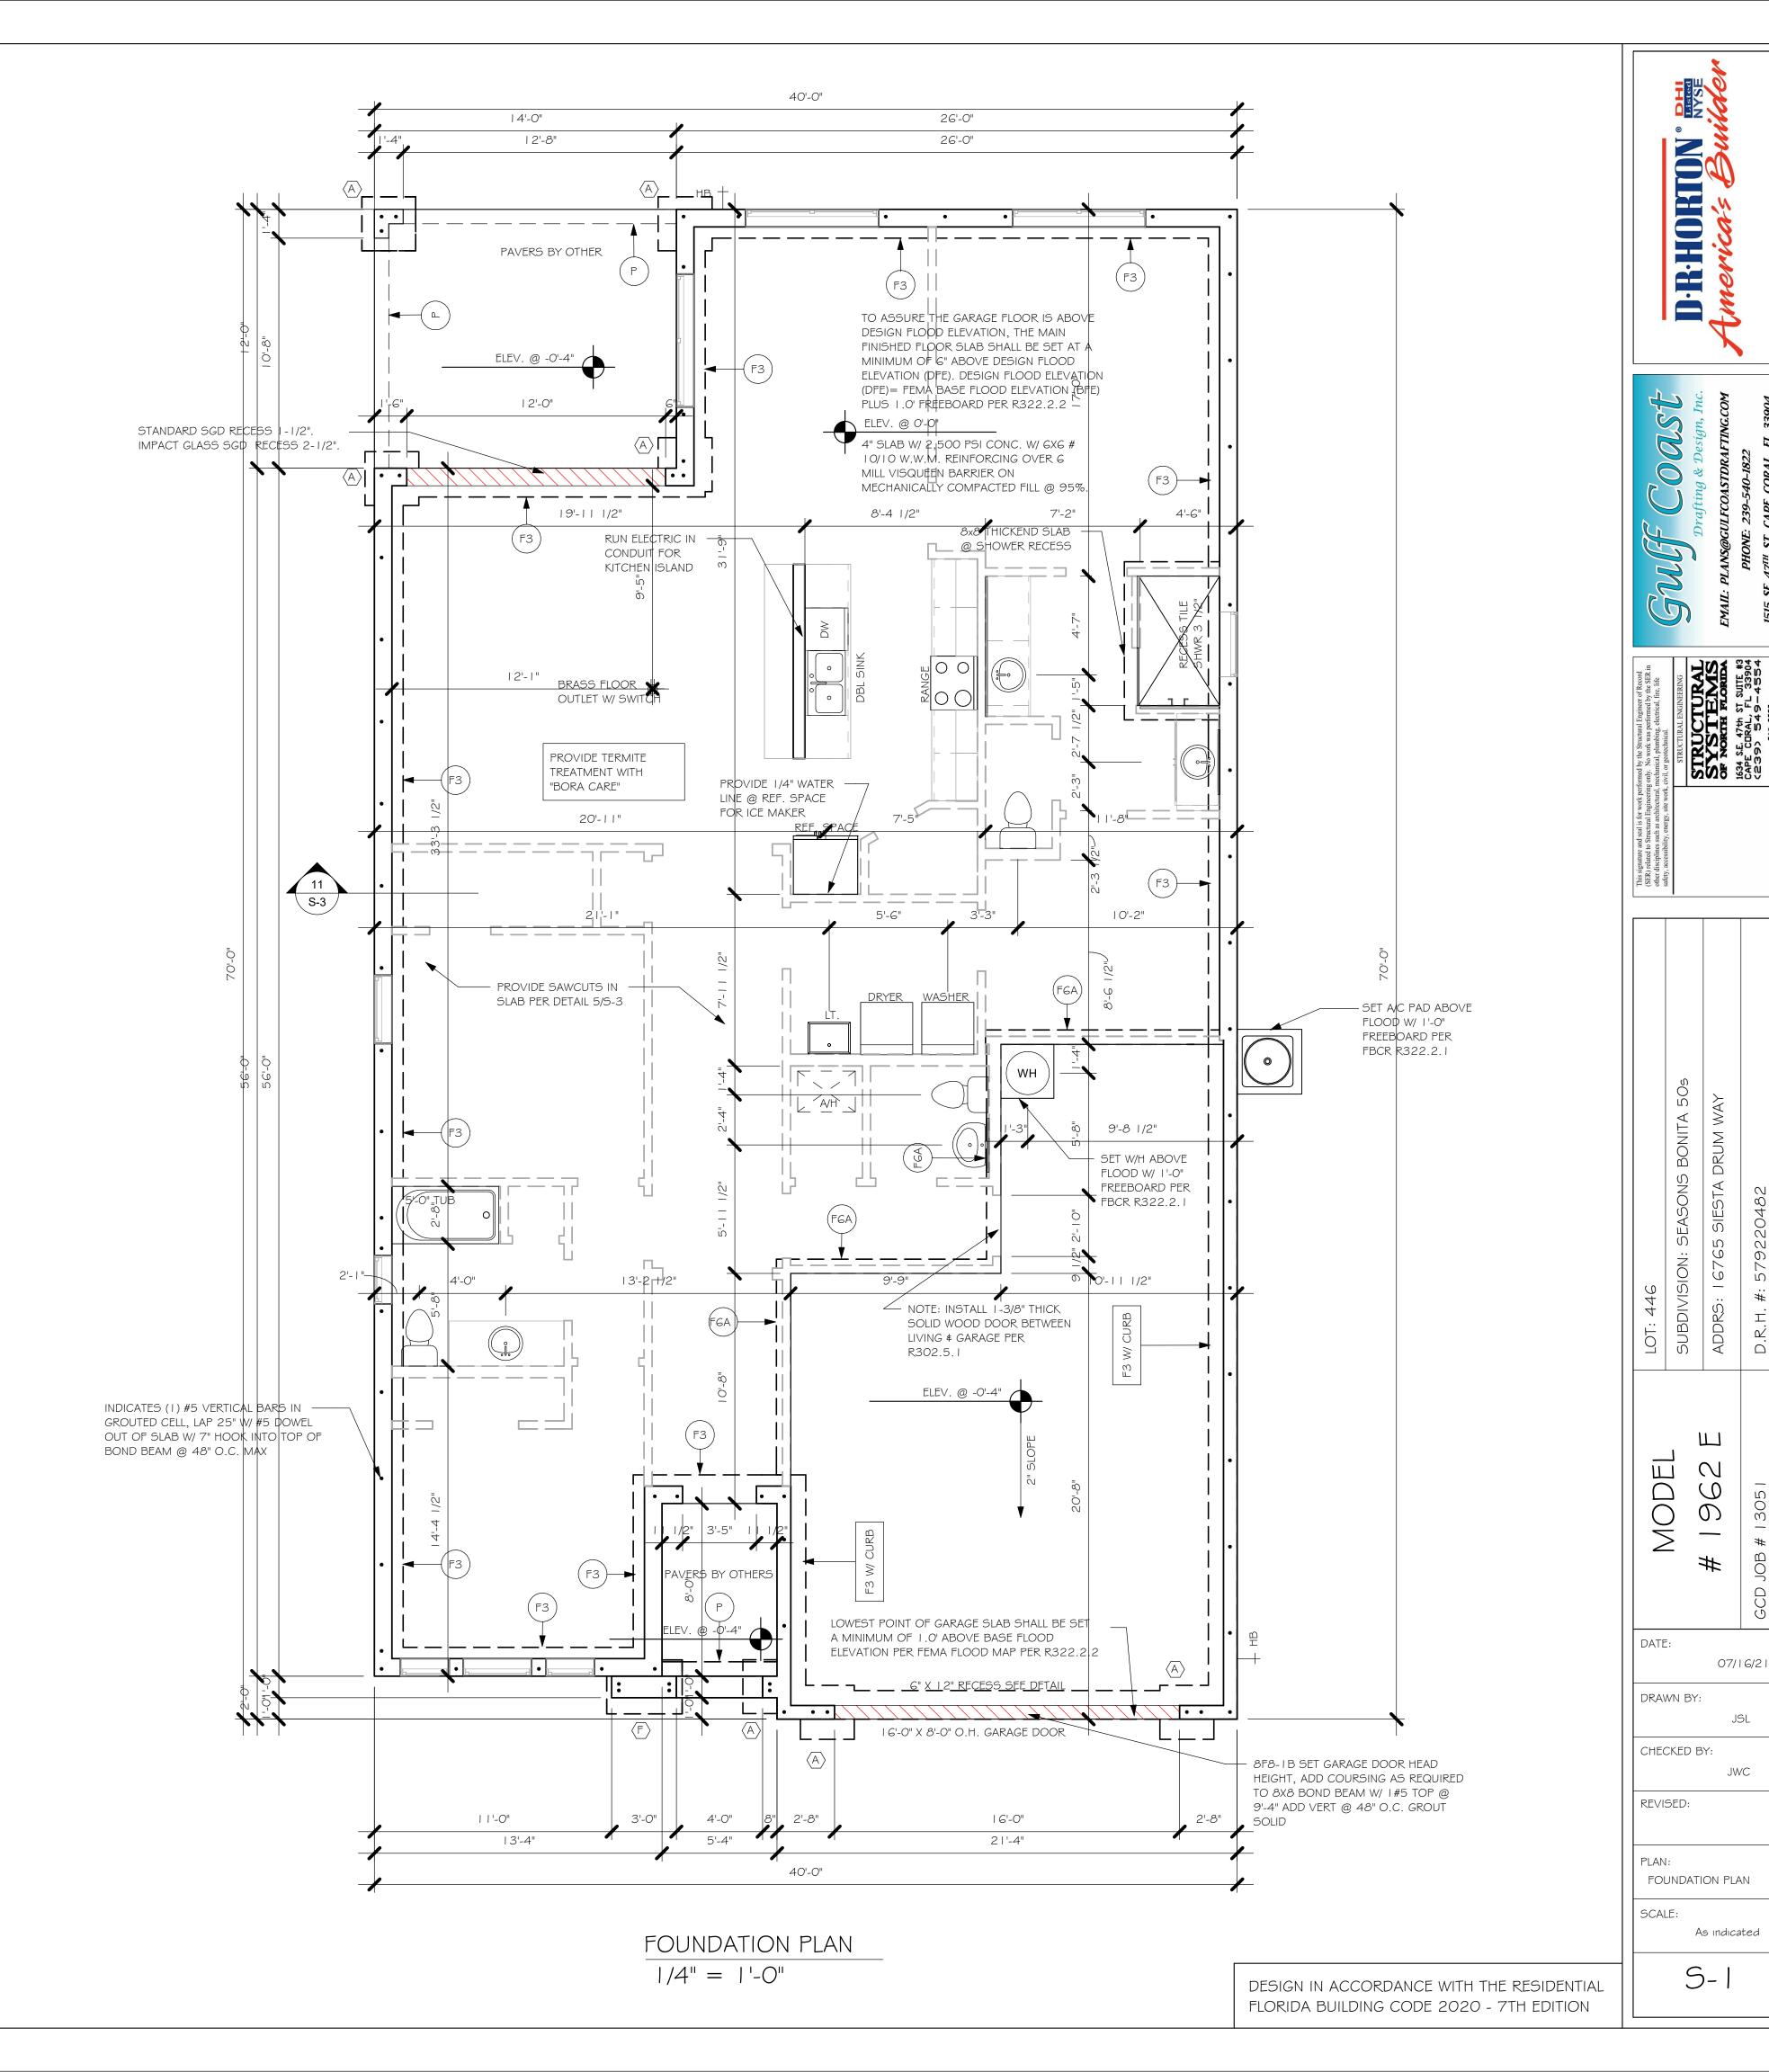

PROVIDE A STRAP FROM THE ABOVE LIST AT EACH ROOF TRUSS BEARING POINT, BASED ON THE TRUSS UPLIFT VALUES IN THE SIGNED AND SEALED TRUSS DESIGN PACKAGE AND SUITABLE FOR THE GEOMETRY. EMBED STRAP ON CENTERLINE OF WALL.

ANY OF THE VALID LENGTHS SHOWN MAY BE USED IN PLACE OF THE LENGTH SPECIFIED ON PLAN. CONNECTORS ARE SIMPSON STRONG TIE. ALL CONNECTORS SHALL BE INSTALLED IN STRICT ACCORDANCE WITH SIMPSON PRINTED INSTUCTIONS. SUBSTITUTIONS MUST BE APPROVED IN

WRITING BY THE ENGINEER OF RECORD. WHERE EMBEDDED STRAPS ARE MISSING, OR MIS-LOCATED, INSTALL RETROFIT STRAP PER 10/S-3. PER UPLIFT IN TRUSS ENGINEERING.


SIMPSON CATALOG C-C- 2019


INICTALL AT ALL	TRUSS STRAPPING TO STUDWALL/ WOOD BEAM					
INSTALL AT ALL TRUSSES TO 850 Ib UPLIFT.	MAX TRUSS UPLIFT (LBS)	STRAP(S) Valid lengths x/x/x	FASTENER			
FOR HIGHER - UPLIFTS, SEE NOTES ON	►850 1700 2550	(1)MTS 6/20/30 (2) MTS 6/20/30 (3) MTS 6/20/30	(14) 0.148x1-1/2" or 3" EACH STRAP			
PLAN.	1125 2250 3375 4500	(1) HTS20/24/30 (2) HTS20/24/30 (3) HTS20/24/30 (4) HTS20/24/30	(24) 0.148x1-1/2" OR (20) 0.148x3" EACH STRAP			

- PROVIDE A STRAP FROM THE ABOVE LIST AT EACH ROOF TRUSS BEARING POINT, BASED ON THE TRUSS UPLIFT VALUES IN THE SIGNED AND SEALED
- TRUSS DESIGN PACKAGE. ANY OF THE VALID LENGTHS SHOWN MAY BE USED IN PLACE OF THE LENGTH SPECIFIED ON PLAN.
- I-1/2" NAIL SHALL BE USED IN 1 PLY LUMBER, 2 PLY LUMBER IS REQUIRED
- CONNECTORS ARE SIMPSON STRONG TIE. ALL CONNECTORS SHALL BE

INSTALLED IN STRICT ACCORDANCE WITH SIMPSON PRINTED INSTUCTIONS.

SIMPSON CATALOG C-C- 2019

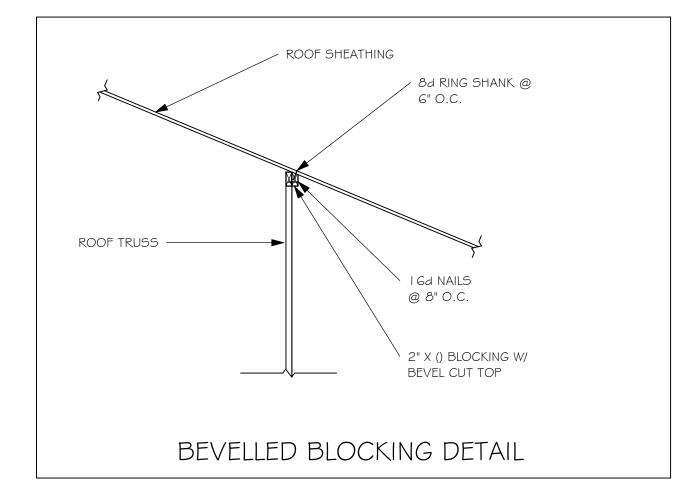

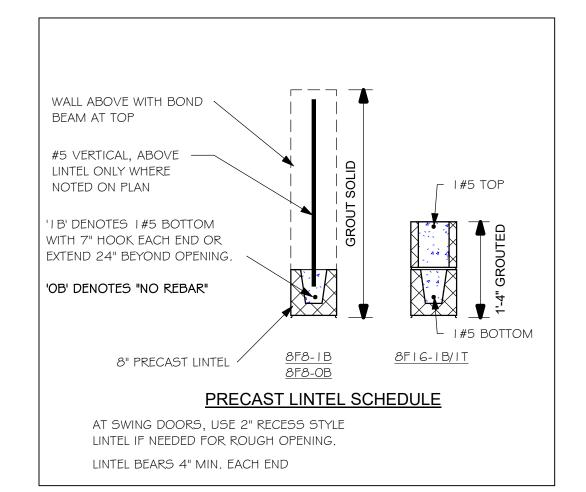


PLAN NOTES:

- ROOF TRUSS BEARING ELEVATION VARIES, SEE
- ROOF FRAMING SHALL BE WOOD TRUSSES DESIGNED BY A DELEGATED TRUSS ENGINEER PER DESIGN CRITERIA ON SHEET S-3.
- PROVIDE STRAPPING AT TRUSSES PER NOTES ON THIS
- FOR NAILING OF ROOF, SEE I AND 2 ON S-3.
- 8F8-1B etc., DENOTES PRECAST LINTEL ABOVE
- DOOR/WINDOW OPENING PER SCHEDULE THIS SHEET. AT TRUSS BEARING, PROVIDE 8x8 MASONRY BOND BEAM W/ I #5 CONTINUOUS, SEE DETAIL I I/S-3.

BEARING HEIGHT = BEARING @ 9'-4" = BEARING @ 11'-4"

TRUSS BEARING CONDITIONS AND STRAPPING IS BASED ON TRUSS LAYOUT PREPARED BY SCOSTA CORP, JOB# DR | 962E DATED: | 2/02/20 REVISED: 05/24/21

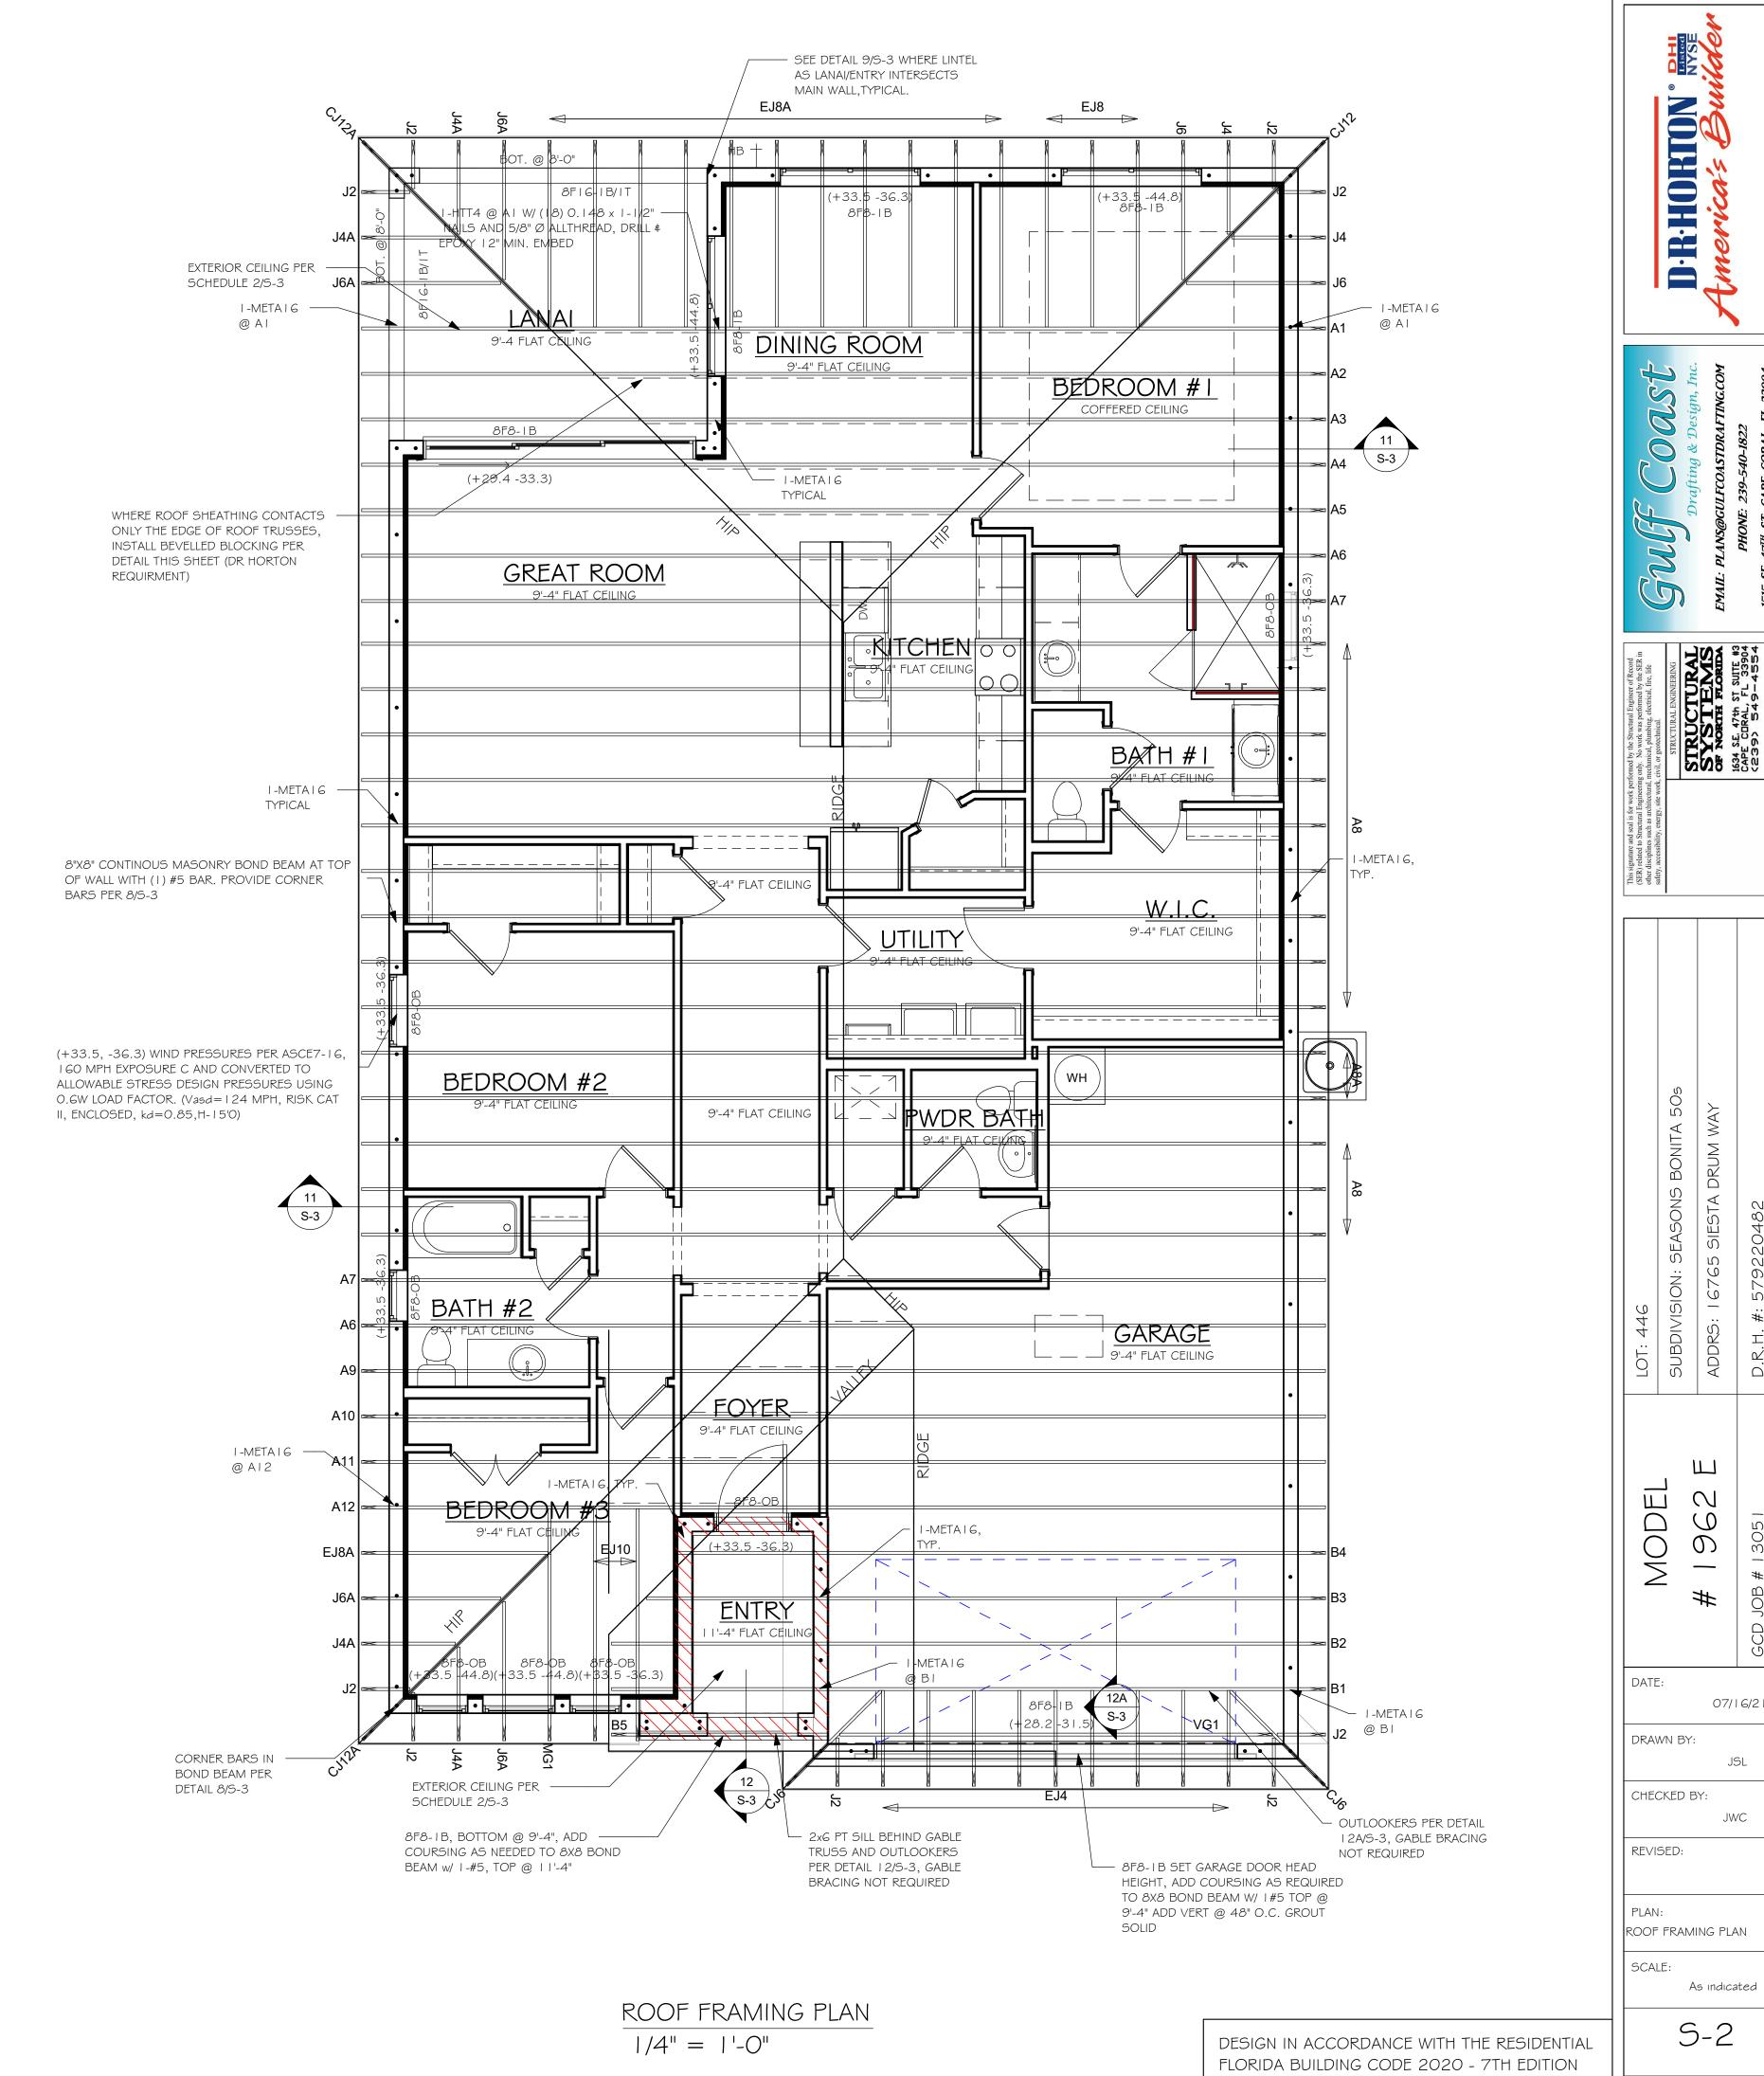

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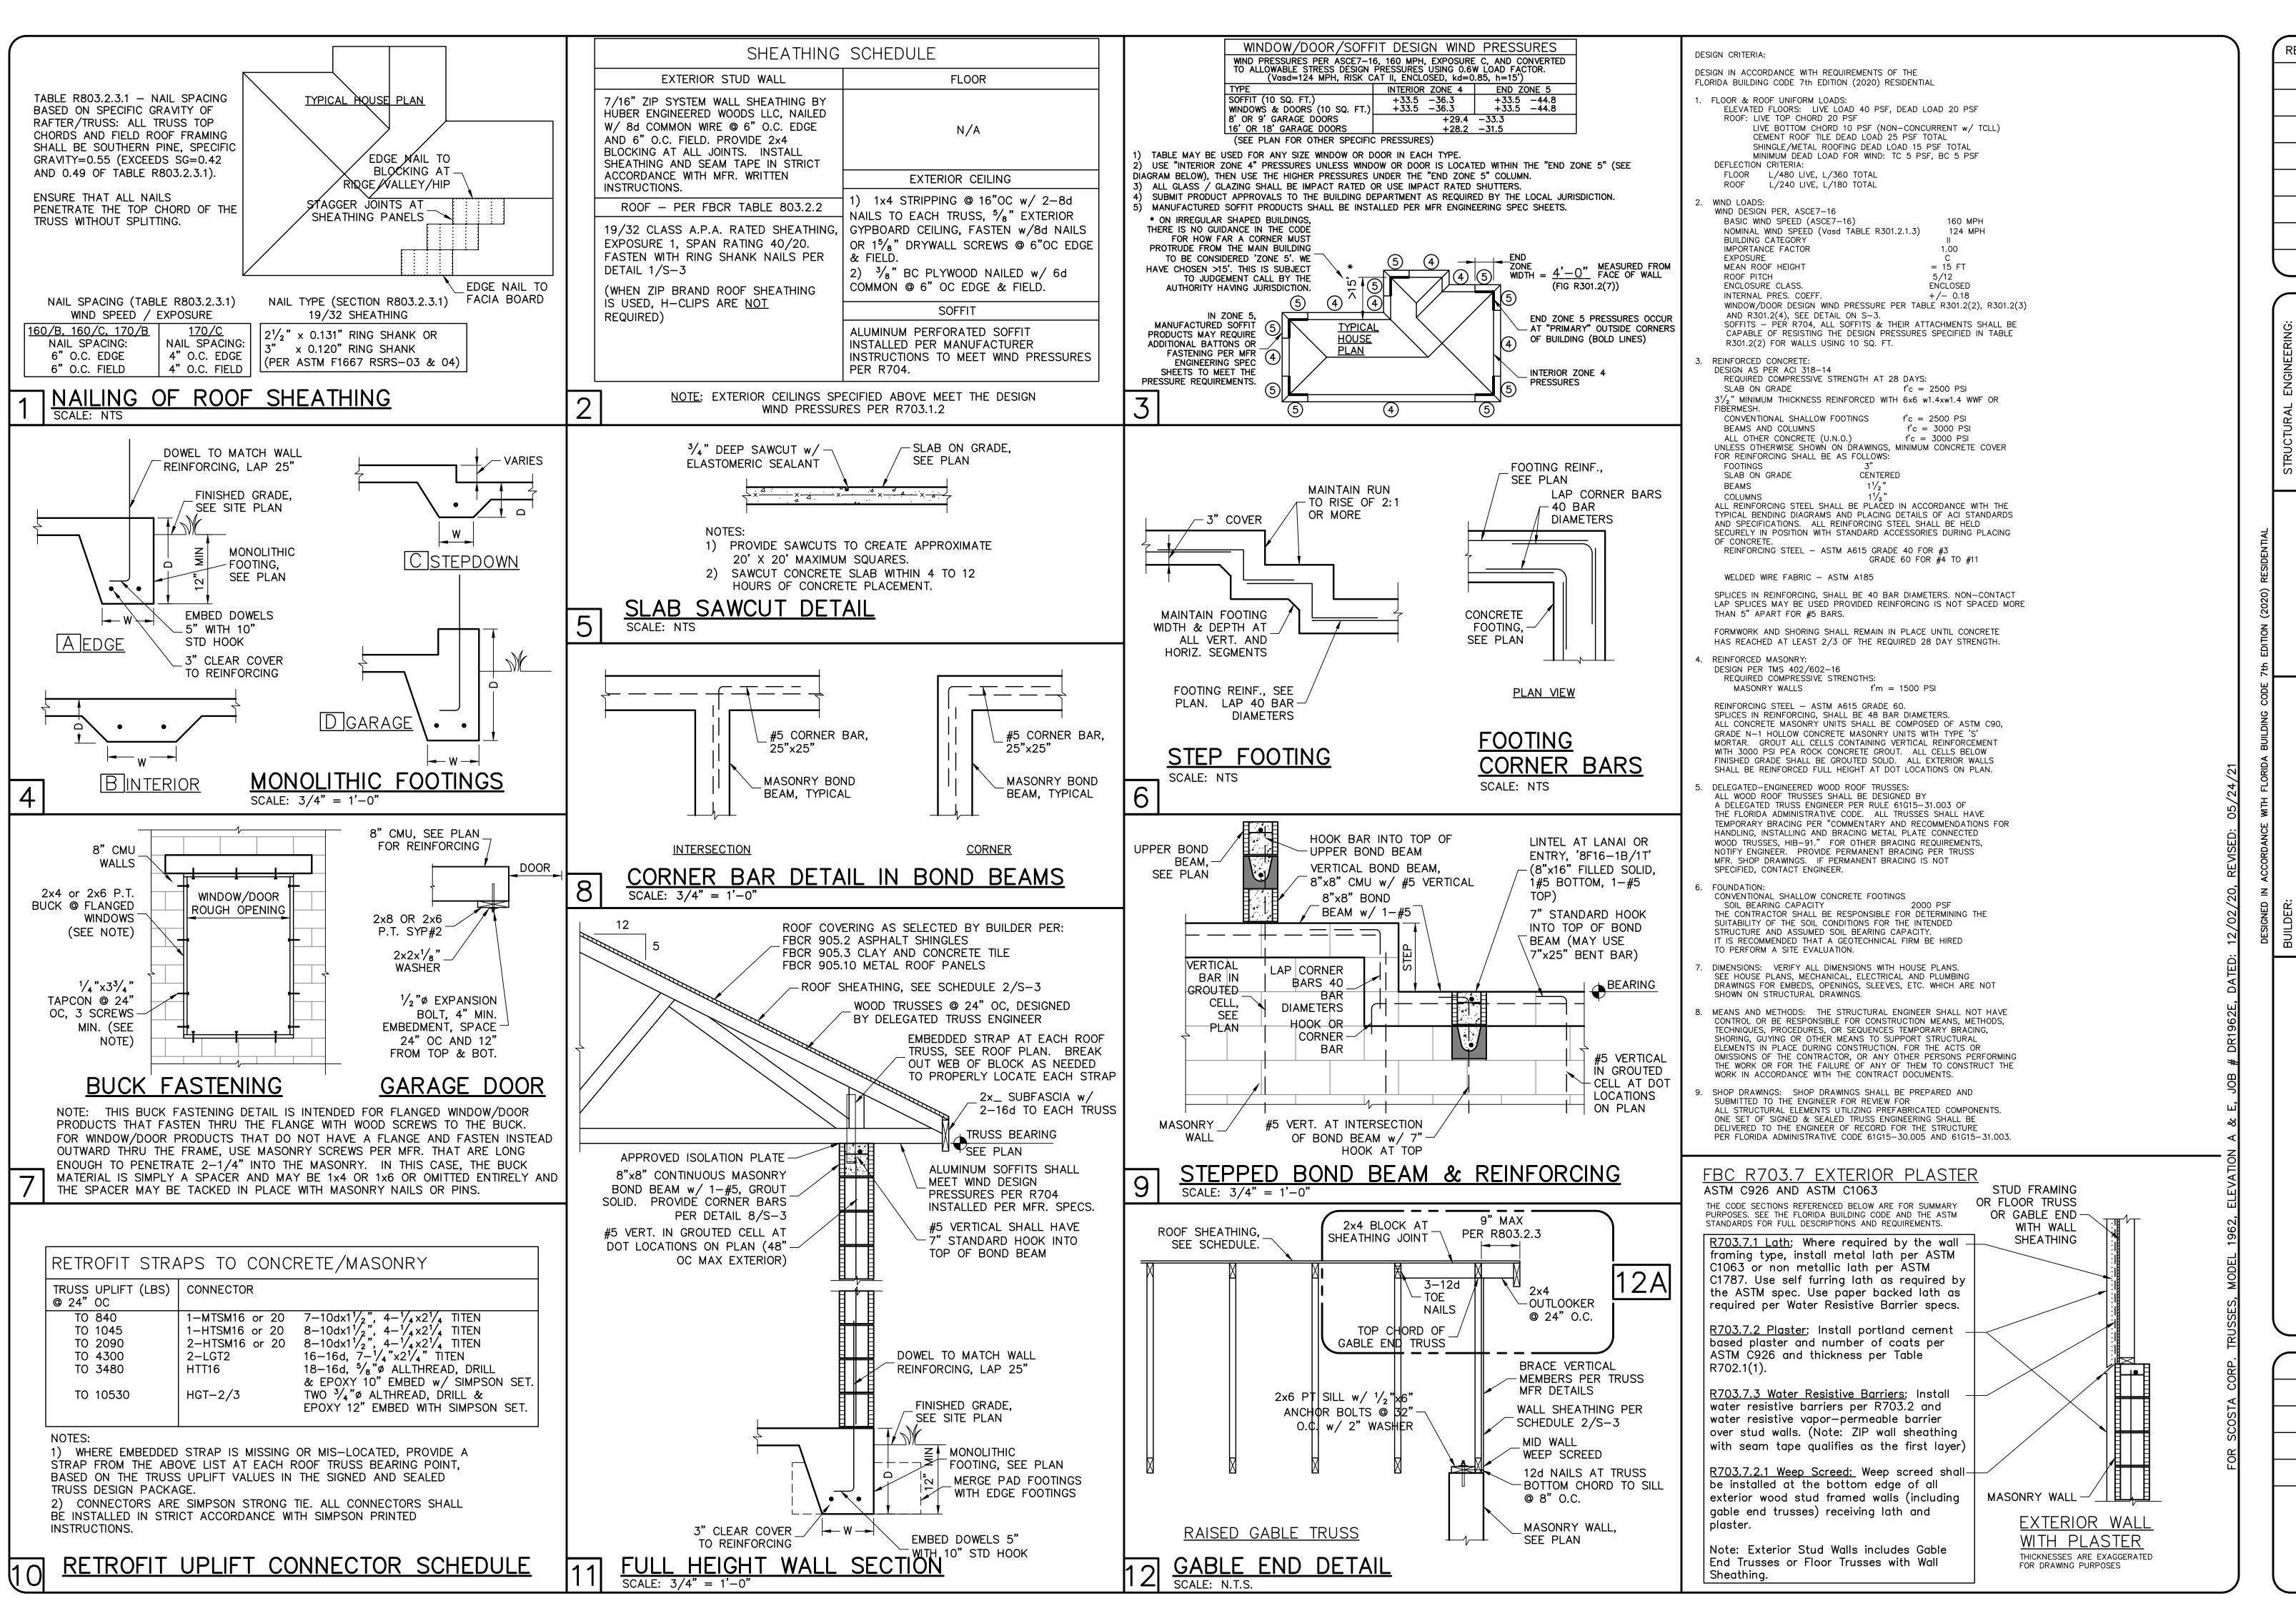
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07/16/21

JSL

JWC

As indicated



STRUCTURAL ENGINEERING:

1634 S.E. 47th STREET, SUITE #3

CAPPE CORPL. FL 33904

(239) 549-4554

BUILDER:

BUILDER:

America's Building Building

UCTURAL DETAILS
MODEL 1962 E

16765 SIESTA DRUM WAY
BONITA SPRINGS, FLORIDA
1446 SUBDIVISION: SEASONS BONITA

DESIGN/DRAWN
DWB/RR

CHECKED
DWB


DATE
07/16/21

SCALE
VARIES
JOB NO.
DR 13051

S-3

SHEET 3 OF 4

SHEET

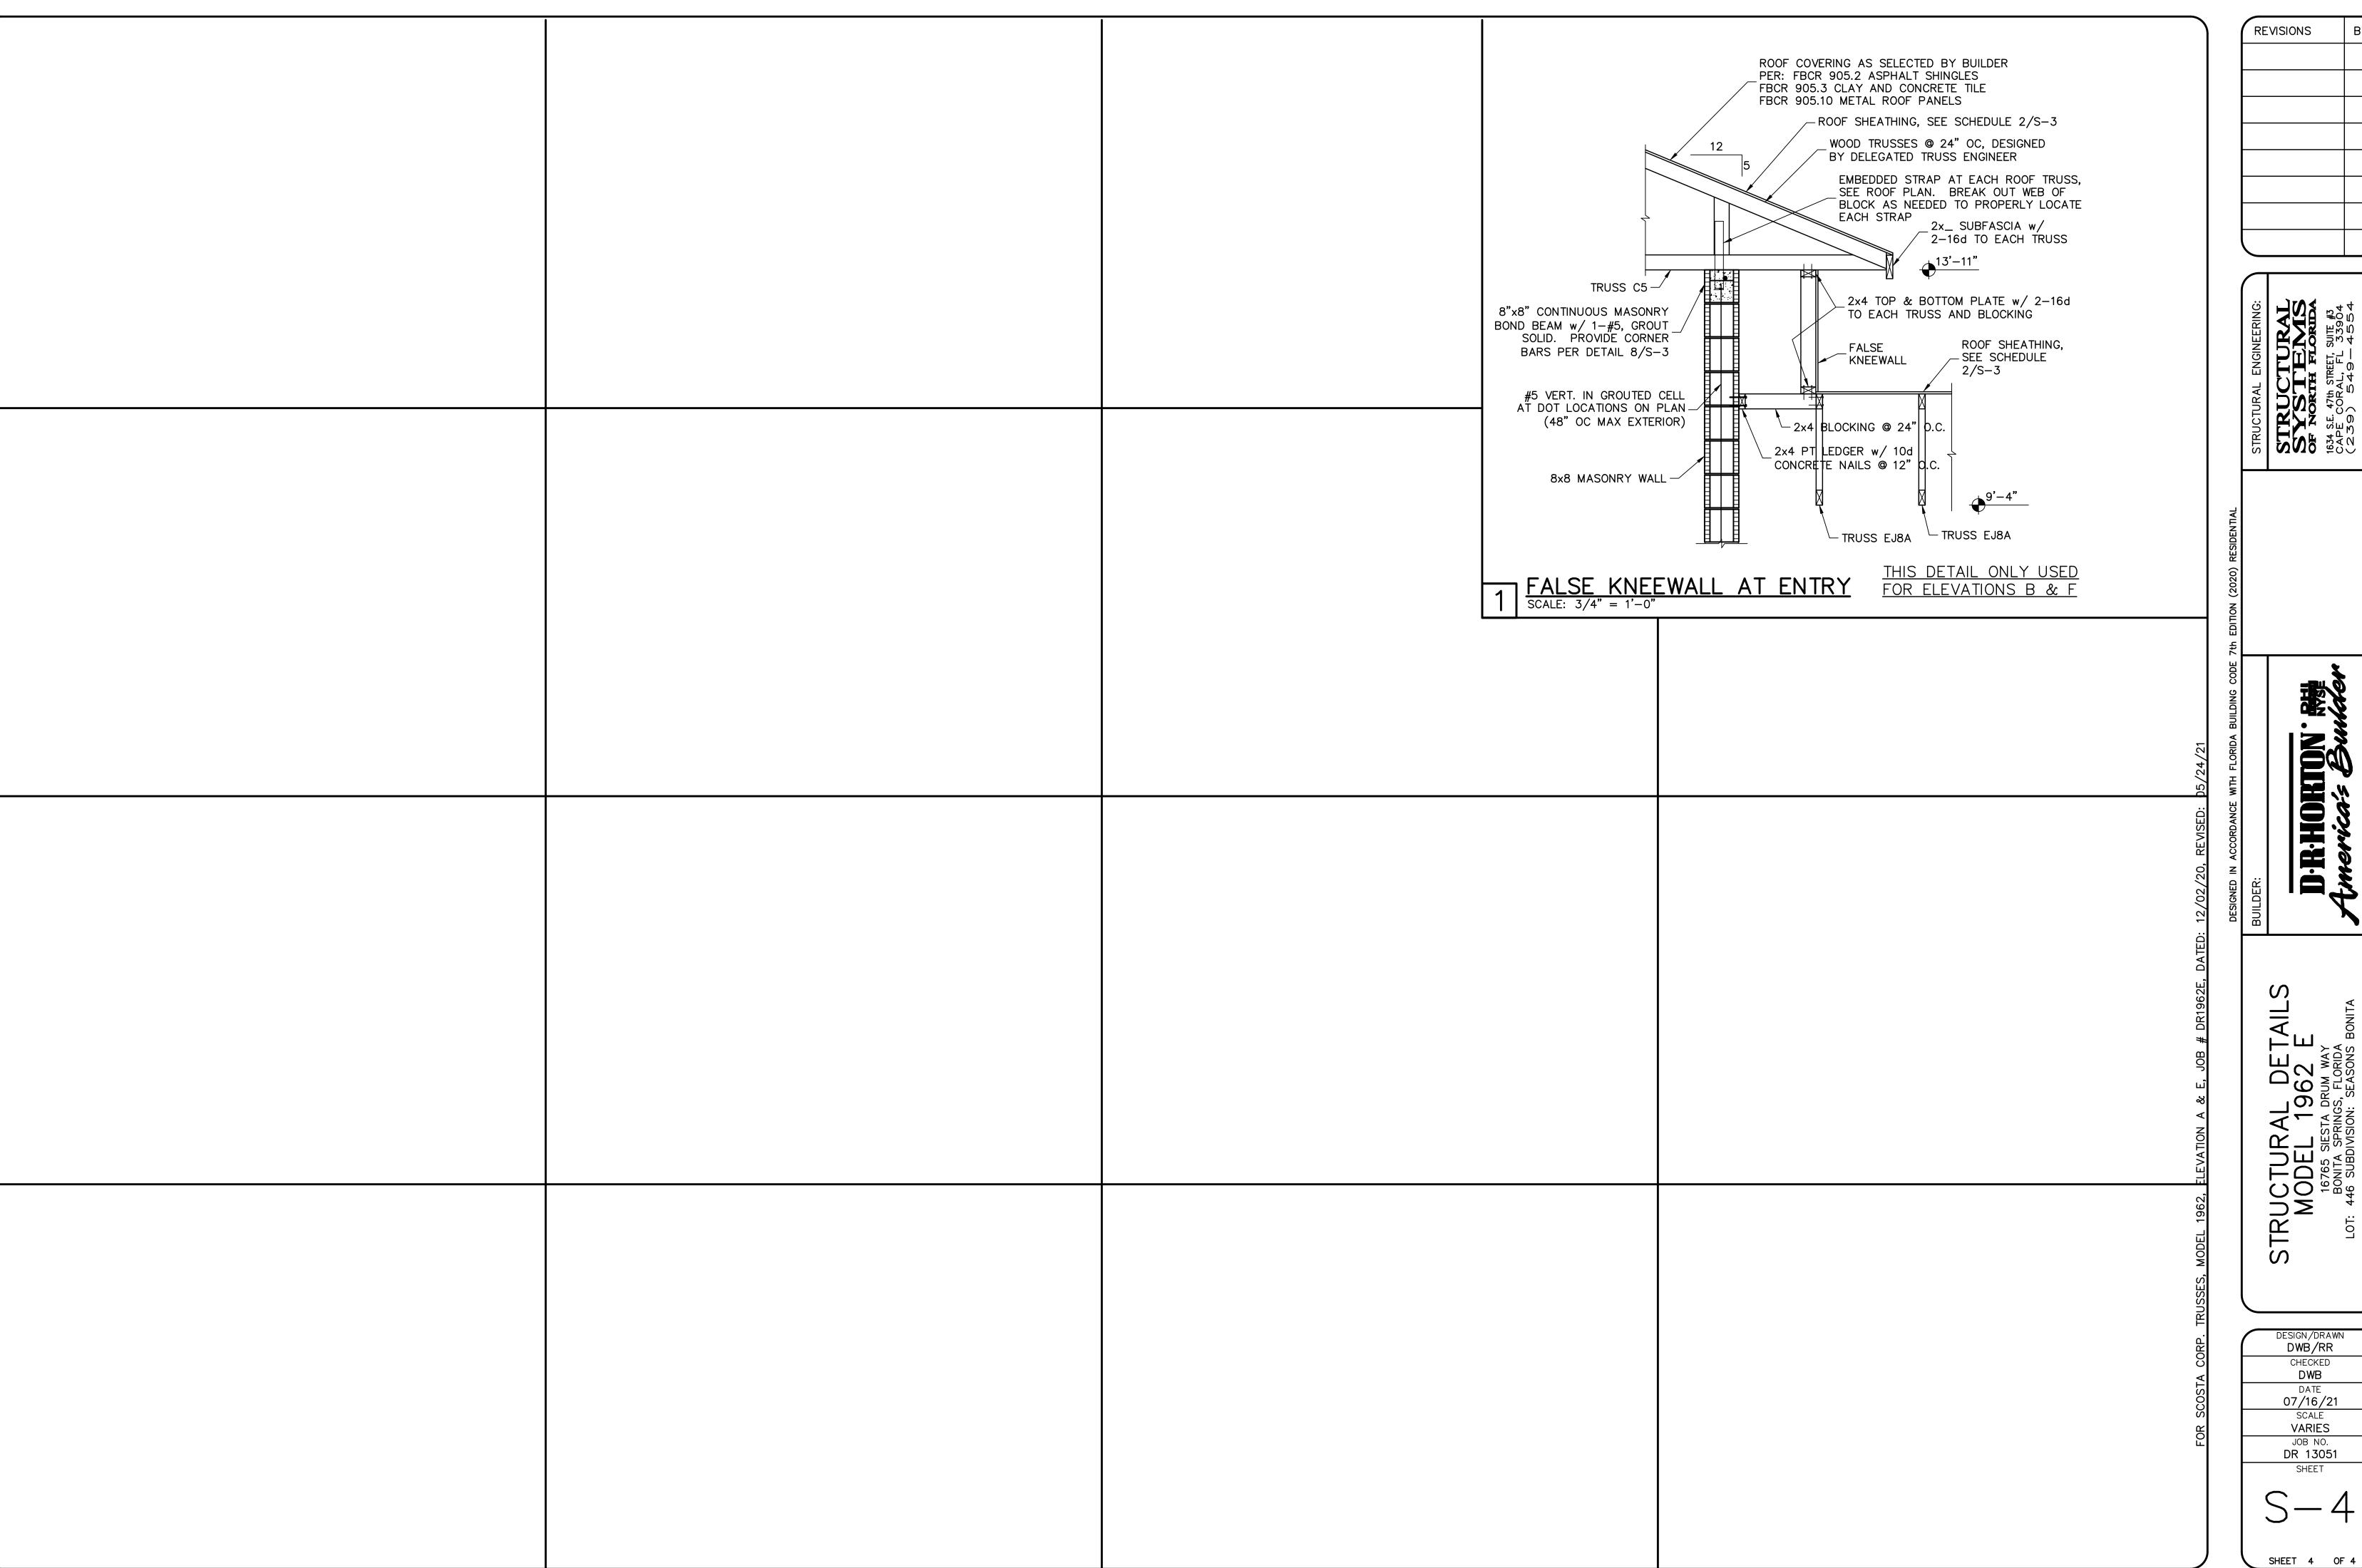

DESIGN/DRAWN
DWB/RR
CHECKED
DWB DATE
07/16/21
SCALE
VARIES
JOB NO.
DR 13051