

Engineer of Record for the Structure Structural Systems of N. Fl, Inc. Raul Reyes, PE 88925 1634 SE 47th Street #3 Cape Coral, FL 33904


This document has been reviewed for conformance with the design intent of the structure and specified design criteria.

Accepted Accepted Revise and As-Is As Noted Resubmit

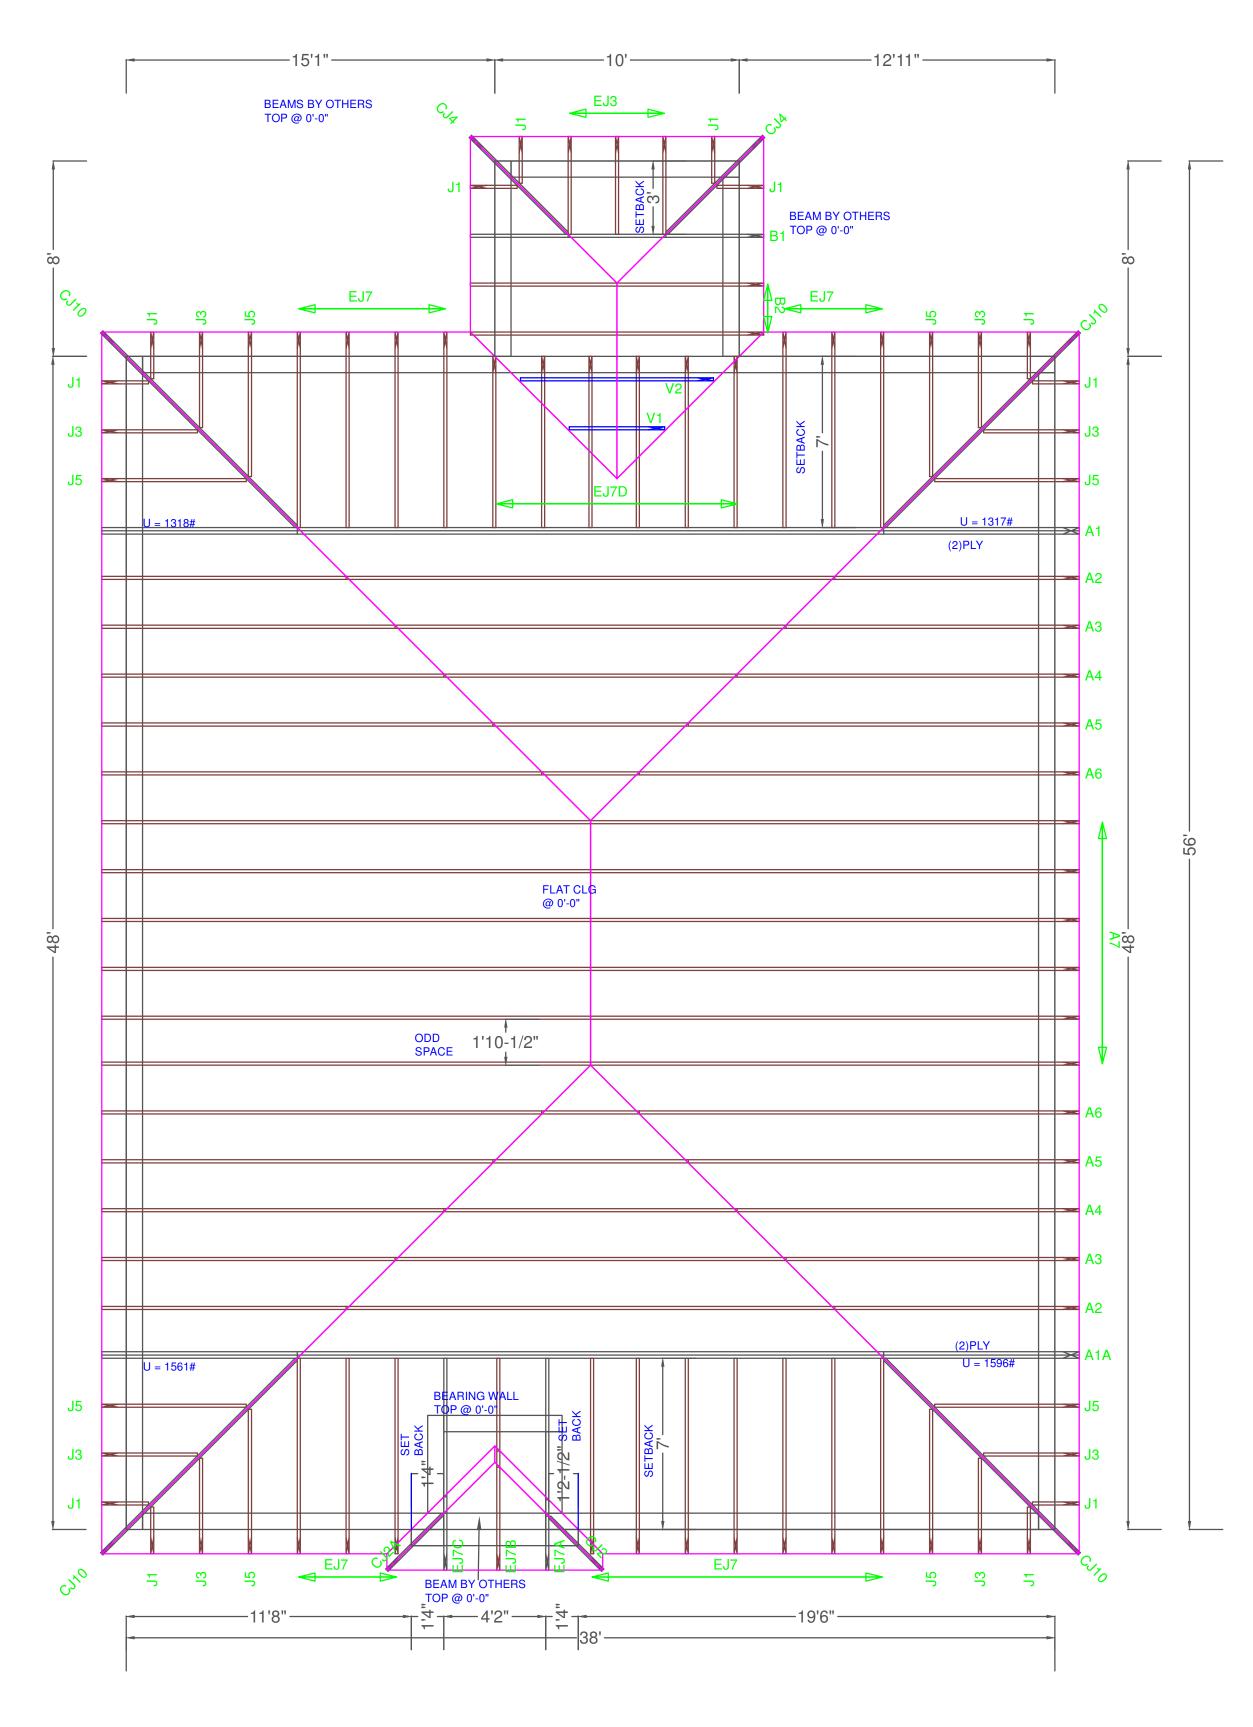

TYPICAL JACK CUTS CJ DDUBLE BEVEL SQUARE CUT SEE ENGINEERING FOR FASTENING REQUIREMENTS

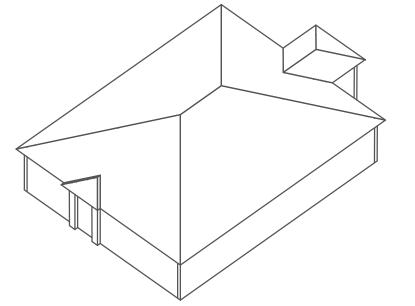

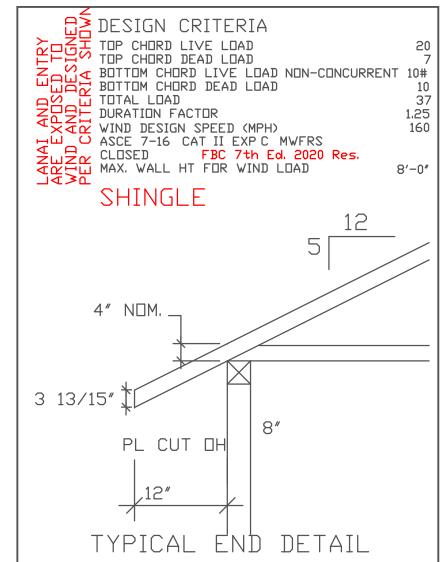

UNLESS NOTED

REACTION VALUES ARE UNDER 5000#
UPLIFT VALUES ARE UNDER 1000#

DO NOT ATTEMPT TO ERECT TRUSSES WITH-OUT REFERRING TO THE ENGINEERING DWGS.

IT IS NECESSARY TO REFER TO THE ENGINEERING DRAWINGS FOR NUMBER OF MEMBERS, BEARING LOCATION,

DRAWINGS FOR NUMBER OF MEMBERS, BEARING LOCATION ORIENTATION AND WEB BRACING

REFER TO WTCA/TPI BSCI-B1 SUMMARY

SHEET FOR HANDLING METHODS & TEMPORARY BRACING, WHICH IS ALWAYS REQUIRED

BEARING HEIGHTS BASED ON PLANS PROVIDED TO SCOSTA CORP. "+/-" BEARING DIFFERENCES SHOWN ARE CRITICAL. IF ANY HEIGHTS DEVIATE - INFORM SCOSTA CORP.

BEARING WALL & BEAM HEIGHTS

	0'-0"	ELE,
7/////		ELE/
		ELE,
		ELE
HIRRINGH		ELE
		ELE/
***************************************		ELE

TYPICAL HANGER SCHEDULE

- C SIMPSON HUS 26 M SIMPSON HGUS 28-3

 (F) SIMPSON HUS 28 N SIMPSON HHUS 48
- H SIMPSON HGUS 28 P SIMPSON LUS 24
- I SIMPSON HGUS 28-2 B SIMPSON THA 422
- W SIMPSON THJA26 X

 HANGER VALUES HAVE BEEN BASE

HANGER VALUES HAVE BEEN BASED ON 16D COMMON NAILS EXCEPT THE FOLLOWING LUS24 - 10D COMMON THJA26 - 10D x 1-1/2

APPROVAL OF THIS TRUSS LAYOUT IS NECESSARY

BEFORE FABRICATION CAN BEGIN. VERIFY DIMENSIONS, PITCHES, OVERHANGS, ELEVATIONS, CEILING & BEARING CONDITIONS. SCOSTA CORPORATION IS RESPONSIBLE FOR ACCURACY IN ACCORDANCE WITH PLANS AND/OR INFORMATION PROVIDED BY CUSTOMER, WITH ANY DEVIATIONS NOTED HEREIN. CUSTOMER IS RESPONSIBLE TO VERIFY ACCURACY OF INFORMATION AND PLANS PROVIDED TO SCOSTA CORPORATION, AND TO VERIFY CONFORMANCE TO FIELD CONDITIONS, AND/OR OWNER CHANGES. TRUSSES WILL BE BUILT IN ACCORDANCE WITH THE APPROVED LAYOUT.


APPROVED BY: ______ REQUESTED DELIVERY DATE: _____

JOBSITE CONTACT NAME:


PHONE #: _____


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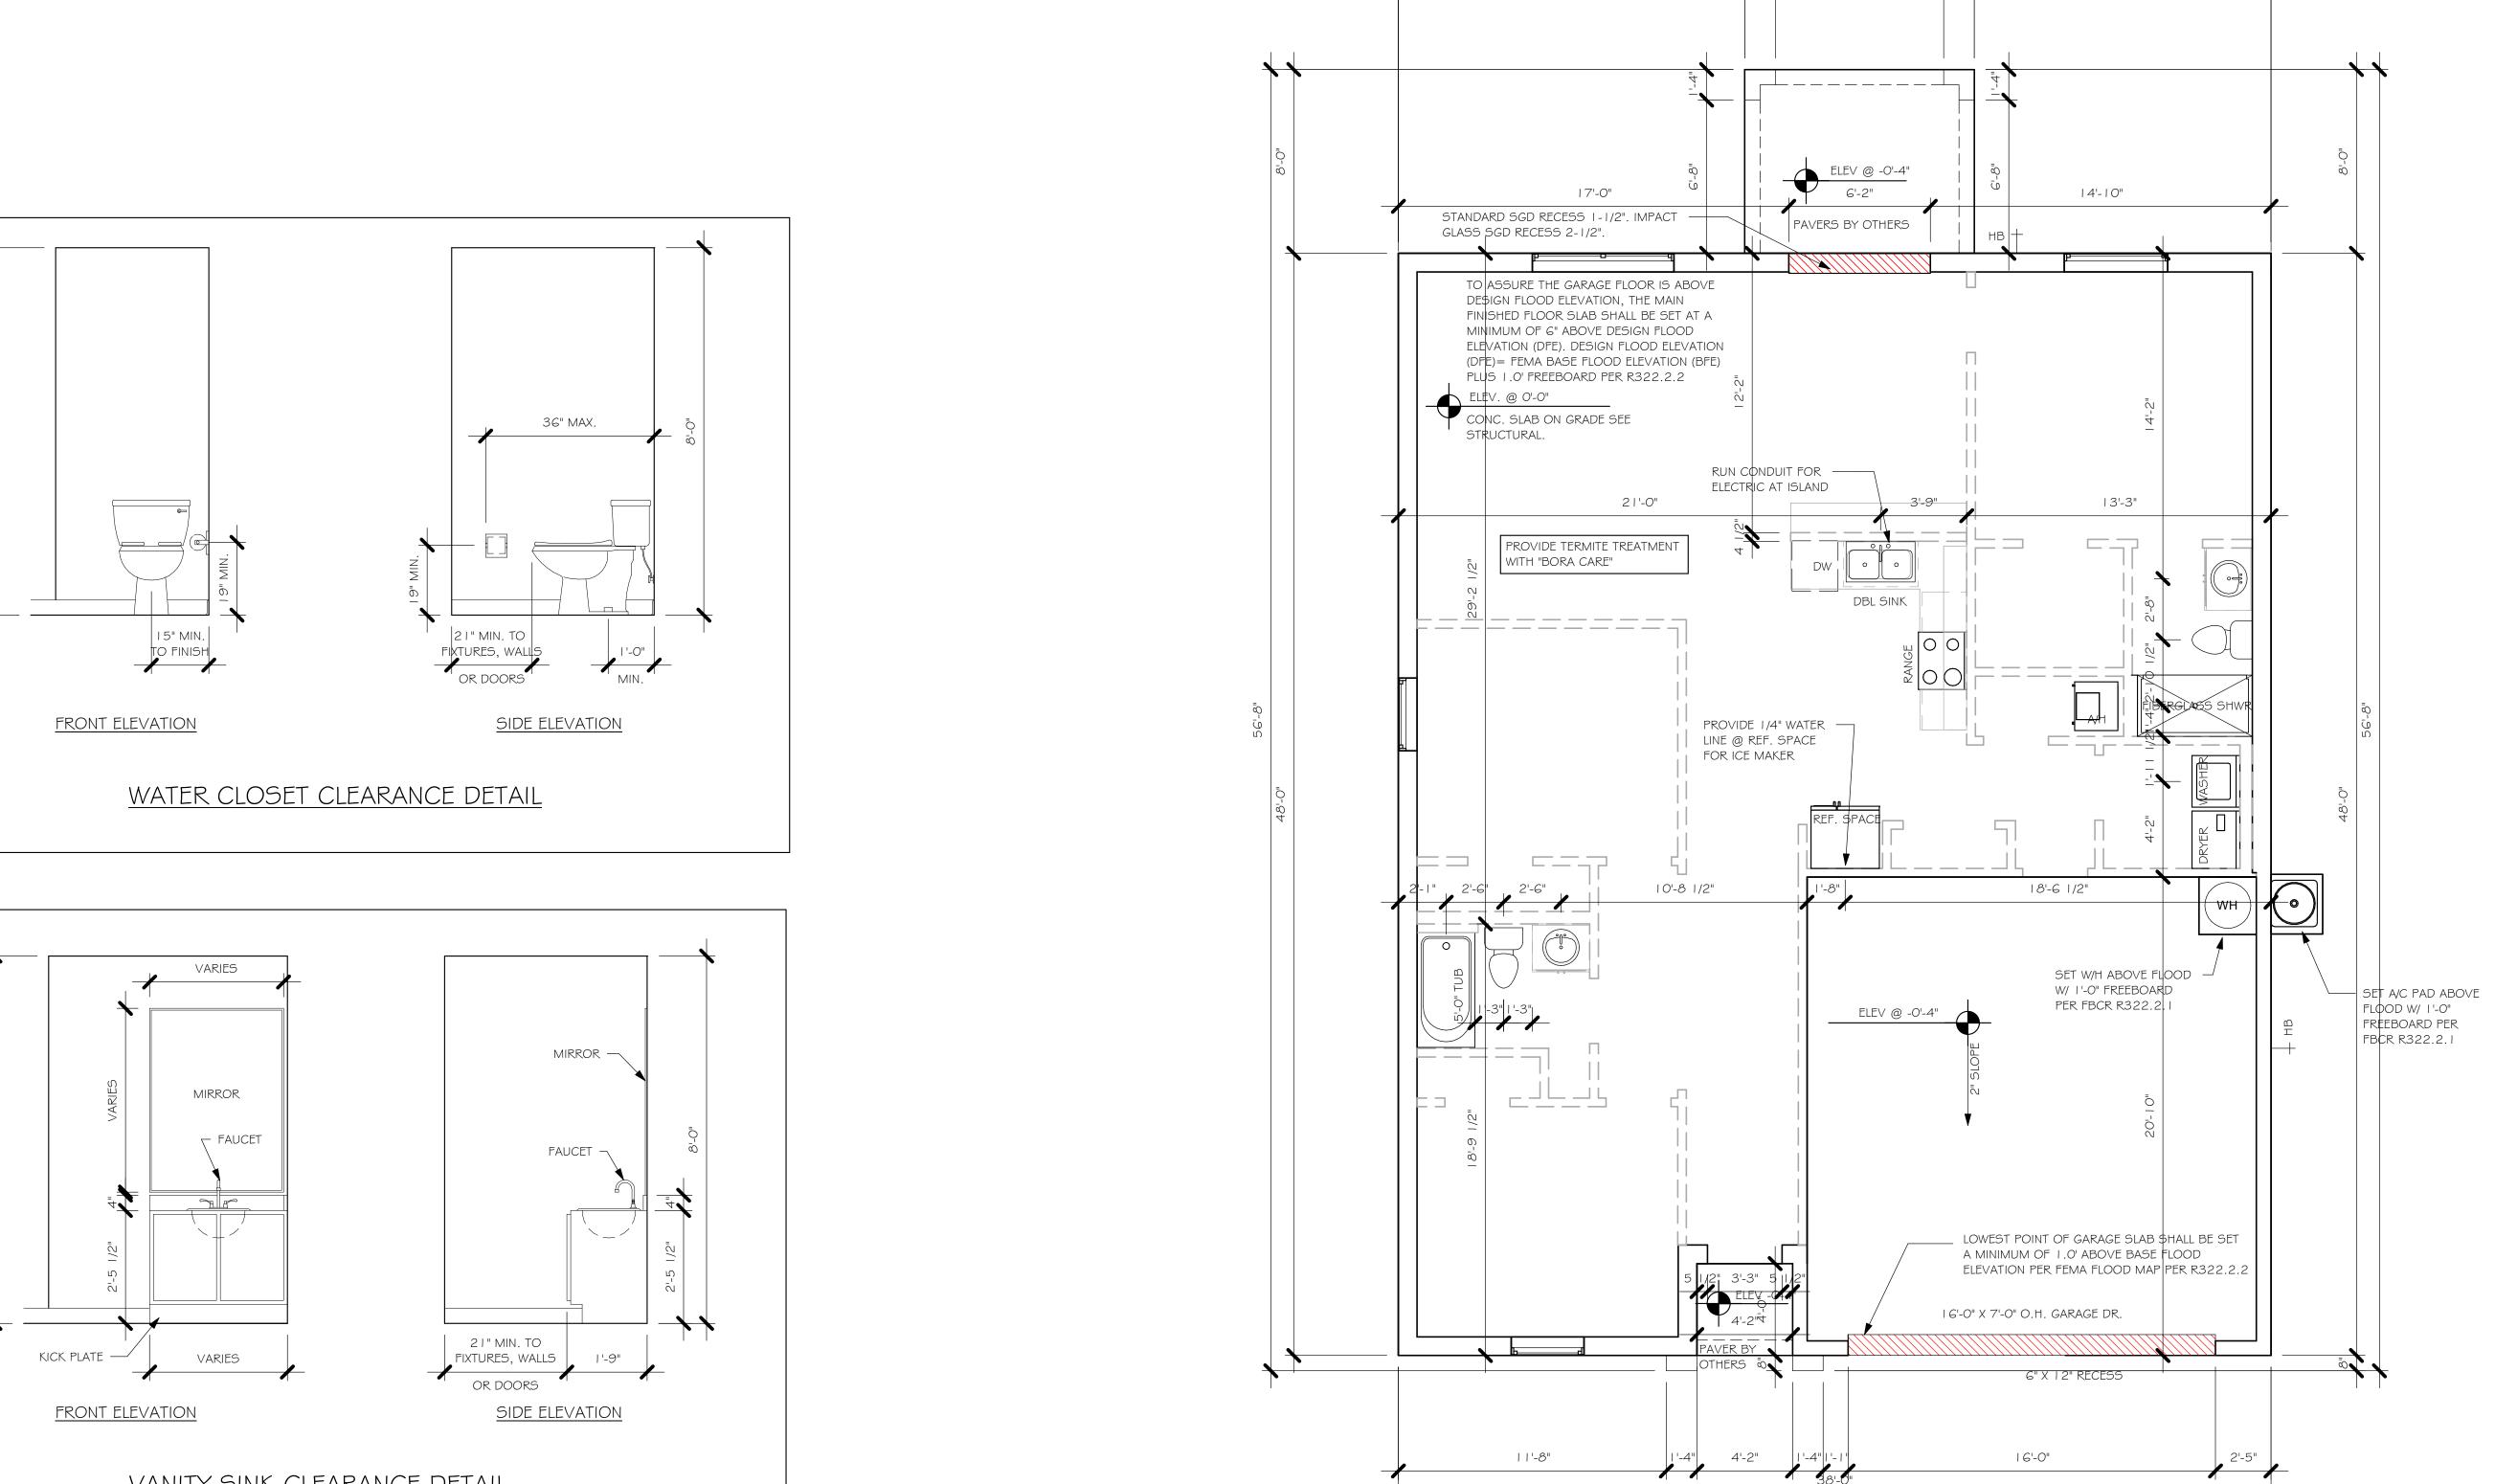


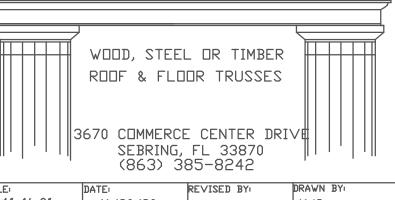

SCALE:	DATE:	REVISED BY:	DF	RAWN	BYı
1/4"=1'-0"	1/4"=1'-0" 11/30/20				
^{JOB ADDRESS:} 1389 B W/ LANAI GARAGE RIGHT LEE				1	of 1
CUSTOMER:	JDB #				
D.R. HORTON				13	89BL



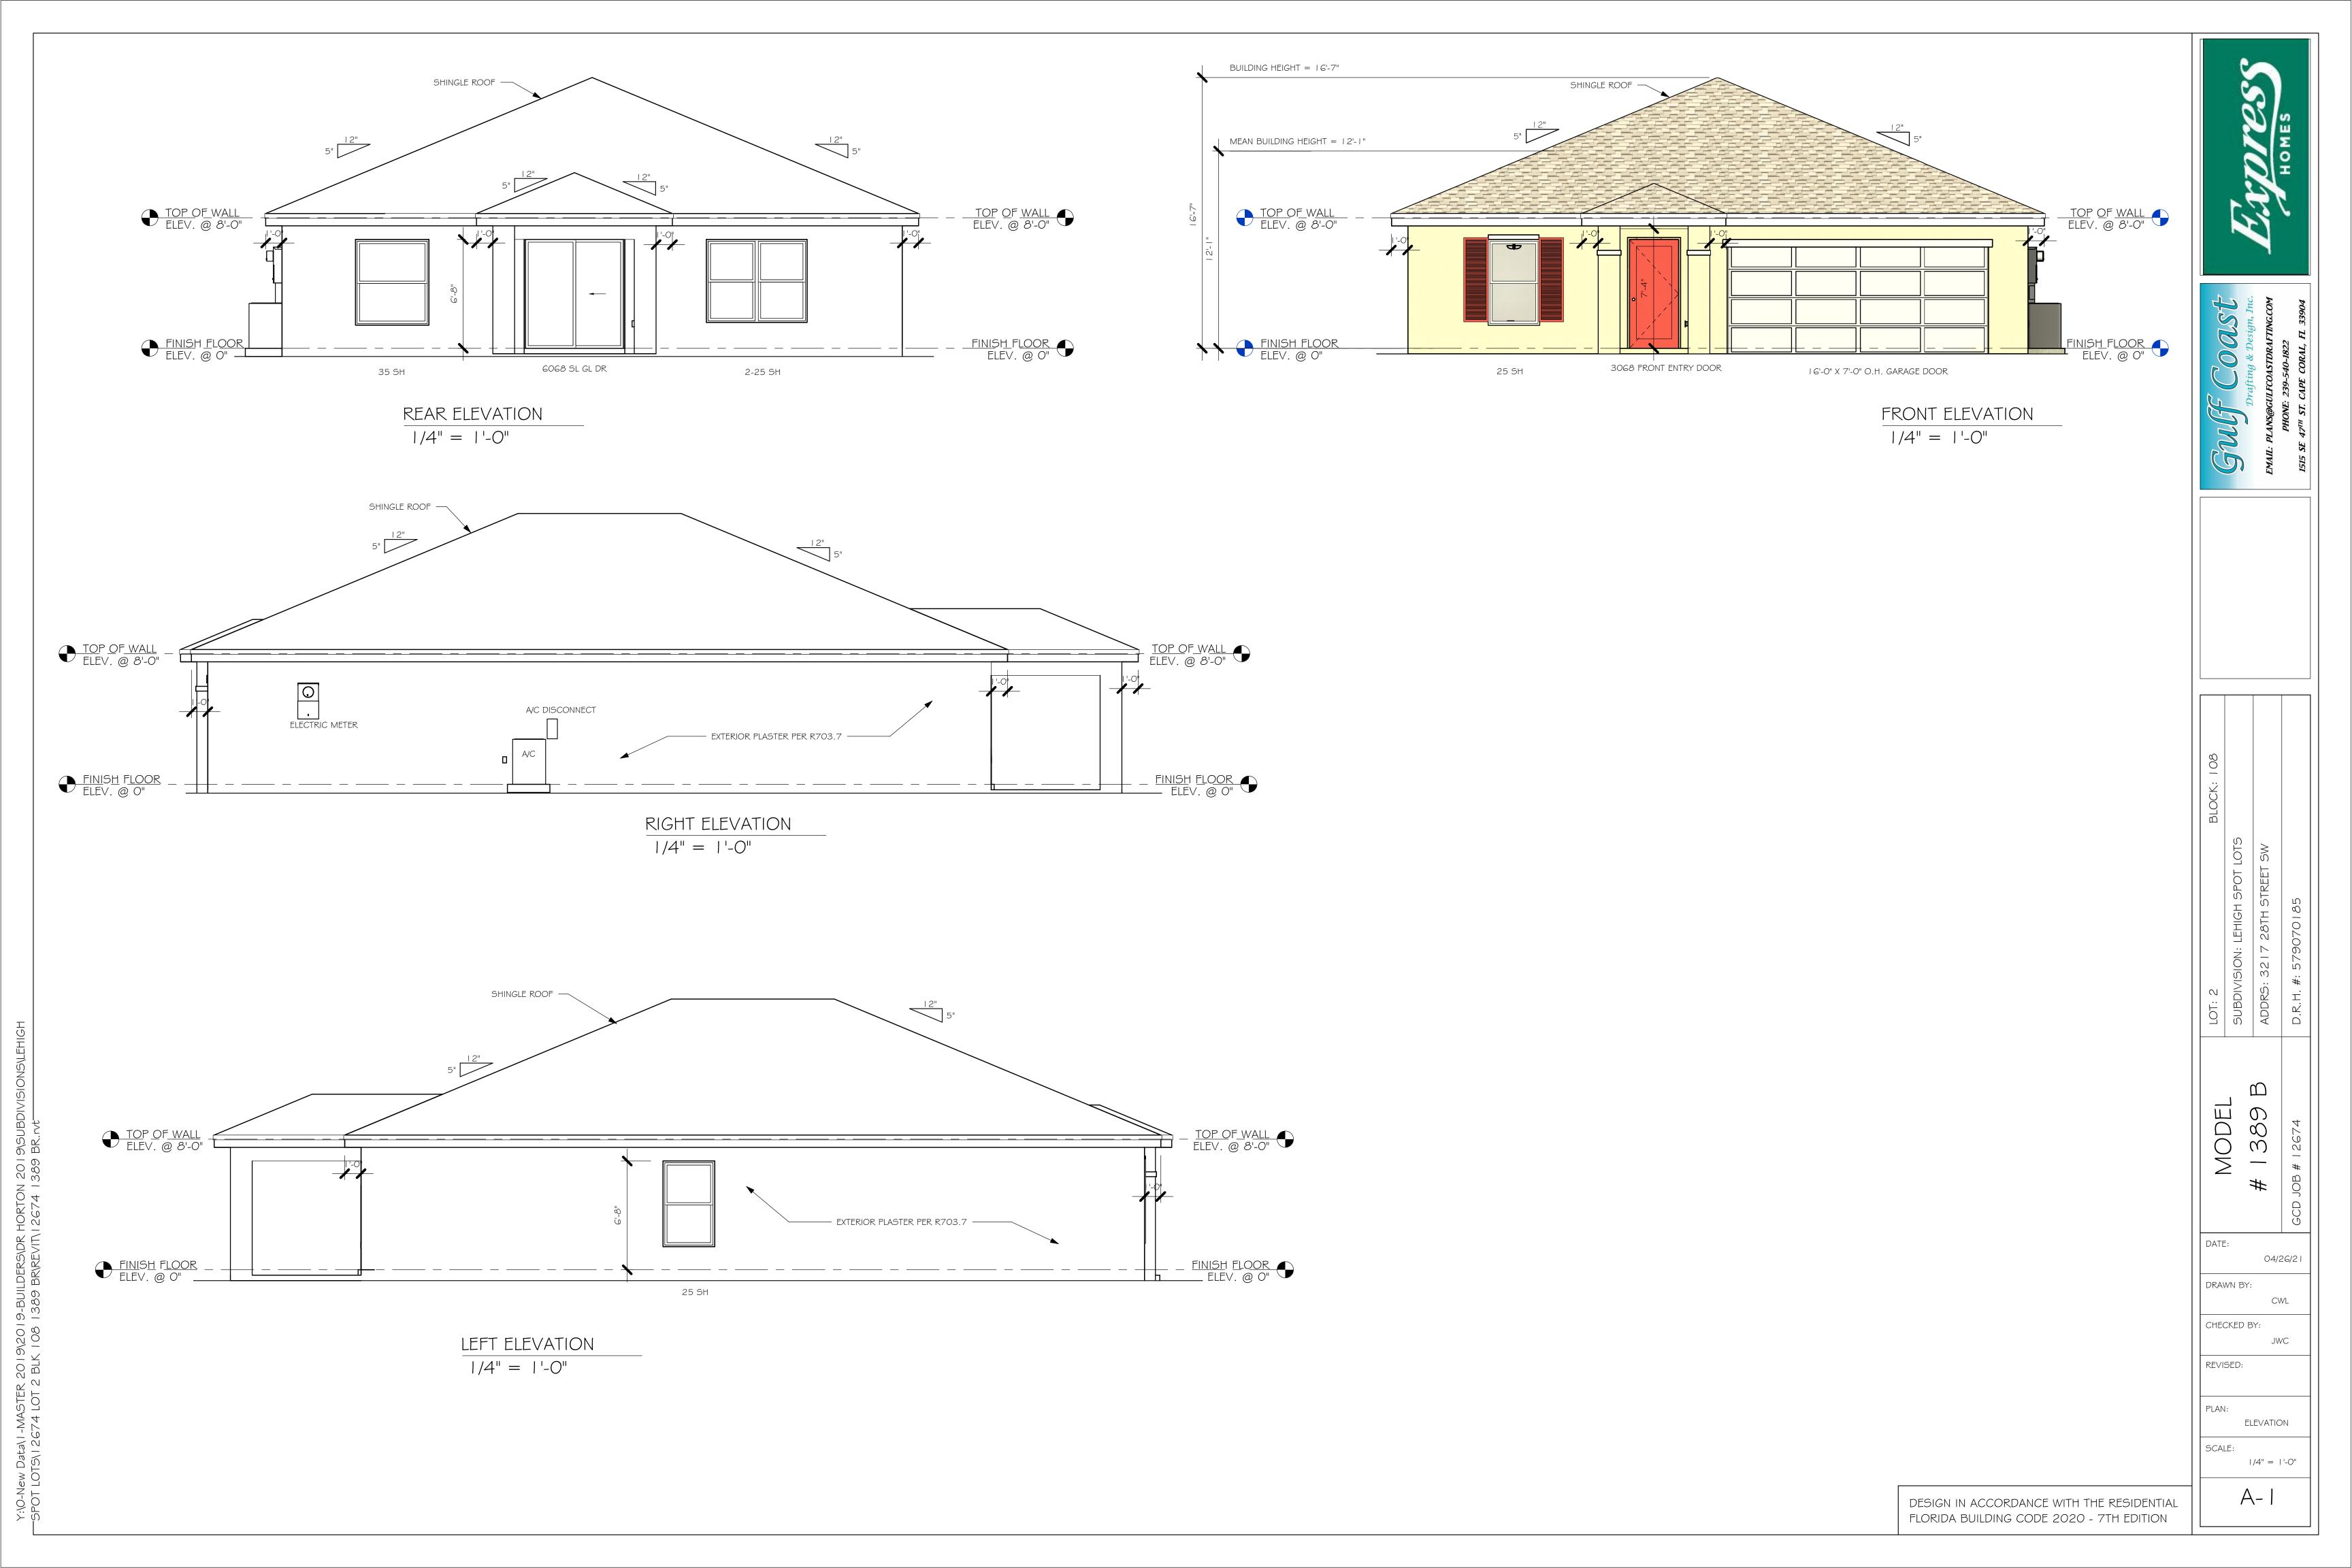

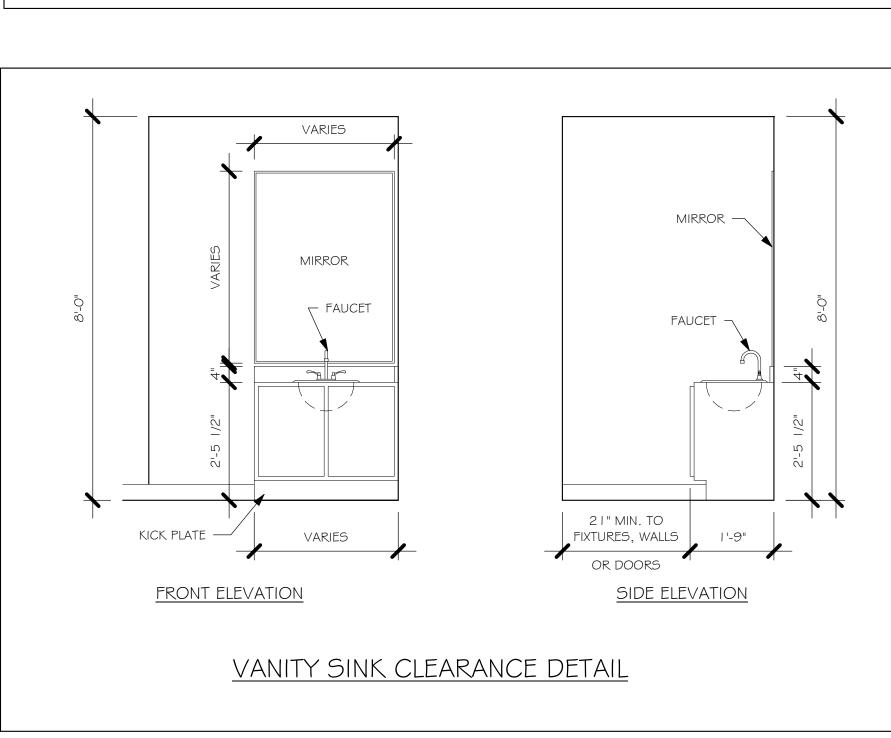

SLAB & PLUMBING 1/4" = 1'-0"

16'-0"

38'-0"

10'-0"

7'-4"

12'-11"


12'-11"

15'-1"

15'-1"

11'-8"

MODEL DATE: 04/26/21 DRAWN BY: CWL CHECKED BY: JWC REVISED: SLAB & PLUMBING SCALE: As indicated A-2 DESIGN IN ACCORDANCE WITH THE RESIDENTIAL FLORIDA BUILDING CODE 2020 - 7TH EDITION

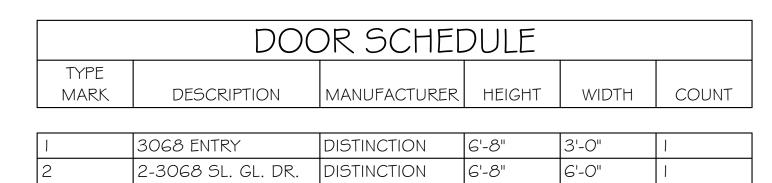

GARAGE DOOR

7'-0"

16'-0"

	WII	NDOW SC	CHEDU	LE	
MARK	DESCRIPTION	MANUFACTURER	HEIGHT	WIDTH	COUNT

А	2-25 SH	5'-3"	6'-4"	1
В	25 SH	5'-5"	3'-4"	2
С	35 SH	5'-5"	4'-8"	1

6'-8" BI-FOLD HEADER HEIGHT 82" A.F.F. 6'-8" SWING HEADER HEIGHT 82 1/2" A.F.F.	DOOR HEADERS					
6'-8" SWING HEADER HEIGHT 82 1/2" A.F.F.	6'-8" BI-FOLD	HEADER HEIGHT 82" A.F.F.	82" A.F.F.			
	6'-8" SWING	HEADER HEIGHT	82 I/2" A.F.F.			
8'-0" SWING HEADER HEIGHT 98 1/2" A.F.F.	8'-0" SWING	HEADER HEIGHT	98 I/2" A.F.F.			

PLAN NOTES

VERIFY ALL ROUGH OPENING DIMENSIONS FOR ALL WINDOWS AND DOORS

16070 OHGD

- PROVIDE SAFETY GLAZING WITHIN 24" FROM EXIT PER FLORIDA BUILDING CODE R 308.4.2.
- PROVIDE SAFETY GLAZING AT BATH/ SHOWER PER FLORIDA BUILDING CODE R 308.4.5.
- NON BEARING INTERIOR FRAME WALLS SHALL BE FRAMED W/ WOOD OR METAL STUDS. SPACING SHALL NOT EXCEED 24" O.C. (NON BEARING WALLS ONLY)
- PROVIDE DEAD WOOD IN ATTIC FOR OVERHEAD GARAGE DOOR HARDWARE
- KITCHEN KNEE WALL TO BE FRAMED W/ TOP @ 34 I/2" A.F.F.
- INSTALL SMOOTH WALLS IN KITCHEN AND ALL
- BATHROOM AREAS
- WHERE DRYWALL CEILING IS APPLIED TO TRUSSES @ 24" O.C. USE 5/8" DRYWALL OR 1/2" SAG RESISTANT PER SEC. R702.3.5
- THE GARAGE SHALL BE SEPARATED FROM THE RESIDENCE & ATTIC BY NOT LESS THEN 1/2" GYPSUM BOARD APPLIED TO THE GARAGE SIDE. GARAGES BENEATH HABITABLE ROOMS SHALL BE SEPARATED WITH NOT LESS THAN 5/8" TYPE "X" GYPSUM BOARD OR EQUIVALENT. WHERE THE SEPARATIION IS A FLOOR - CEILING ASSEMBLY, THE STRUCTURE SUPPORTING THE SEPARTION SHALL ALSO BE PROTECTED BY NOT LESS THAN 1/2" GYPSOM BOARD OR EQUIVALENT
- 10) INSTALL 1 3/8" THICK SOLID WOOD DOOR BETWEEN LIVING AND GARAGE PER FLORIDA BUILDING CODE R302.5.1,
- II) ALL WINDOWS INSTALLED 72" ABOVE GRADE MUST COMPLY WITH R3 | 2.2 MIN 24" SILL HEIGHT OR PROVIDED WITH AN APPROVED WINDOW FALL PREVENTION DEVICE
- 12) ALL CLOSET SHELVES TO BE 12". ALL PANTRY \$ LINEN TO BE (4)-16" SHELVES 18" O.F.F. W/ 15" INCREMENT.
- 13) ALL MECHANICAL AND ELECTRICAL EQIUPMENT TO BE INSTALLED AT OR ABOVE FLOOD PLUS 1'-0" FREEBOARD.

INTERIOR DOOR SCHEDULE						
MARK	DOOR WIDTH	NOTES				
	3'-0"	P.K. = POCKET DOOR				
2	2'-8"	B.F. = BI-FOLD DOOR				
3	2'-6"	D.1 DI-1 OLD DOOK				
4	2'-4"	B.P. = BI-PASS DOOR				
5	2'-0"	L.V. = LOUVERED DOOI				
6	1'-8"					
7	1'-6"					
8	2'-11"					


SQUARE FOOTAGE				
LIVING AREA I,389				
GARAGE AREA 419				
LANAI AREA 80				
FRONT PORCH/ ENTRY AREA	16			
TOTAL SQUARE FOOTAGE	1,904			

CABINET BACKING						
KITCHEN	UPPER TOP @ 84"	BASE TOP @ 35"				
MASTER BATH	UPPER	BASE TOP @ 35"				
GUEST BATH	UPPER	BASE TOP @ 31"				
LAUNDRY ROOM	UPPER TOP @ 84"	BASE				


TYPICAL DIMENSION STRING

FACE OF OUTSIDE WALL TO FACE OF STUD WALL FACE OF STUD TO FACE OF STUD

		TOWEL BAR	ALL TUB DECKS @ 21" A.F.F
	TP	TOILET PAPER	ALL BLOCKING TO BE PT IN SHOWERS
/2"		4.0"	TOWEL BAR TOILET PAPER ROLL A'' 4" MINMIN.

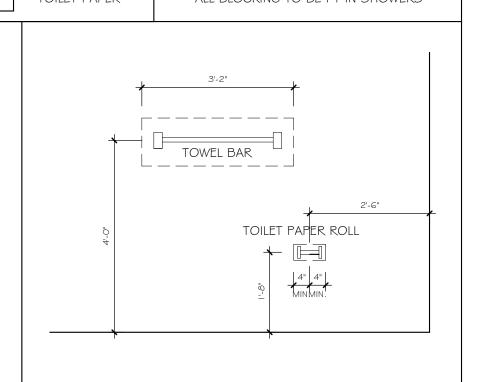

BATHROOM NOTES

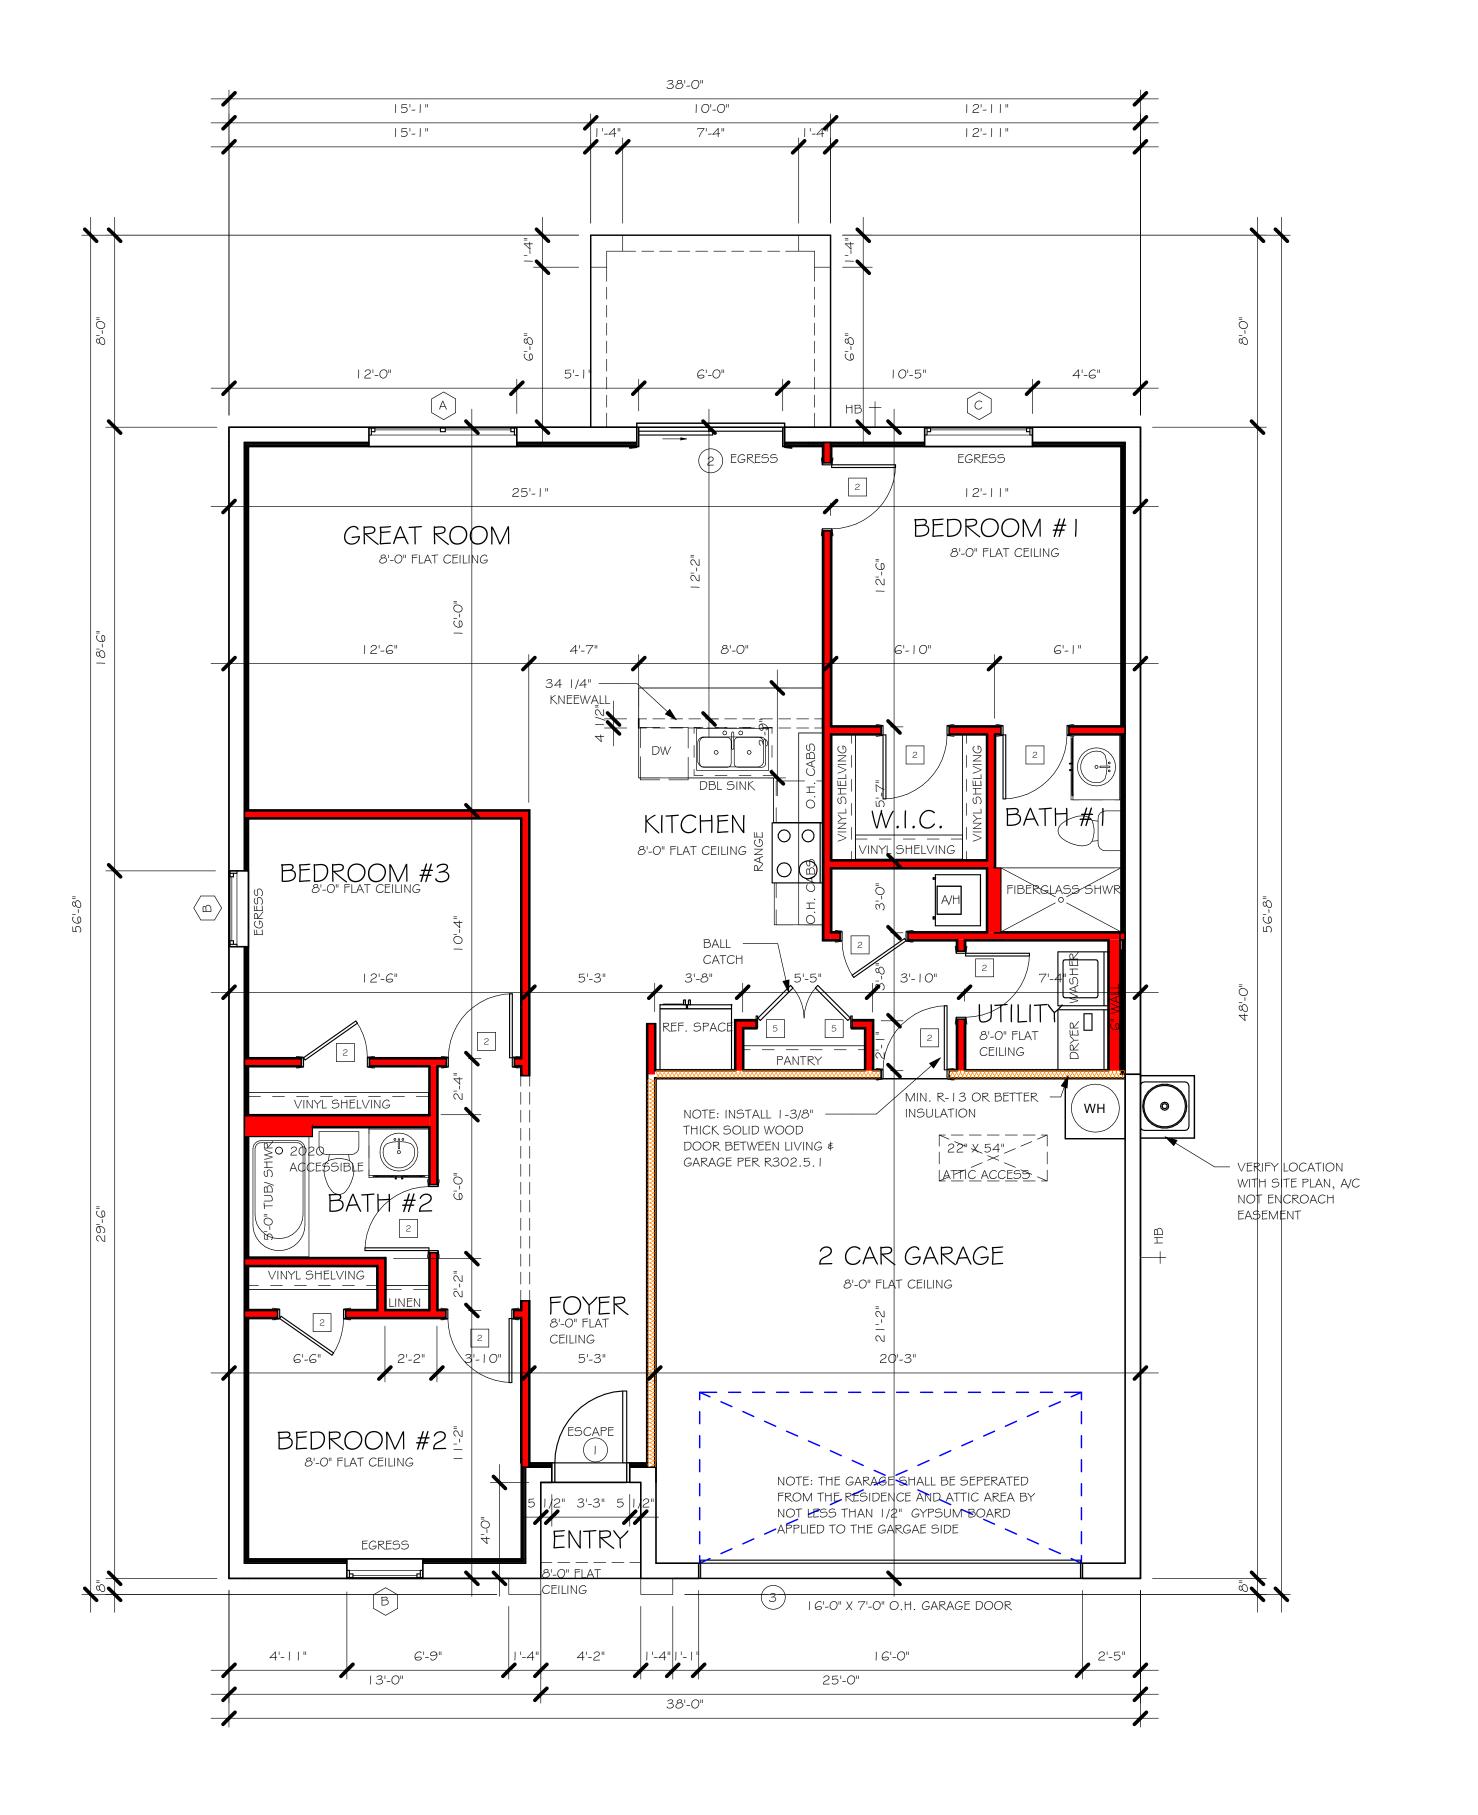

FLOOR PLAN 1/4" = 1'-0"

> DESIGN IN ACCORDANCE WITH THE RESIDENTIAL FLORIDA BUILDING CODE 2020 - 7TH EDITION

DATE:

DRAWN BY:

CHECKED BY:

REVISED:

SCALE:

04/26/21

CWL

JWC

FLOOR

As indicated

FACE OF EXTERIOR WALL —

MODEL DATE:

04/26/21 DRAWN BY: CWL CHECKED BY: JWC REVISED:

PLAN: ROOF SCALE: As indicated

A-4

DESIGN IN ACCORDANCE WITH THE RESIDENTIAL FLORIDA BUILDING CODE 2020 - 7TH EDITION

MODEL 1389 B: ATTIC VENTILATION FBCR R806 COORDINATE VENTING REQUIREMENTS WITH ENERGY CALCULATIONS SOFFIT ONLY (1/150) (NO ROOF VENTS) WITH ROOF VENTS (1/300) (R.V.) AREAS (SQ. FT.) ATTIC VENTILATION REQUIRED ATTIC VENTILATION REQUIRED ATTIC AREA/150 | REQ'D AIR FLOW | QUAD 4 SOFFIT | HAS | 13.33 SQ. FT. | 7.57% | 8.15% ATTIC AREA/300 QUANTITY OF ROOF VENTS MIN AIR FLOW OF SOFFIT MARK ATTIC SOFFIT 1st STORY 2000.0 SQ. FT. 176.0 SQ. FT. -.-- SQ. FT. -ROOF VENTS ARE NOT REQUIRED "SOFFIT ONLY" QUALIFIES ROOF VENT MODEL SOFFIT MODEL ACM QUAD 4, FULL VENT, NARROW PATTERN, 8.15% FREE AIR FLOW LOMANCO 770-D 0.97 SQ. FT. FREE AIR

> WALL HEIGHT = WALL @ 8'-0"

GREAT ROOM 8'-0" FLAT CEILING BEDROOM #3 8'-0" FLAT CEILING FOYER 8'-0" FLAT CEILING

BEDROOM

ROOF PLAN 1/4" = 1'-0" BEDROOM

2 CAR GARAGE

\rightarrow	DUPLEX RECEPTACLE OUTLET				
$\overline{\rightleftharpoons}$	I/2 SWITCHED DUPLEX OUTLET				
AFF	DUPLEX RECEPTACLE AT ELEV. A.F.F.				
=	DUPLEX RECEPTACLE - ABOVE COUNTER				
Θ	SINGLE POLE SWITCH				
() ³	3 WAY SWITCH				
() □	DIMMER SWITCH				
₩ ^S	MOTION SENSOR SWITCH				
S _{SD}	AC/DC SMOKE DETECTOR TO BE INTERCONNECTED ANY RESIDENT HAVING A FOSSIL-BURNING HEATER OR APPLIANCE, A FIREPLACE, OR AN ATTACHED GARAGE SHALL HAVE AN OPERATIONAL CARBON MONOXIDE ALARM INSTALLED WITHIN 10 FEET OF EACH ROOM USED FOR SLEEPING PERPOSES. PER RULE 9B-3.04.72 SD (SMOKE DETECTOR) SCD (CARBON MONOXIDE/ SMOKE DETECTOR)				
-[T]	TELEPHONE OUTLET				
-TV	TELEVISION RECEPTION OUTLET				
-	SURFACE MOUNTED CEILING LIGHT				
0	FLUSH MOUNTED LIGHT				
Ю	WALL MTD. BRACKET LIGHT				
46	DUPLEX FLOOD LIGHT				
	EXHAUST FAN				
	LXHAUSH FAN				
	TRACK MTD. LIGHTS				
	TRACK MTD. LIGHTS				
	TRACK MTD. LIGHTS A/C DISCONNECT				
	TRACK MTD. LIGHTS A/C DISCONNECT PUSH BUTTON (PB) / DOOR BELL (DB)				
	TRACK MTD. LIGHTS A/C DISCONNECT PUSH BUTTON (PB) / DOOR BELL (DB) INTERCOM				

EXTERIOR OUTLETS TO BE GFI'S.

INSTALL PHONE AND T.V PER CONTRACT.

INSTALL ALL ELECTRICAL PER NEC 2014

ELECTRICAL LEGEND

ELECTRICAL METER

I 20 V JUNCTION BOX

SINGLE RECEPTACLE OUTLET


220 V RECEPTACLE OUTLET


4-PLEX RECEPTACLE OUTLET

ELECTRICAL PANEL

ECTRICAL DIAM 120

	ELECTRIC	AL PLAN 1389	
200	AMP SERVICE		
TAG	QUANTITY	PRODUCT	
Α	(X)	(FLUSH MOUNTED LT)	
В	(X)	(VAPORS)	
С	(X)	(PENDANT LIGHT	
D	(10)	(10" MUSHROOMS)	
E	(2)	(24" 3 LT)	
F	(X)	(36" 4 LT)	
G	(X)	(NOT USED)	
Н	(2)	(COACH LIGHTS)	
	(X)	(COACH LIGHTS)	
J	(X)	(J BOX)	
K	(1)	(4' FLUORESCENT)	
L	(X)	(2' FLUORESCENT)	
М	(X)	(5LT CHANDELIER)	
Ν	(X)	(3 LT)	
0	(X)	(PENDANT/ NOOK)	
Р	(X)	(X)	
0	(X)	(X)	

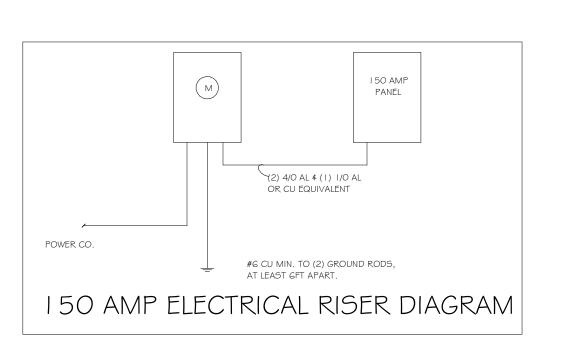

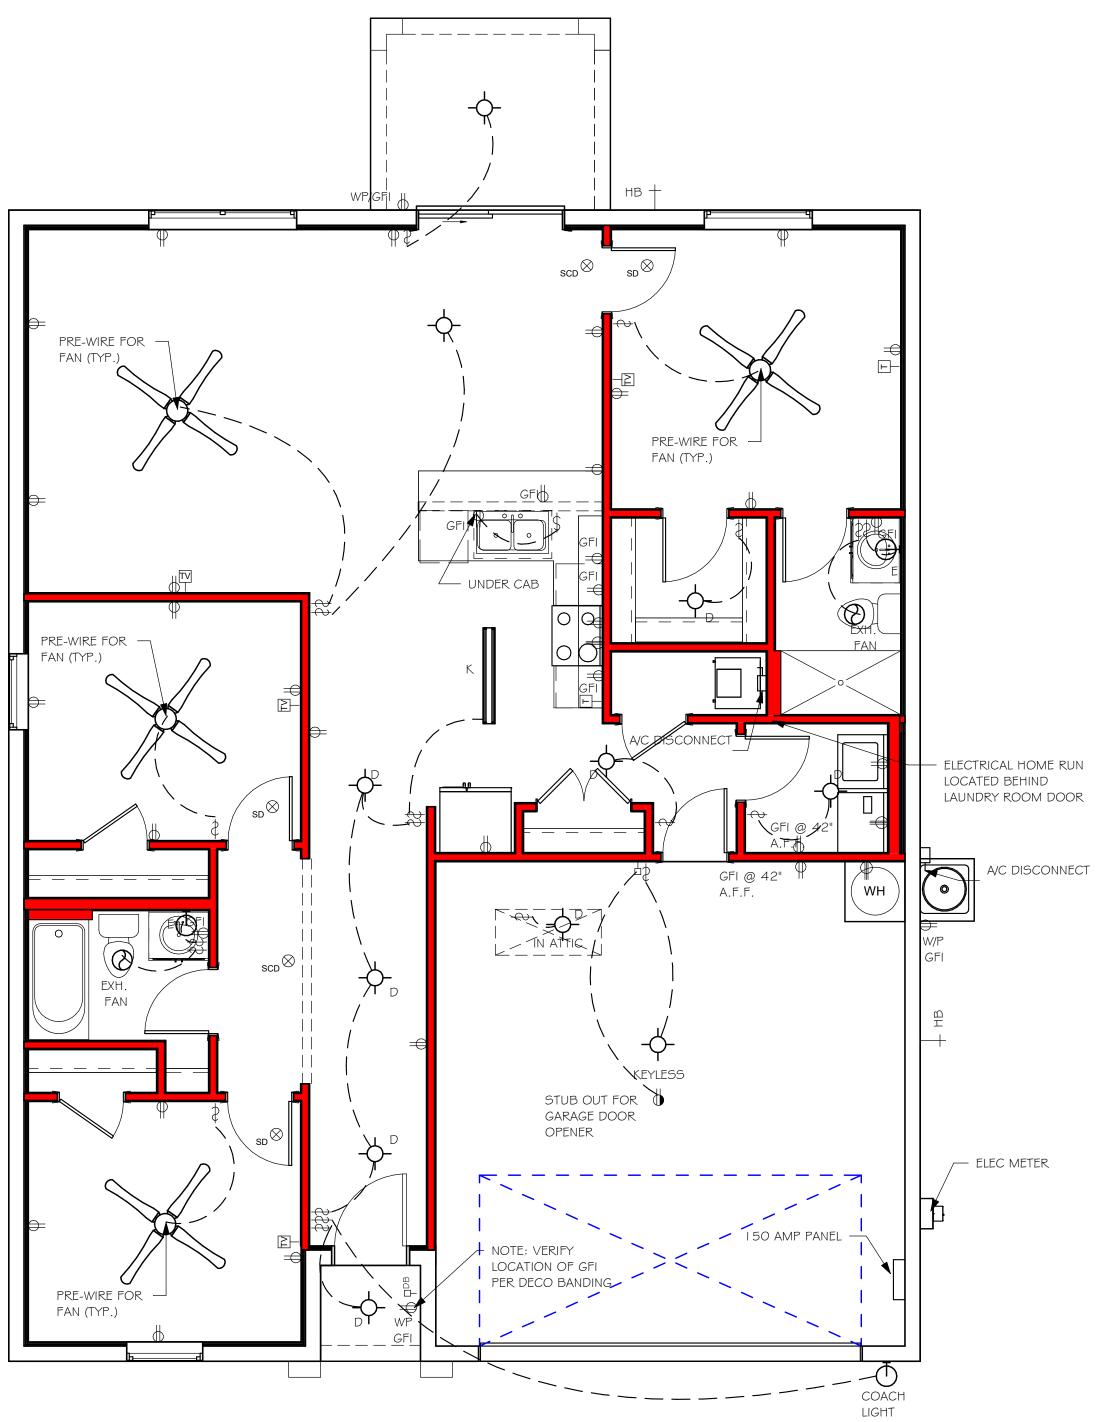

DATE:

O4/26/21

DRAWN BY:

CWL

CHECKED BY:

JWC

REVISED:


PLAN:


ELECTRIC

SCALE:

As indicated


A-5

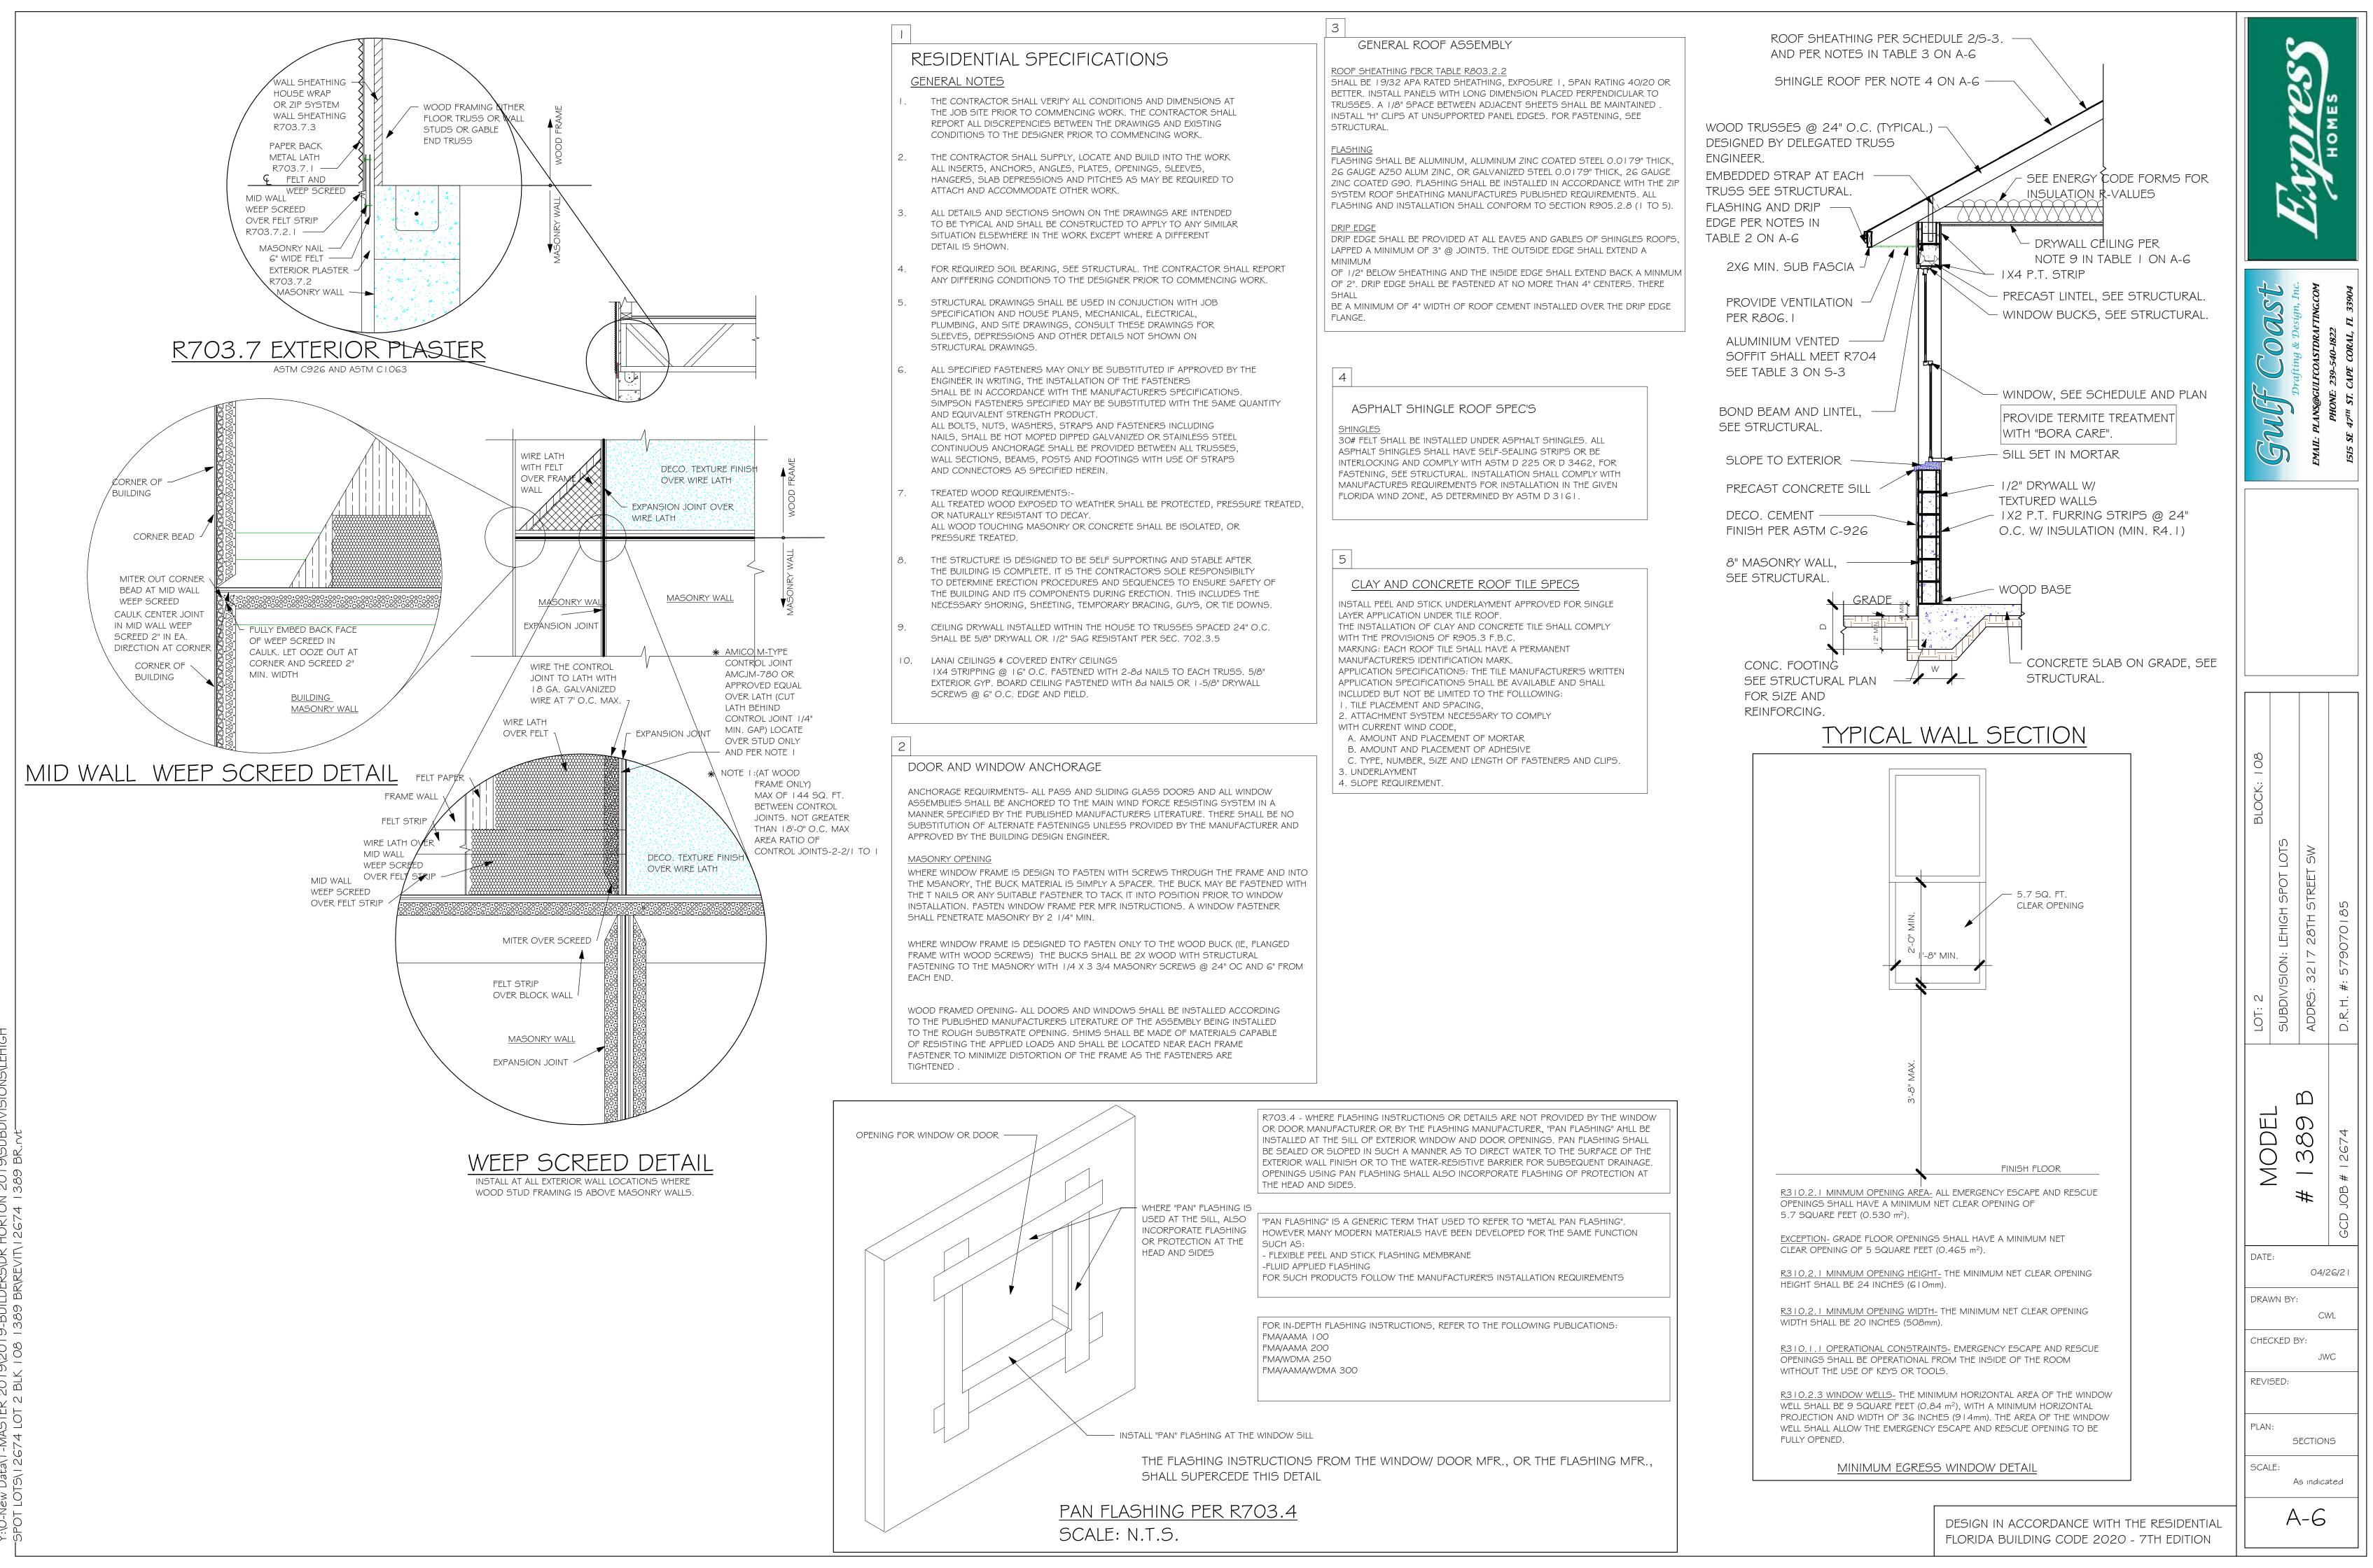

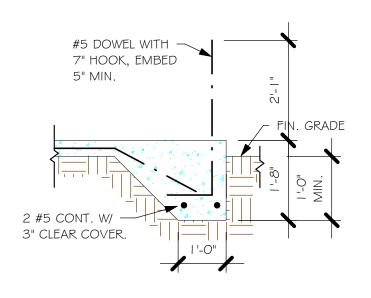


"F3" FOOTING


1/2" = 1'-0"

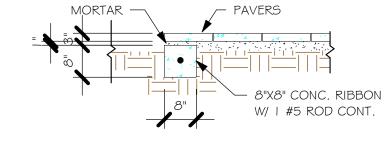

"P" PAVERS DETAIL ENTRY/ LANAI 1/2" = 1'-0"

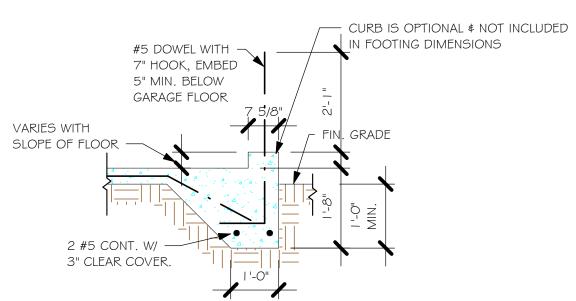




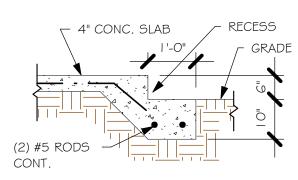

GARAGE DOOR RECESS 1/2" = 1'-0"

"F3" WITH CURB AT GARAGE 1/2" = 1'-0"

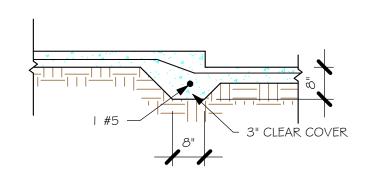

 $\frac{\text{"F6A" STEP DOWN}}{1/2\text{"} = 1\text{'-0"}}$

		PAD FOOTING SCHEDULE							
Ü	BOTTOM REINF.								
USED	TYPE	LENGTH	WIDTH	DEPTH	LONG WAY	SHORT WAY	REMARKS		
X	$\langle \mathbf{A} \rangle$	2'-6"	2'-6"	1'-0"	3-#5	3-#5	-		
	(B)	3'-0"	3'-0"	1'-0"	4-#5	4-#5	-		
	(c)	3'-6"	3'-6"	1'-0"	4-#5	4-#5	-		
	$\langle \mathbf{D} \rangle$	4'-0"	4'-0"	1'-2"	5-#5	5-#5	-		
	(E)	5'-0"	5'-0"	1'-2"	6-#5	6-#5	-		


SED	TYPE	LENGTH	WIDTH	DEPTH	BOTTOM REINFORCING	SHAPE	-
_	F1	CONT.	1'-4"	0'-8"	2-#5		_
	F2	CONT.	1'-8"	0'-10"	2-#5		
X	F3	CONT.	1'-0"	1'-8"	2-#5		ADD CURE GARAGE, S DETAIL
	F4	CONT.	1'-4"	1'-8"	2-#5	_	DETAIL
	F5	CONT.	1'-4"	1'-0"	2-#5		
	F6	CONT.	1'-4"	1'-0"	2-#5	F	
X	F6A	CONT.	0'-8"	0'-8"	1-#5		
	TE	CONT.	0'-8"	0'-8"	1-#5	F	1

PROVIDE CORNER BARS PER 6/S-3



SCALE: 1/4" = 1'-0"

- **PLAN NOTES:** TOP OF GROUND FLOOR SLAB DATUM ELEVATION 0'-0"
- "F#" DENOTES CONTINUOUS WALL FOOTING TYPE PER SCHEDULE THIS SHEET.
- PROVIDE #5 VERTICAL REINFORCING AT DOT LOCATIONS SHOWN ON PLAN FROM FOOTING ALL DIMENSIONS ARE TO OUTSIDE FACE OF MASONRY WALLS. SOME SLAB EDGES MAY EXTEND BEYOND FACE OF WALL.
- FOR DIMENSIONS OF ROUGH OPENINGS IN MASONRY WALLS, COORDINATE WITH WINDOW/
- PROVIDE PRESSURE TREATED BUCKS AT WINDOWS/ DOORS PER DETAIL 7/S-3.

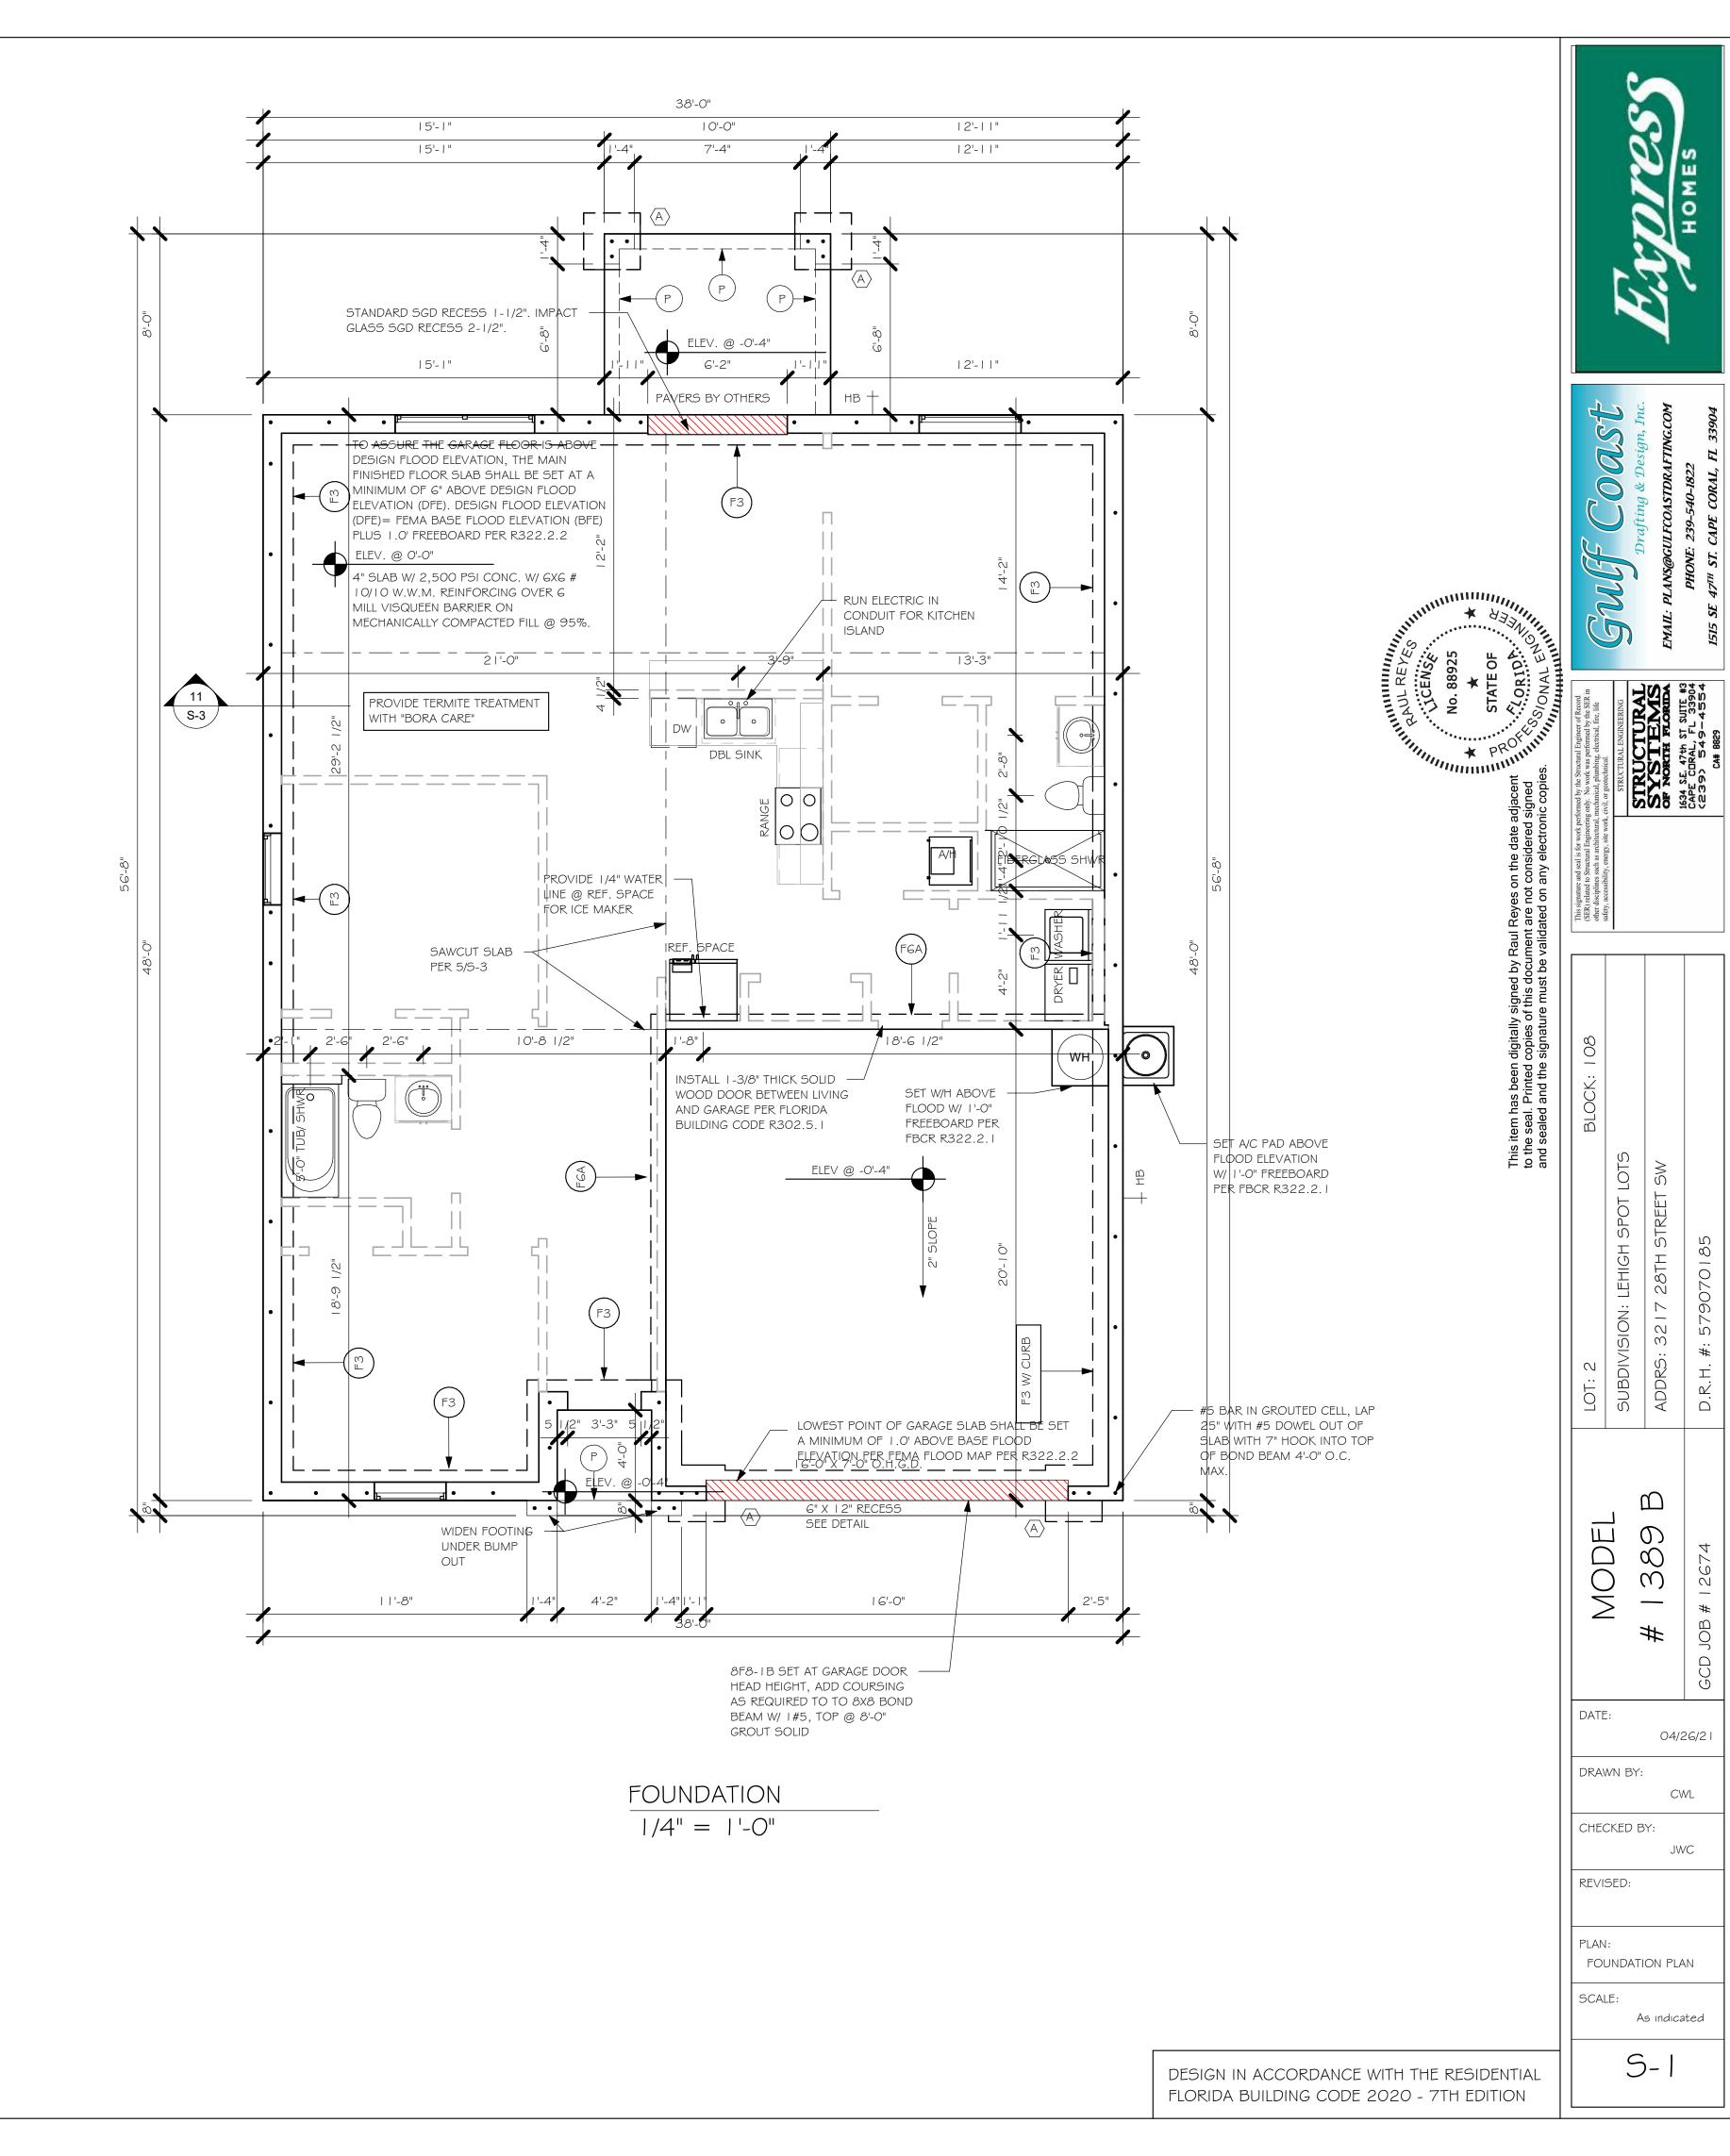

10690 /DF /SP (2 PLY)

10790 /SYP (3PLY)

META 16 AT

TRUSSES

HIGHER

UPLIFTS,

ON PLAN.

SEE NOTES

UPLIFT. FOR

- I. PROVIDE A STRAP FROM THE ABOVE LIST AT EACH ROOF TRUSS BEARING POINT, BASED ON THE TRUSS UPLIFT VALUES IN THE SIGNED AND SEALED TRUSS DESIGN PACKAGE AND SUITABLE FOR THE GEOMETRY. EMBED STRAP ON CENTERLINE OF WALL.
- ANY OF THE VALID LENGTHS SHOWN MAY BE USED IN PLACE OF THE LENGTH SPECIFIED ON PLAN.

(1)HGT - 2


(1)HGT - 3

- CONNECTORS ARE SIMPSON STRONG TIE. ALL CONNECTORS SHALL BE INSTALLED IN STRICT ACCORDANCE WITH SIMPSON PRINTED INSTUCTIONS. SUBSTITUTIONS MUST BE APPROVED IN WRITING BY THE ENGINEER OF RECORD.
- 4. WHERE EMBEDDED STRAPS ARE MISSING, OR MIS-LOCATED, INSTALL RETROFIT STRAP PER 10/S-3.

PER UPLIFT IN TRUSS ENGINEERING. SIMPSON CATALOG C-C- 2019


(16) O.148x3", (2) 3/4" ATR, EPOXY 12"


(16) O.148x3", (2) 3/4" ATR, EPOXY 12"

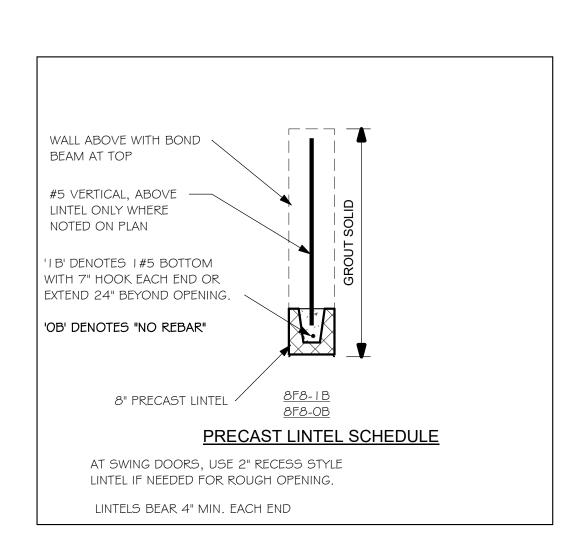

PLAN NOTES:

- ROOF TRUSS BEARING @ 8'-0".
- BYA DELEGATED TRUSS ENGINEER PER DESIGN
- FOR NAILING OF ROOF AND FLOOR DECK, SEE | AND 2

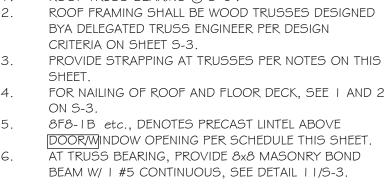


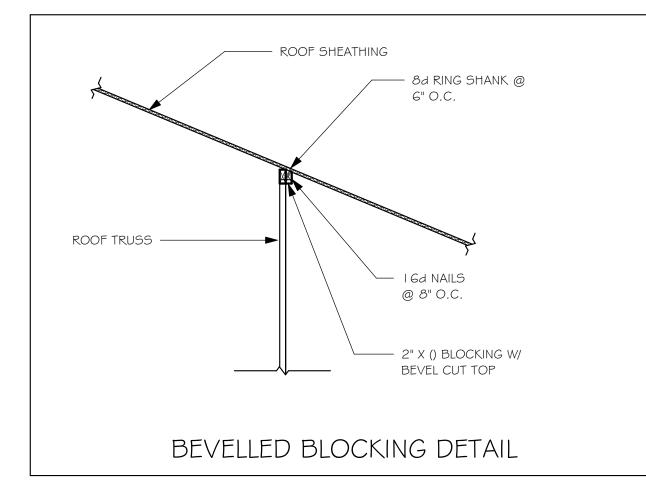

TRUSS BEARING CONDITIONS AND STRAPPING IS BASED ON TRUSS LAYOUT PREPARED BY SCOSTA JOB#: DR | 389BL DATED: | 1/30/20 REVISED: NONE



= BEARING @ 8'-0"

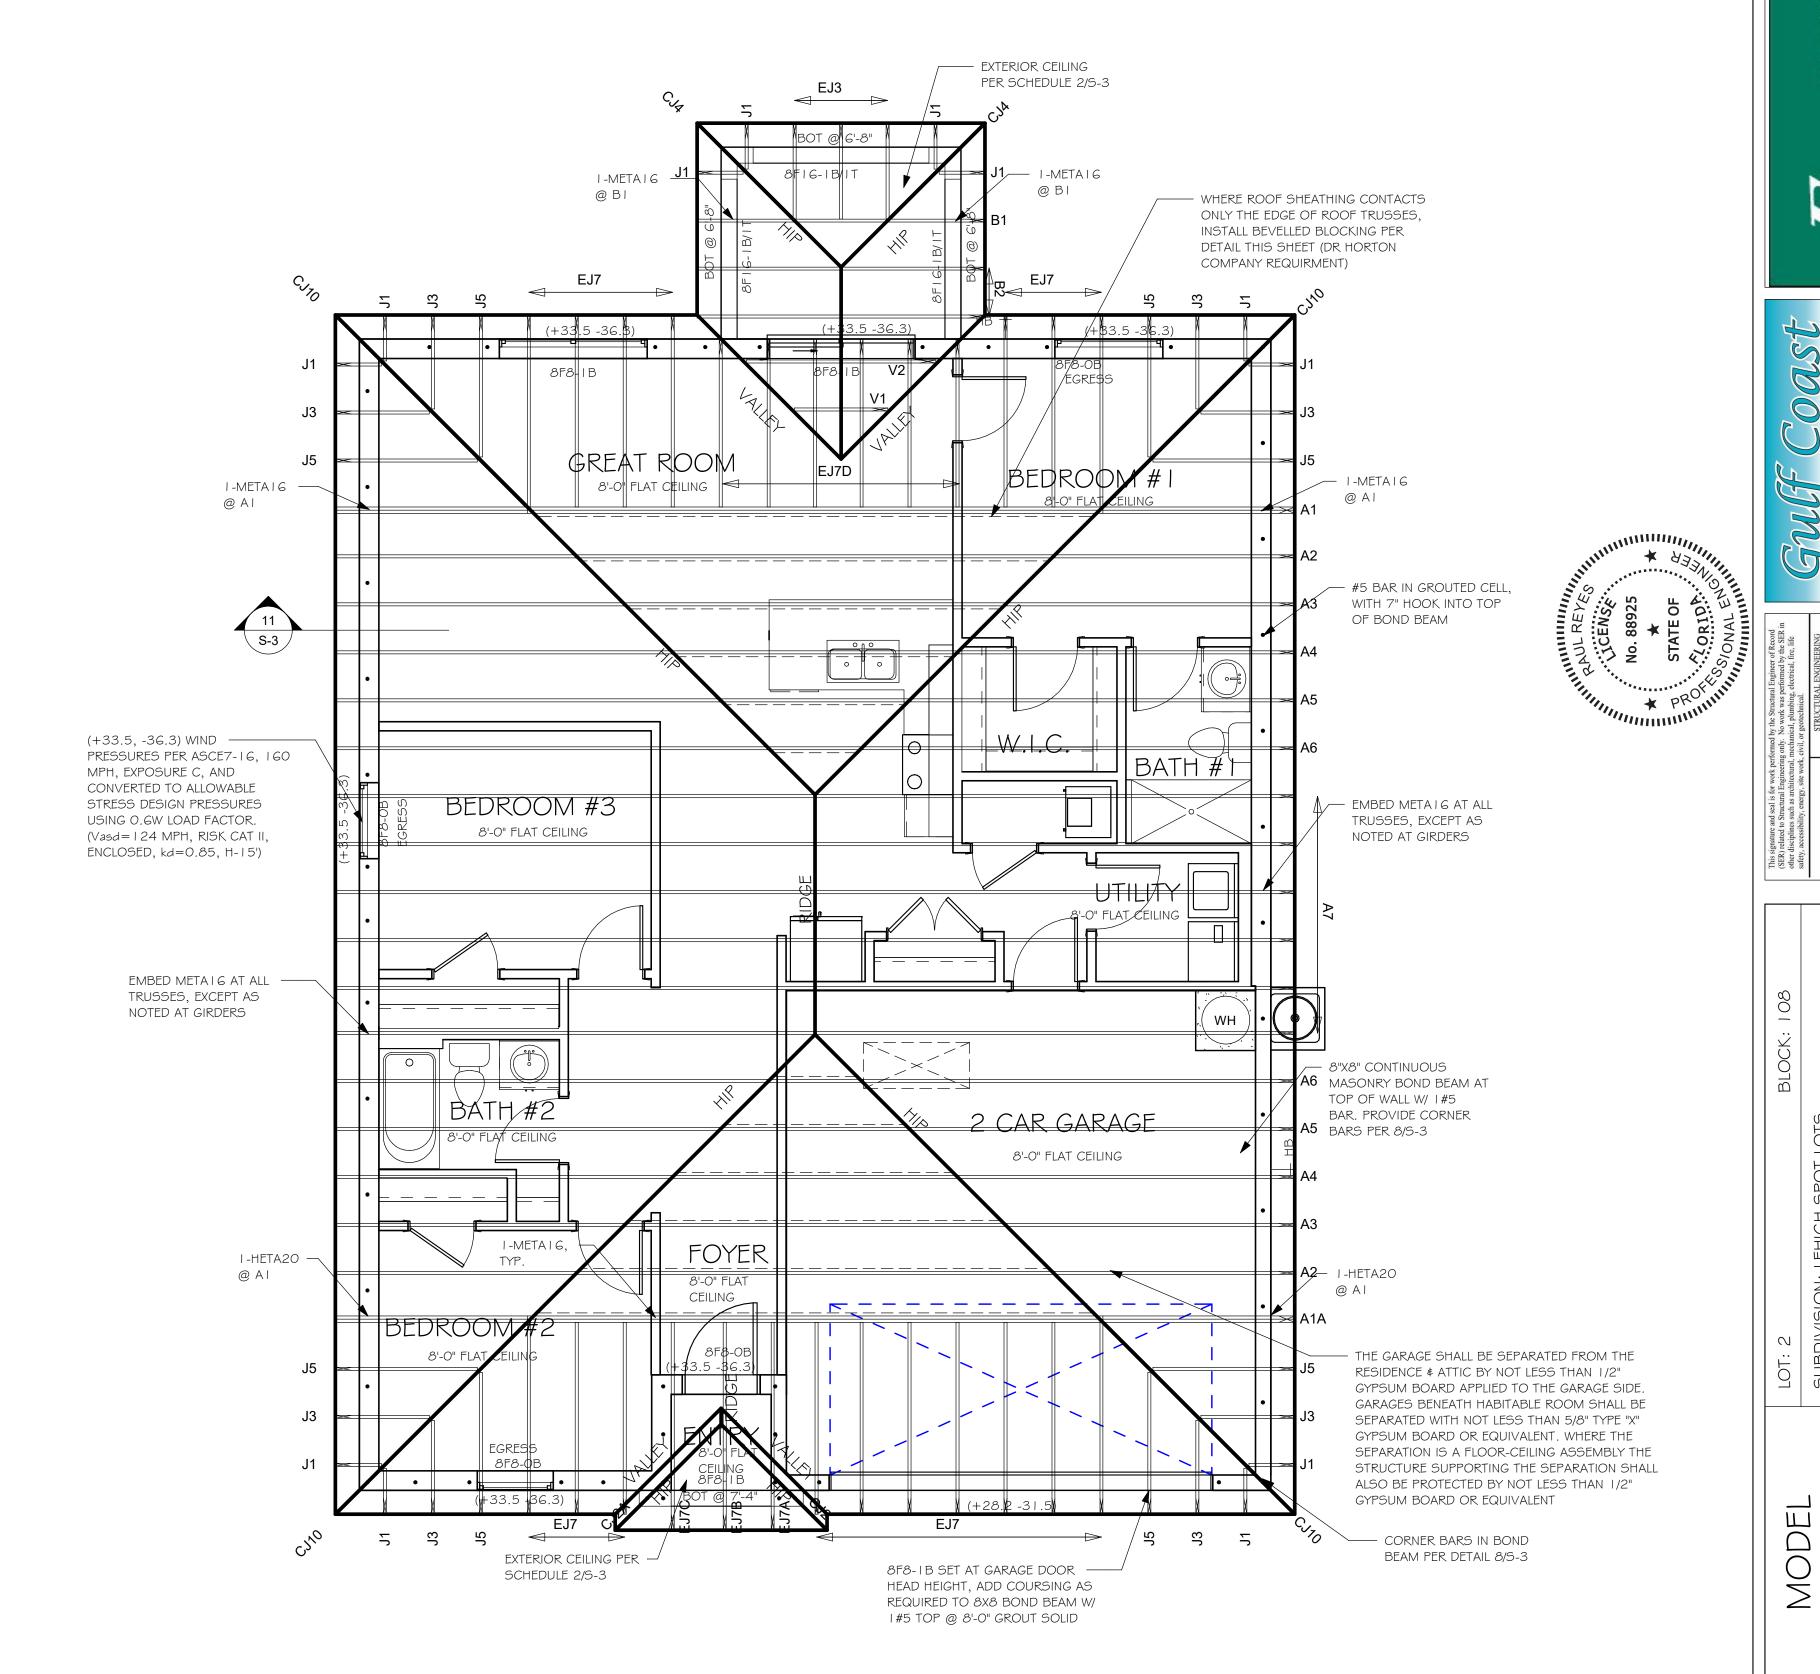

ROOF FRAMING PLAN 1/4" = 1'-0"

> DESIGN IN ACCORDANCE WITH THE RESIDENTIAL FLORIDA BUILDING CODE 2020 - 7TH EDITION

As indicated

ROOF FRAMING PLAN

1510N: LEHIGH 9 : 3217 28TH 5

 \mathcal{O}

 \emptyset

 \mathcal{C}

04/26/21

CWL

JWC


DATE:

DRAWN BY:

CHECKED BY:

REVISED:

SCALE:

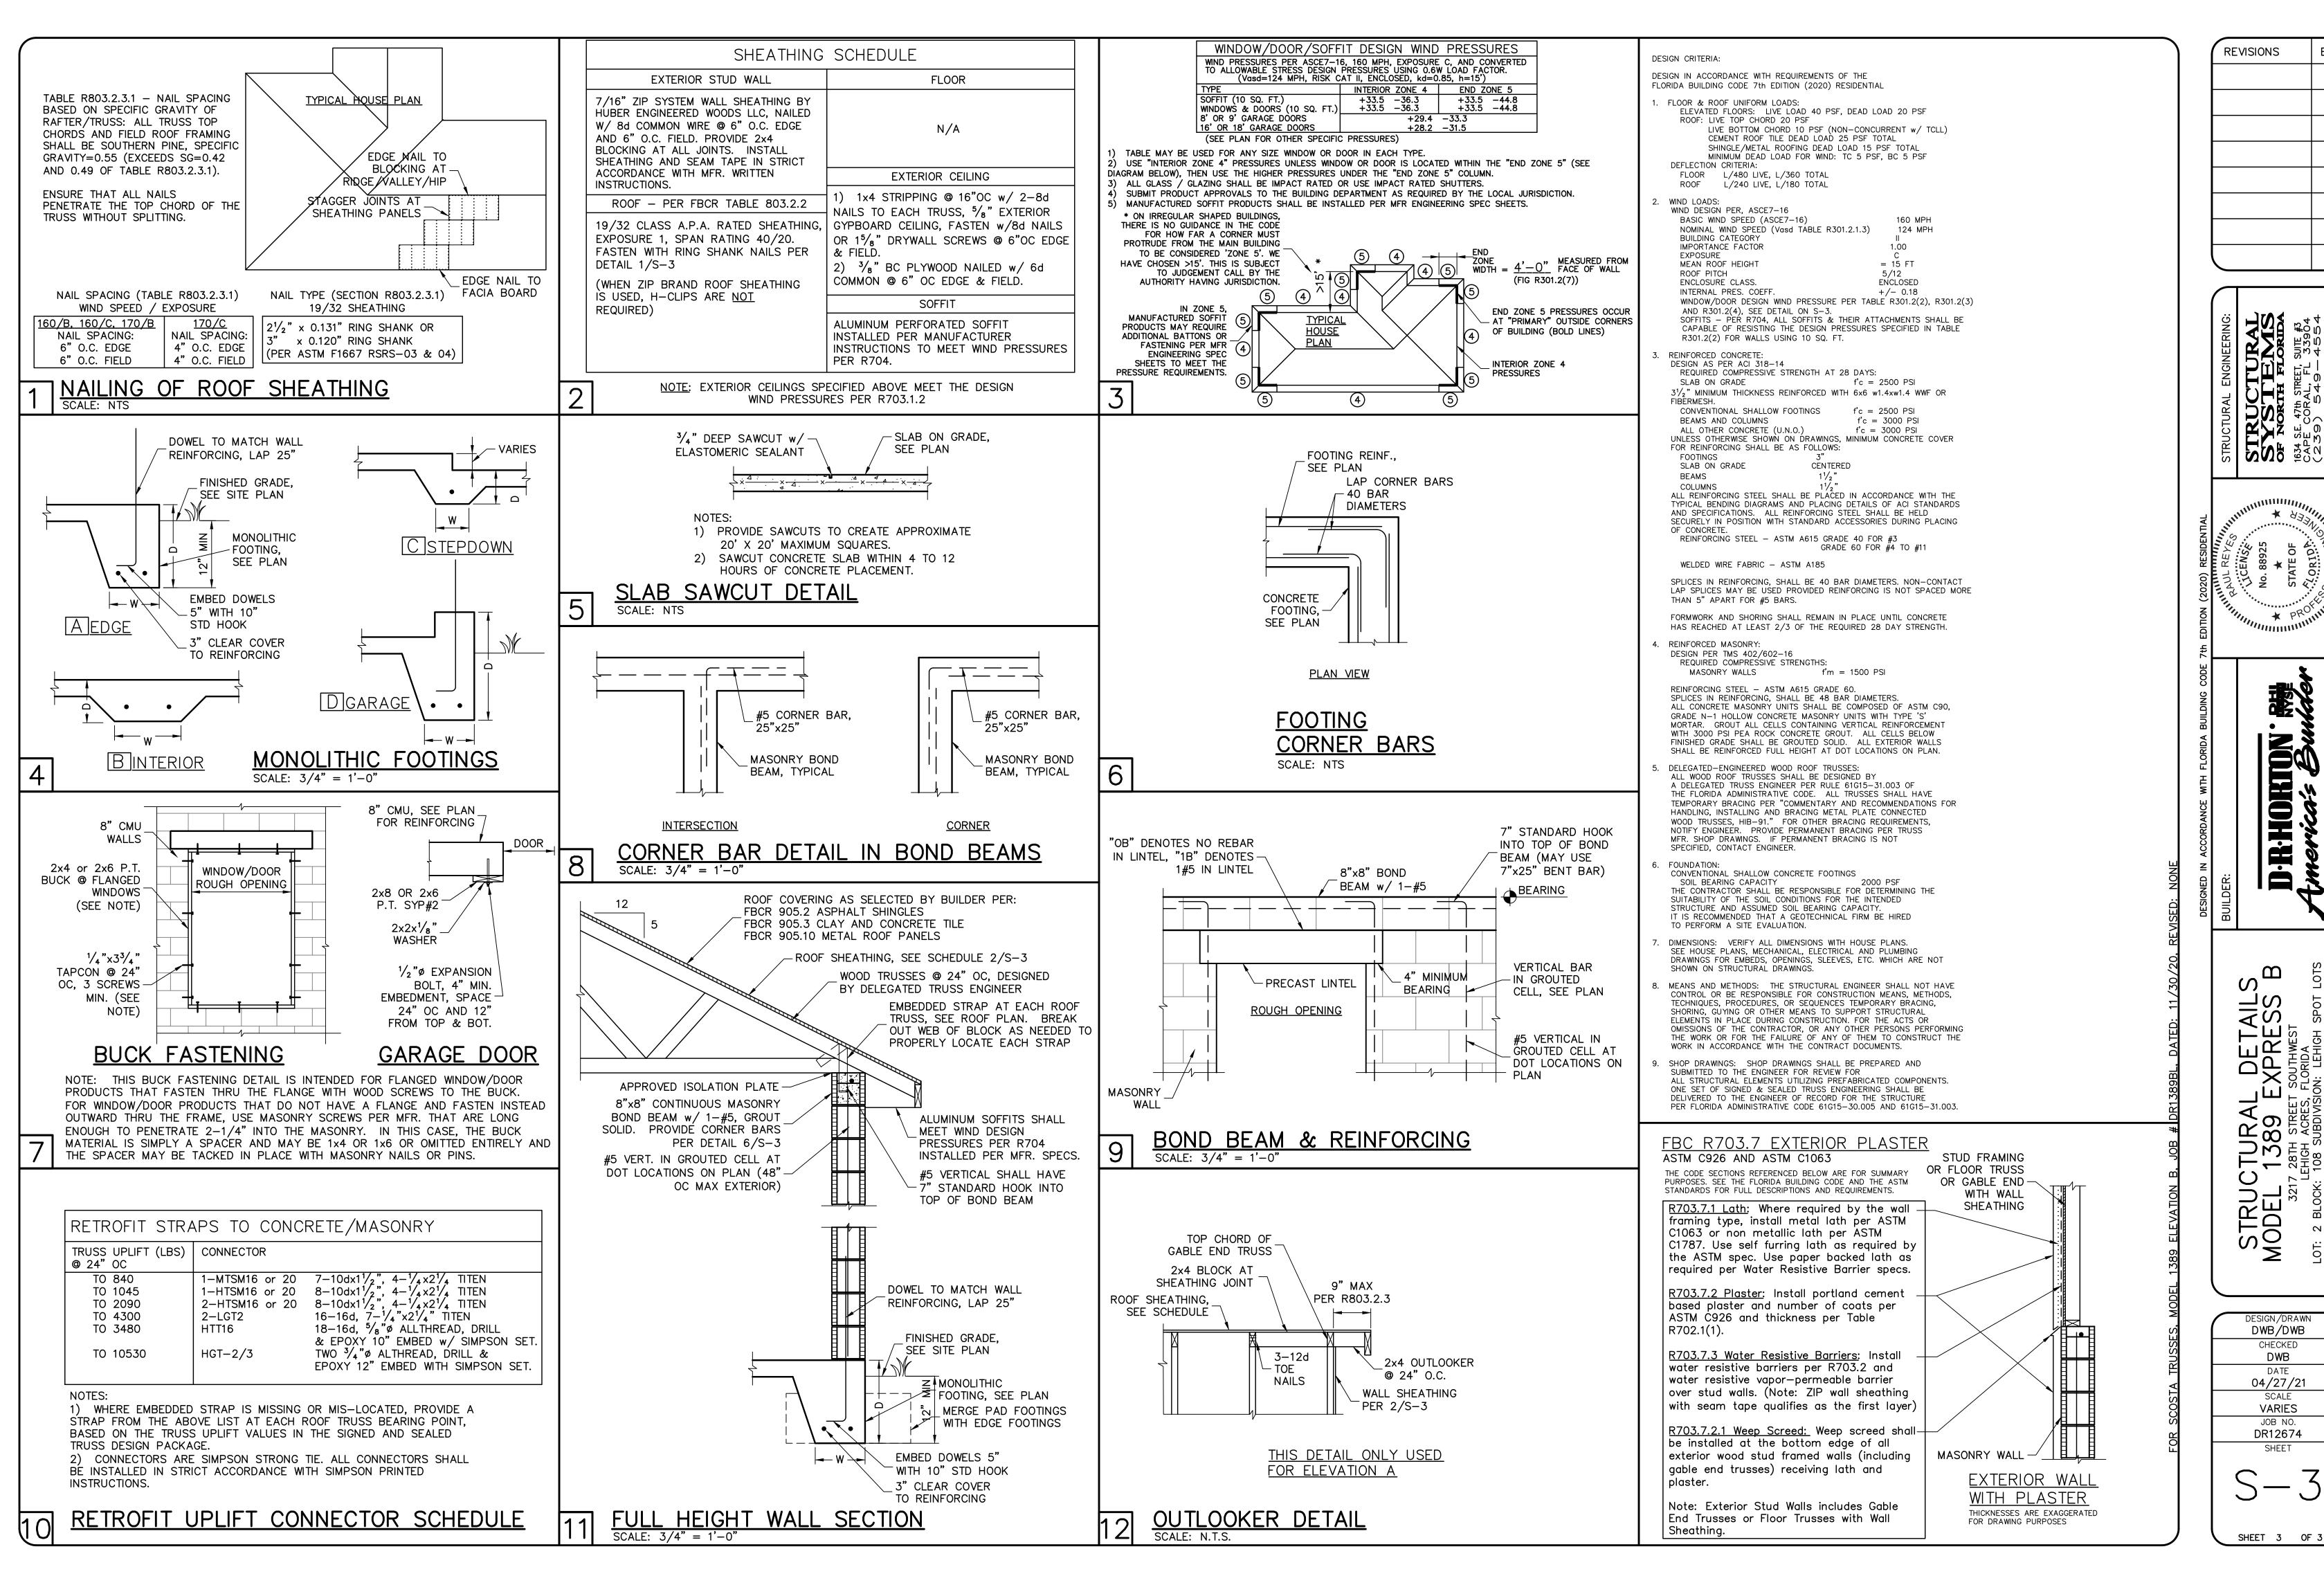

REVISIONS

OKTON

D-R-H

AL JURAL 389 E **├ ~** %필6 STRU

> DESIGN/DRAWN DWB/DWB CHECKED DWB 04/27/21 SCALE **VARIES** JOB NO. DR12674

S-3

SHEET