


BEAMS BY OTHERS

TOP @ 0'-0"

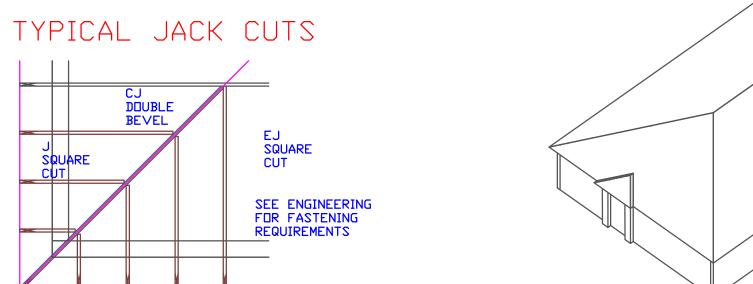

EJ7

FLAT CLG @ 0'-0"

ODD SPACE 1'10-1/2"


BEAM BY OTHERS TOP @ 0'-0"

EJ7

DOUBLE BEVEL

BEAM BY OTHERS

R1 TOP @ 0'-0"

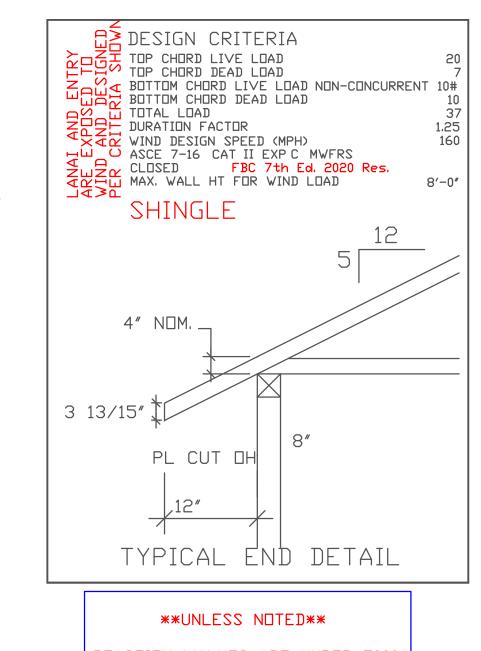

REACTION VALUES ARE UNDER 5000# UPLIFT VALUES ARE UNDER 1000#

ALL TRUSSES 24"o.c. UNLESS NOTED OTHERWISE

*******CAUTIUN**** DO NOT ATTEMPT TO ERECT TRUSSES WITH-

DUT REFERRING TO THE ENGINEERING DWGS. IT IS NECESSARY TO REFER TO THE ENGINEERING

DRAWINGS FOR NUMBER OF MEMBERS, BEARING LOCATION, ORIENTATION AND WEB BRACING

REFER TO WTCA/TPI BSCI-B1 SUMMARY SHEET FOR HANDLING METHODS & TEMPORARY BRACING, WHICH IS ALWAYS REQUIRED BEARING HEIGHTS BASED ON PLANS PROVIDED TO SCOSTA CORP. "+/-" BEARING DIFFERENCES SHOWN ARE CRITICAL. IF ANY HEIGHTS DEVIATE - INFORM SCOSTA

BEARING WALL & BEAM HEIGHTS

| | _ | 0'-0" | ELEV. |
|---|---------------------|-------|-------|
| 7///// | Z | | ELEV |
| | $\overline{\Sigma}$ | | ELEV |
| | # | | ELEV |
| | <u> </u> | | ELEV |
| | X | | ELEV. |
| *************************************** | <u></u> | | ELEV. |

TYPICAL HANGER SCHEDULE

- (C) SIMPSON HUS 26 (M) SIMPSON HGUS 28-3 F SIMPSON HUS 28 N SIMPSON HHUS 48
- (H) SIMPSON HGUS 28 (P) SIMPSON LUS 24
- I SIMPSON HGUS 28-2 B SIMPSON THA 422
- W SIMPSON THJA26 X HANGER VALUES HAVE BEEN BASED ON 16D COMMON NAILS EXCEPT THE FOLLOWING LUS24 - 10D COMMON THJA26 - 10D x 1-1/2

APPROVAL OF THIS TRUSS LAYOUT IS NECESSARY BEFORE FABRICATION CAN BEGIN. VERIFY DIMENSIONS, PITCHES, OVERHANGS, ELEVATIONS, CEILING & BEARING CONDITIONS. SCOSTA CORPORATION IS
RESPONSIBLE FOR ACCURACY IN ACCORDANCE WITH
PLANS AND/OR INFORMATION PROVIDED BY CUSTOMER, WITH ANY DEVIATIONS NOTED HEREIN.
CUSTOMER IS RESPONSIBLE TO VERIFY ACCURACY OF INFORMATION AND PLANS PROVIDED TO SCOSTA CORPORATION, AND TO VERIFY CONFORMANCE TO FIELD CONDITIONS, AND/OR OWNER CHANGES.
TRUSSES WILL BE BUILT IN ACCORDANCE WITH THE APPROVED LAYOUT. APPROVED BY: ____

DATE: _____ REQUESTED DELIVERY DATE:

JOBSITE CONTACT NAME:

PHONE #: _____


E-MAIL: __


(2)PLY A1A






| SCALE: | DATE: | REVISED BY: | DRAWN BY: |
|-------------|-------------------------------|-------------|-----------|
| 1/4"=1'-0" | 11/30/20 | | KJC |
| | 89 B W/ LA RAGE RIGHT E | NAI | 1 of 1 |
| CUSTOMER: | | | JDB # |
| D.R. HORTON | | | DR1389BL |

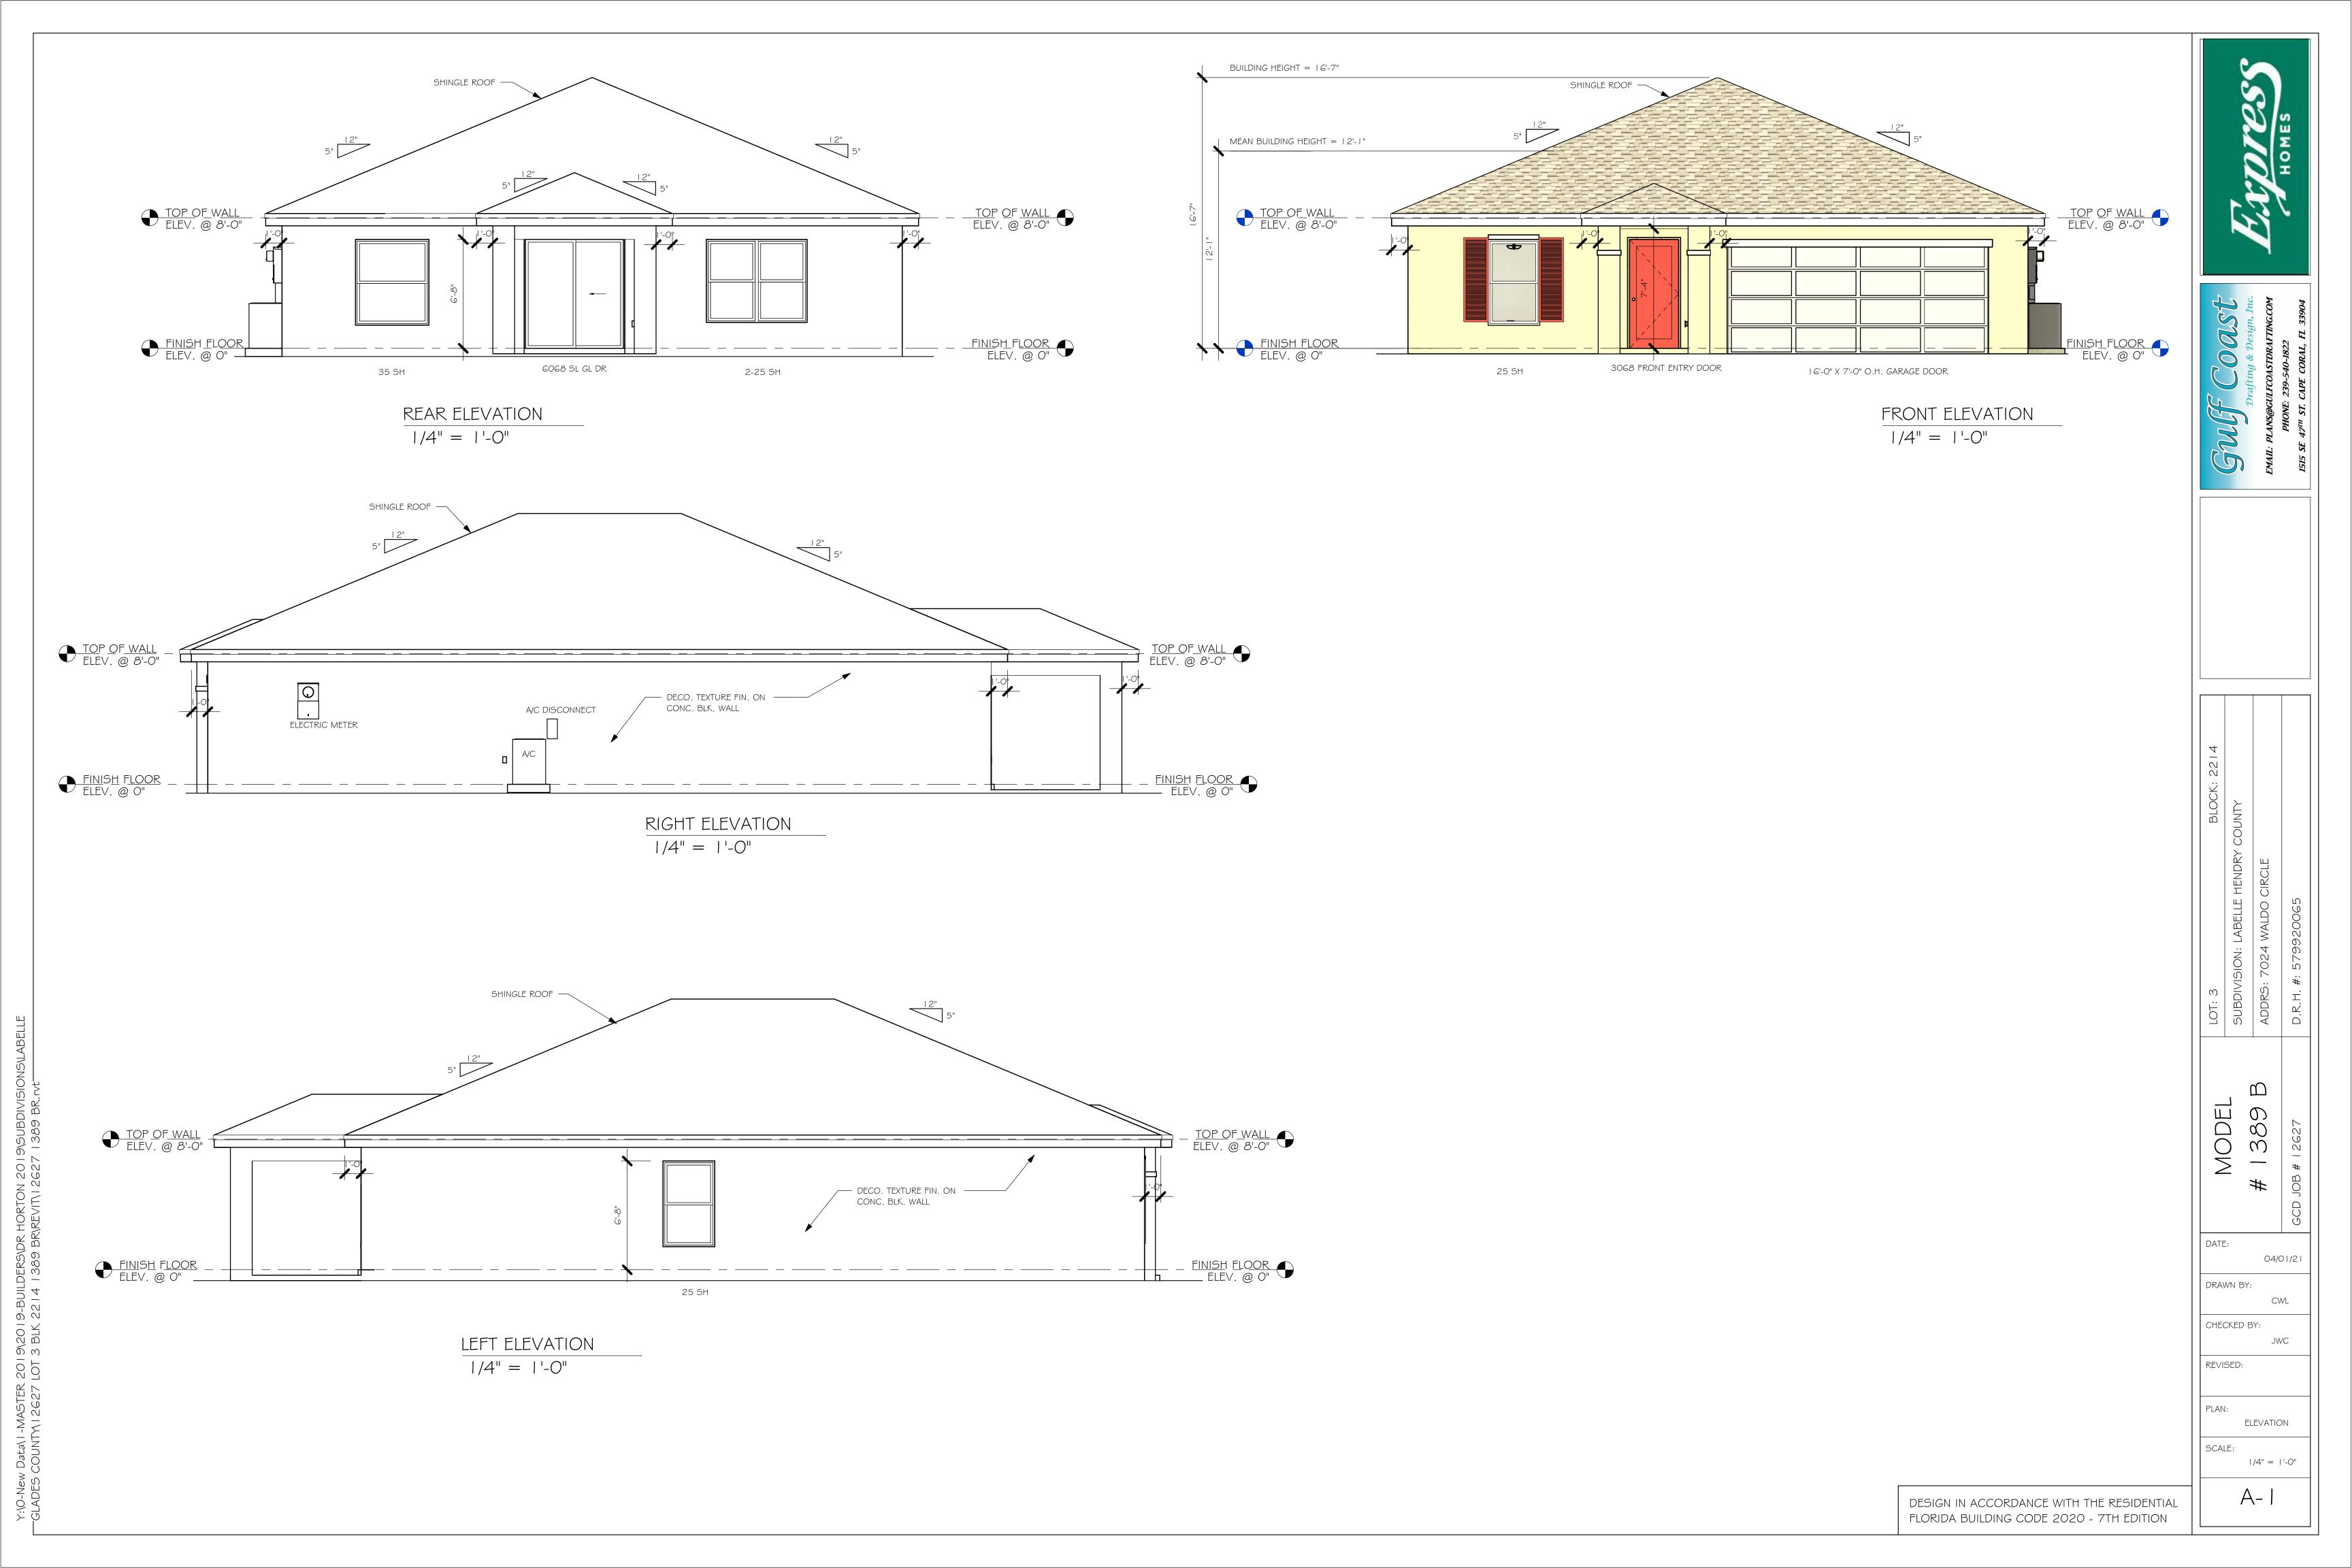

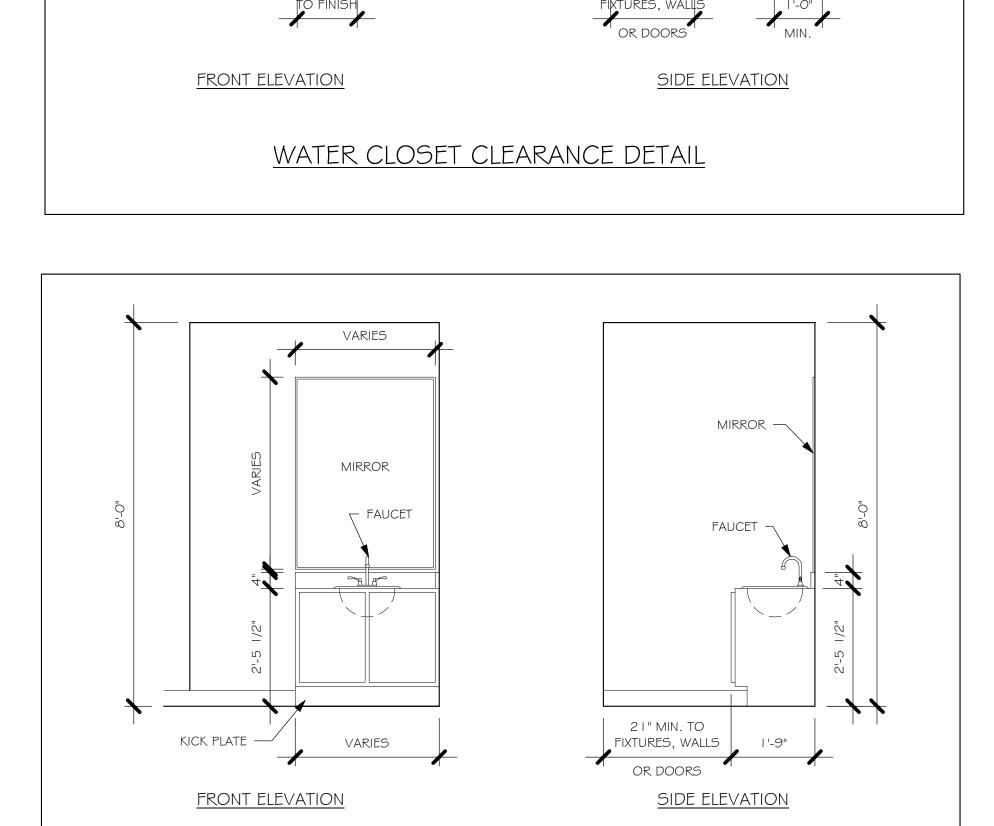

VANITY SINK CLEARANCE DETAIL


36" MAX.

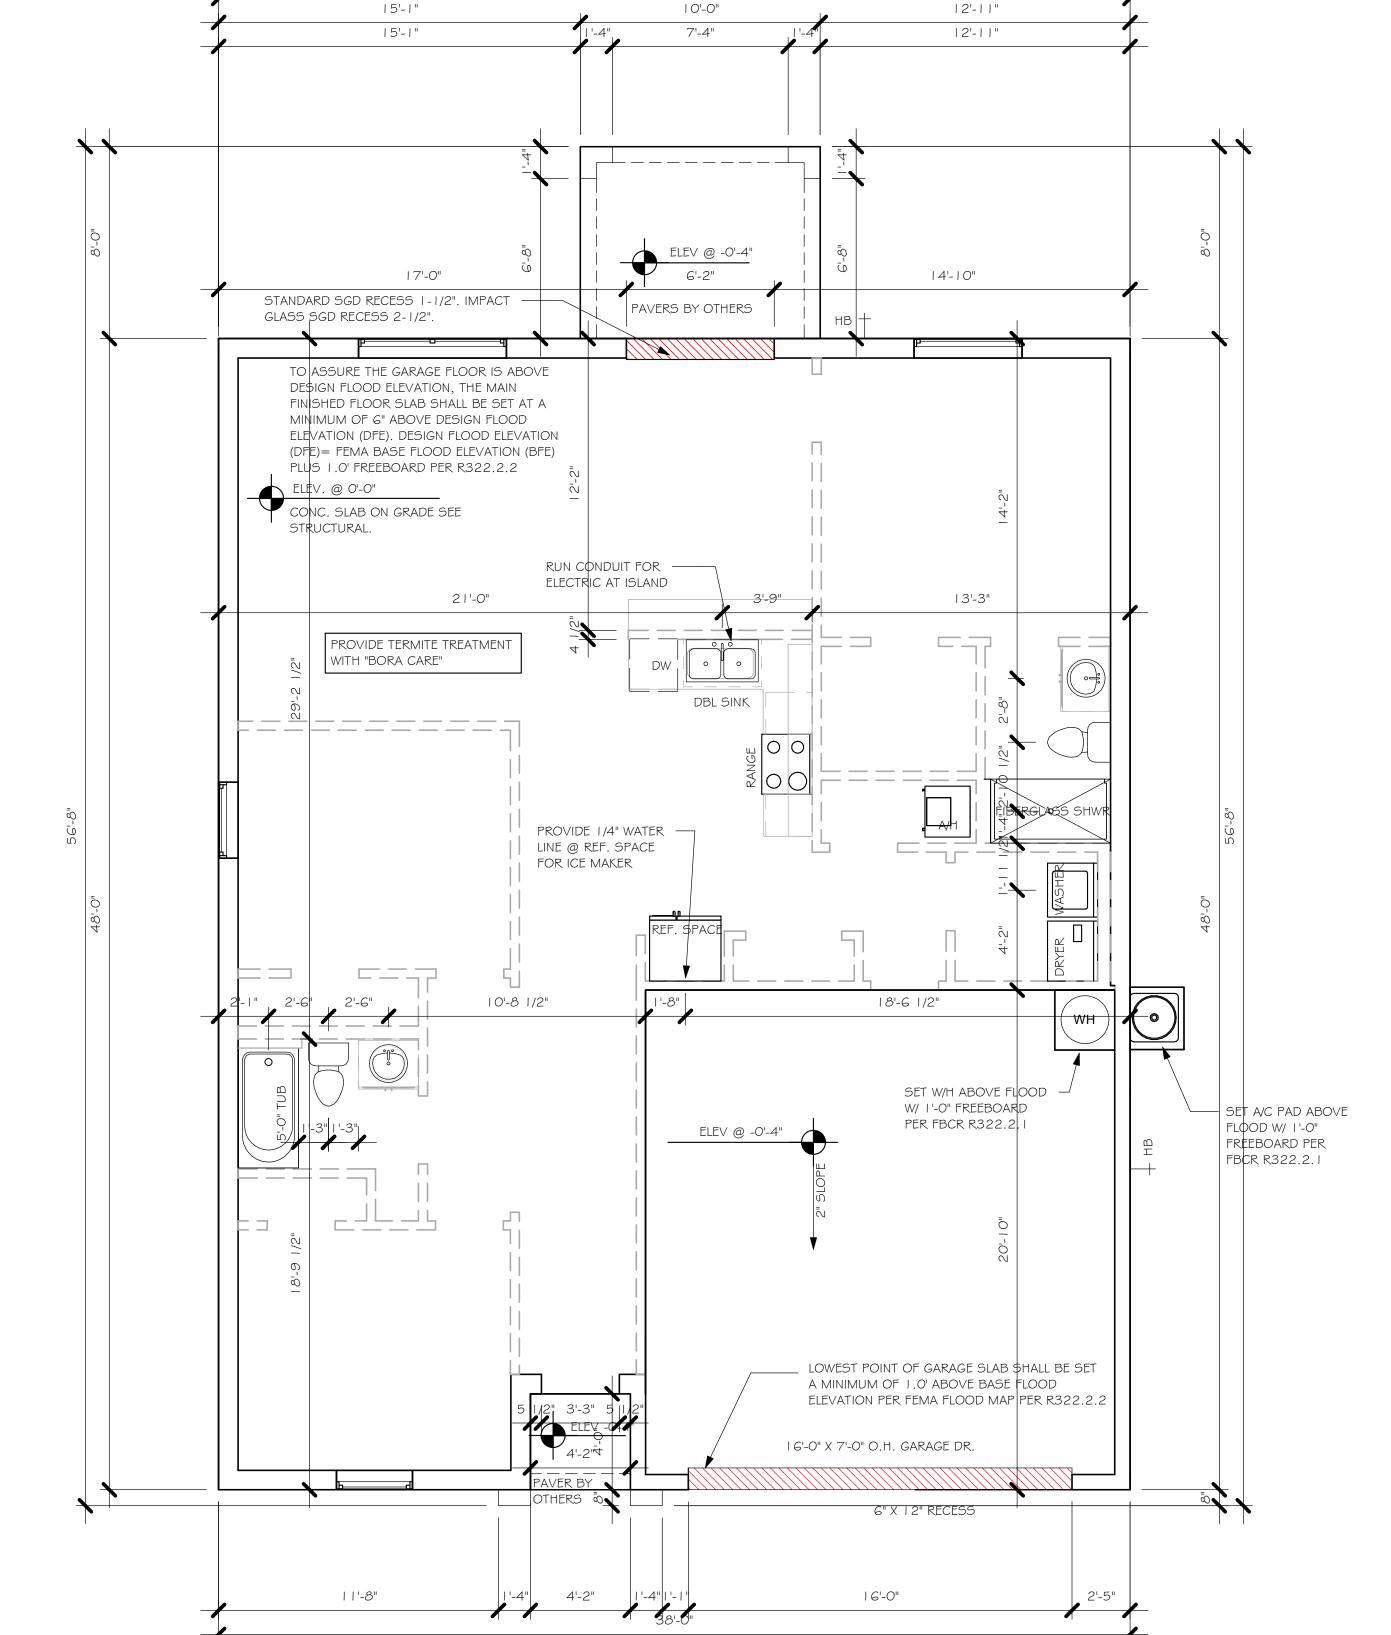

38'-0"

SLAB & PLUMBING 1/4" = 1'-0"

DATE: 04/01/21 DRAWN BY: CWL CHECKED BY: JWC REVISED: SLAB & PLUMBING SCALE: As indicated DESIGN IN ACCORDANCE WITH THE RESIDENTIAL FLORIDA BUILDING CODE 2020 - 7TH EDITION

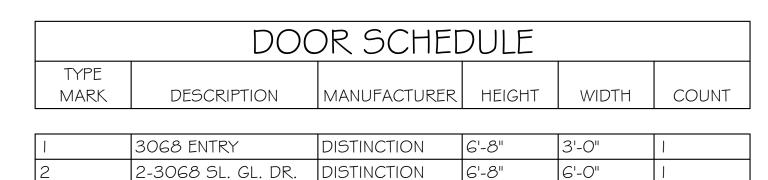

GARAGE DOOR

7'-0"

16'-0"

| | WIN | NDOW SC | HEDU | LE | |
|------|-------------|--------------|--------|-------|-------|
| MARK | DESCRIPTION | MANUFACTURER | HEIGHT | WIDTH | COUNT |

| А | 2-25 SH | 5'-3" | 6'-4" | 1 |
|---|---------|-------|-------|---|
| В | 25 SH | 5'-5" | 3'-4" | 2 |
| С | 35 SH | 5'-5" | 4'-8" | 1 |

| DOOR HEADERS | | | | | |
|---------------|---------------|----------------|--|--|--|
| 6'-8" BI-FOLD | HEADER HEIGHT | 82" A.F.F. | | | |
| 6'-8" SWING | HEADER HEIGHT | 82 I/2" A.F.F. | | | |
| 8'-0" SWING | HEADER HEIGHT | 98 1/2" A.F.F. | | | |

PLAN NOTES

VERIFY ALL ROUGH OPENING DIMENSIONS FOR ALL WINDOWS AND DOORS

16070 OHGD

- PROVIDE SAFETY GLAZING WITHIN 24" FROM EXIT PER FLORIDA BUILDING CODE R 308.4.2.
- PROVIDE SAFETY GLAZING AT BATH/ SHOWER PER FLORIDA BUILDING CODE R 308.4.5.
- NON BEARING INTERIOR FRAME WALLS SHALL BE FRAMED W/ WOOD OR METAL STUDS. SPACING SHALL NOT EXCEED 24" O.C. (NON BEARING WALLS ONLY)
- PROVIDE DEAD WOOD IN ATTIC FOR OVERHEAD GARAGE DOOR HARDWARE
- KITCHEN KNEE WALL TO BE FRAMED W/ TOP @
- 34 I/2" A.F.F.
- INSTALL SMOOTH WALLS IN KITCHEN AND ALL BATHROOM AREAS
- WHERE DRYWALL CEILING IS APPLIED TO TRUSSES @ 24" O.C. USE 5/8" DRYWALL OR 1/2" SAG RESISTANT PER SEC. R702.3.5
- THE GARAGE SHALL BE SEPARATED FROM THE RESIDENCE & ATTIC BY NOT LESS THEN 1/2" GYPSUM BOARD APPLIED TO THE GARAGE SIDE. GARAGES BENEATH HABITABLE ROOMS SHALL BE SEPARATED WITH NOT LESS THAN 5/8" TYPE "X" GYPSUM BOARD OR EQUIVALENT. WHERE THE SEPARATIION IS A FLOOR - CEILING ASSEMBLY, THE STRUCTURE SUPPORTING THE SEPARTION SHALL ALSO BE PROTECTED BY NOT LESS THAN 1/2" GYPSOM BOARD OR EQUIVALENT
- 10) INSTALL 1 3/8" THICK SOLID WOOD DOOR BETWEEN LIVING AND GARAGE PER FLORIDA BUILDING CODE R302.5.1,
- II) ALL WINDOWS INSTALLED 72" ABOVE GRADE MUST COMPLY WITH R3 | 2.2 MIN 24" SILL HEIGHT OR PROVIDED WITH AN APPROVED WINDOW FALL PREVENTION DEVICE
- 12) ALL CLOSET SHELVES TO BE 12". ALL PANTRY \$ LINEN TO BE (4)-16" SHELVES 18" O.F.F. W/ 15" INCREMENT.
- 13) ALL MECHANICAL AND ELECTRICAL EQIUPMENT TO BE INSTALLED AT OR ABOVE FLOOD PLUS 1'-0" FREEBOARD.

| IN. | TERIOR DO | OR SCHEDULE |
|------|------------|----------------------|
| MARK | DOOR WIDTH | NOTES |
| | 3'-0" | P.K. = POCKET DOOR |
| 2 | 2'-8" | BF = BI-FOLD DOOR |
| 3 | 2'-6" | D.1 DI-1 OLD DOOK |
| 4 | 2'-4" | B.P. = BI-PASS DOOR |
| 5 | 2'-0" | L.V. = LOUVERED DOOR |
| 6 | 1'-8" | |
| 7 | 1'-6" | |
| 8 | 2'-11" | |


| SQUARE FOOTAGE | | | | | |
|-------------------------|-------|--|--|--|--|
| LIVING AREA | 1,389 | | | | |
| GARAGE AREA | 419 | | | | |
| LANAI AREA | 80 | | | | |
| FRONT PORCH/ ENTRY AREA | 16 | | | | |
| TOTAL SQUARE FOOTAGE | 1,904 | | | | |


| CABINET BACKING | | | | | | |
|-----------------|-----------------|----------------|--|--|--|--|
| KITCHEN | UPPER TOP @ 84" | BASE TOP @ 35" | | | | |
| MASTER BATH | UPPER | BASE TOP @ 35" | | | | |
| GUEST BATH | UPPER | BASE TOP @ 31" | | | | |
| LAUNDRY ROOM | UPPER TOP @ 84" | BASE | | | | |

TYPICAL DIMENSION STRING

FACE OF OUTSIDE WALL TO FACE OF STUD WALL FACE OF STUD TO FACE OF STUD

| | | TOWLL DAK | ALL TOD DLCKS @ 21 A.T.I |
|-----|-------|-------------|--|
| | TP TO | OILET PAPER | ALL BLOCKING TO BE PT IN SHOWERS |
| /2" | | 1.O.14 | TOWEL BAR 2'-6" TOILET PAPER ROLL A A A A A A A A A A A A A A A A A A |

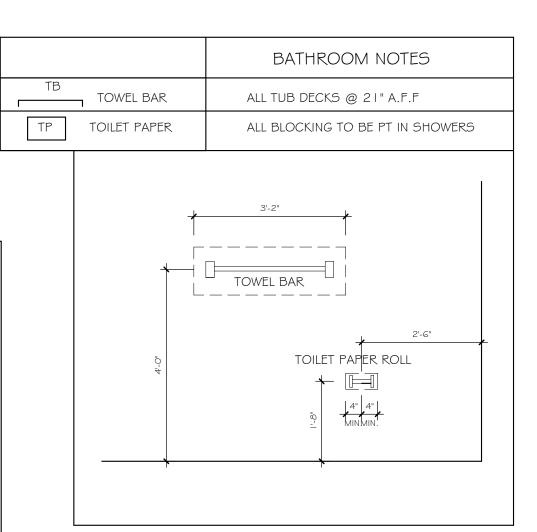

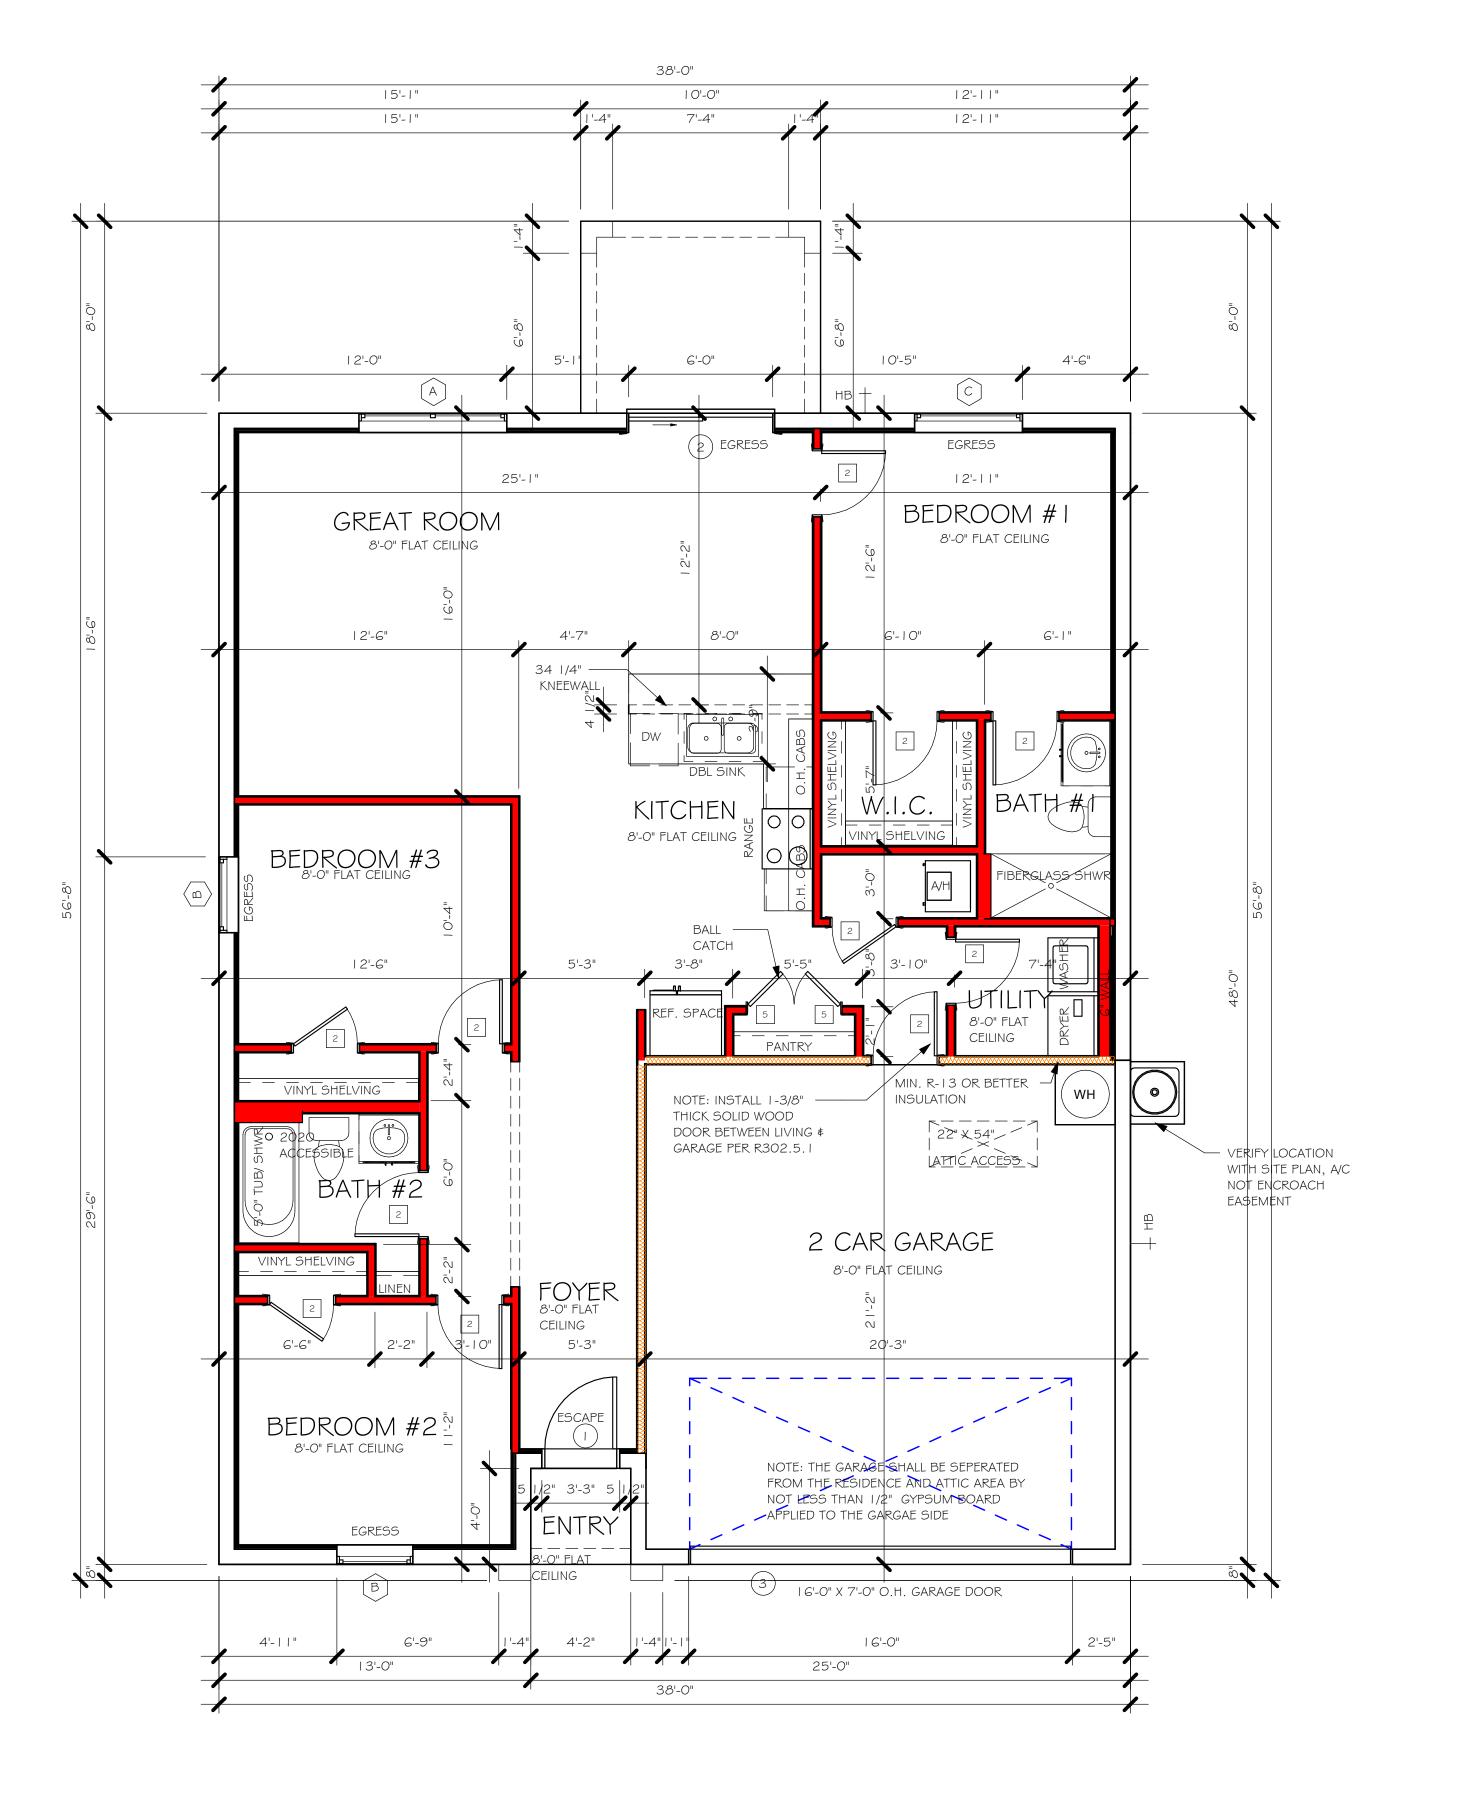

FLOOR PLAN $\frac{1}{4} = 1'-0''$

> DESIGN IN ACCORDANCE WITH THE RESIDENTIAL FLORIDA BUILDING CODE 2020 - 7TH EDITION

FACE OF EXTERIOR WALL —

DATE:

DRAWN BY:

CHECKED BY:

REVISED:

SCALE:

04/01/21

CWL

JWC

FLOOR

As indicated

MODEL

DATE: 04/01/21 DRAWN BY: CWL CHECKED BY: JWC REVISED:

PLAN: ROOF SCALE: As indicated

A-4

FLORIDA BUILDING CODE 2020 - 7TH EDITION

| | | | | | | | | , |
|--|----------------|-------------------------|-----------------|--|----------------------|----------------------------|---------------------------|------------------------|
| MC | DEL | 1389 | 9 B: A | ATTIC | VENTIL | ATION | 1 FB | CR R806 |
| | | COORDINA | TE VENTING RI | EQUIREMENTS | WITH ENERGY CALC | CULATIONS | | |
| SOFFIT ONLY (1/150) (NO ROOF VENTS) | | | | | , , | WI | TH ROOF VE (R.V.) | NTS (1/300) |
| AREAS (SQ. FT.) | | ATT | TIC VENTILATION | ON REQUIRED | ATTIC | ATTIC VENTILATION REQUIRED | | |
| MARK | ATTIC | SOFFIT | ATTIC AREA/150 | REQ'D AIR FLOW OF SOFFIT | QUAD 4 SOFFIT HAS | ATTIC AREA/300 | QUANTITY OF ROOF VENTS | MIN AIR FLOW OF SOFFIT |
| 1st STORY | 2000.0 SQ. FT. | 176.0 SQ. FT. | 13.33 SQ. FT. | 7.57% | 8.15% | SQ. FT. | - | % |
| | | "SOFFIT ONLY" QUALIFIES | | ROOF VENTS ARE NOT REQUIRED | | | | |
| | | | NA | SOFFIT MODEL ACM QUAD 4, FULL VENT, NARROW PATTERN, 8.15% FREE AIR FLOW | | 22-3/8" BASE | LOMANCO 7 | SE |

| WALL HEIGHT |
|----------------|
| = WALL @ 8'-0" |

BEDROOM GREAT ROOM 8'-0" FLAT CEILING BEDROOM #3 8'-0" FLAT CEILING 8'-0" FL T CEILING 2 CAR GARAGE 8'-0" FLAT CEILING FOYER

8'-0" FLAT

CEILING BEDROOM

> ROOF PLAN 1/4" = 1'-0"

| | ELECTRICAL METER |
|------------------|--|
| | ELECTRICAL PANEL |
| | I 20 V JUNCTION BOX |
| \bigcirc | SINGLE RECEPTACLE OUTLET |
| | 220 V RECEPTACLE OUTLET |
| | 4-PLEX RECEPTACLE OUTLET |
| | DUPLEX RECEPTACLE OUTLET |
| | 1/2 SWITCHED DUPLEX OUTLET |
| AFF | DUPLEX RECEPTACLE AT ELEV. A.F.F. |
| | DUPLEX RECEPTACLE - ABOVE COUNTER |
| ∨ | SINGLE POLE SWITCH |
| (√) 3 | 3 WAY SWITCH |
| () □ | DIMMER SWITCH |
| ₩ ^S | MOTION SENSOR SWITCH |
| SCD SCD | AC/DC SMOKE DETECTOR TO BE INTERCONNECTED ANY RESIDENT HAVING A FOSSIL-BURNING HEATER OR APPLIANCE, A FIREPLACE, OR AN ATTACHED GARAGE SHALL HAVE AN OPERATIONAL CARBON MONOXIDE ALARM INSTALLED WITHIN 10 FEET OF EACH ROOM USED FOR SLEEPING PERPOSES. PER RULE 9B-3.04.72 SD (SMOKE DETECTOR) SCD (CARBON MONOXIDE/ SMOKE DETECTOR) |
| -[T] | TELEPHONE OUTLET |
| -TV | TELEVISION RECEPTION OUTLET |
| - | SURFACE MOUNTED CEILING LIGHT |
| | FLUSH MOUNTED LIGHT |
| Ю | WALL MTD. BRACKET LIGHT |
| 44 | DUPLEX FLOOD LIGHT |
| | EXHAUST FAN |
| $\nabla \nabla$ | TRACK MTD. LIGHTS |
| | A/C DISCONNECT |
| Н | PUSH BUTTON (PB) / DOOR BELL (DB) |
| (IC) | INTERCOM |
| | KEYPAD |
| | 4' FLUORESCENT LIGHT |
| <u></u> | 2' UNDER COUNTER LIGHT |
| NOTE NO | T ALL SYMBOLS ARE USED FOR THIS |

ALL OUTLETS IN WET AREAS AND ALL

INSTALL PHONE AND T.V PER CONTRACT.


INSTALL ALL ELECTRICAL PER NEC 2014


EXTERIOR OUTLETS TO BE GFI'S.

ELECTRICAL LEGEND

FLECTRICAL PLAN 1389

| ELECTRICAL PLAN 1309 | | | | | |
|----------------------|-------------|--------------------|--|--|--|
| 200 | AMP SERVICE | | | | |
| TAG | QUANTITY | PRODUCT | | | |
| Α | (X) | (FLUSH MOUNTED LT) | | | |
| В | (X) | (VAPORS) | | | |
| С | (X) | (PENDANT LIGHT | | | |
| D | (10) | (10" MUSHROOMS) | | | |
| E | (2) | (24" 3 LT) | | | |
| F | (X) | (36" 4 LT) | | | |
| G | (X) | (NOT USED) | | | |
| Н | (2) | (COACH LIGHTS) | | | |
| 1 | (X) | (COACH LIGHTS) | | | |
| J | (X) | (J BOX) | | | |
| Κ | (1) | (4' FLUORESCENT) | | | |
| L | (X) | (2' FLUORESCENT) | | | |
| М | (X) | (5LT CHANDELIER) | | | |
| Ν | (X) | (3 LT) | | | |
| 0 | (X) | (PENDANT/ NOOK) | | | |
| Р | (X) | (X) | | | |
| Q | (X) | (X) | | | |

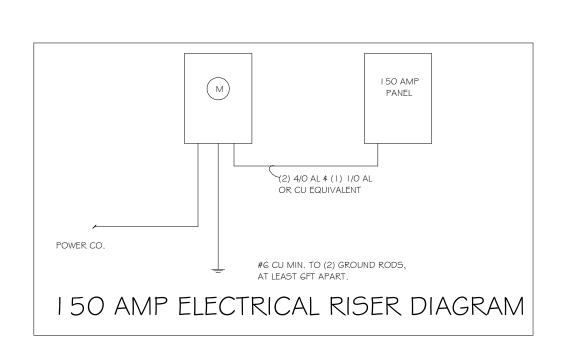

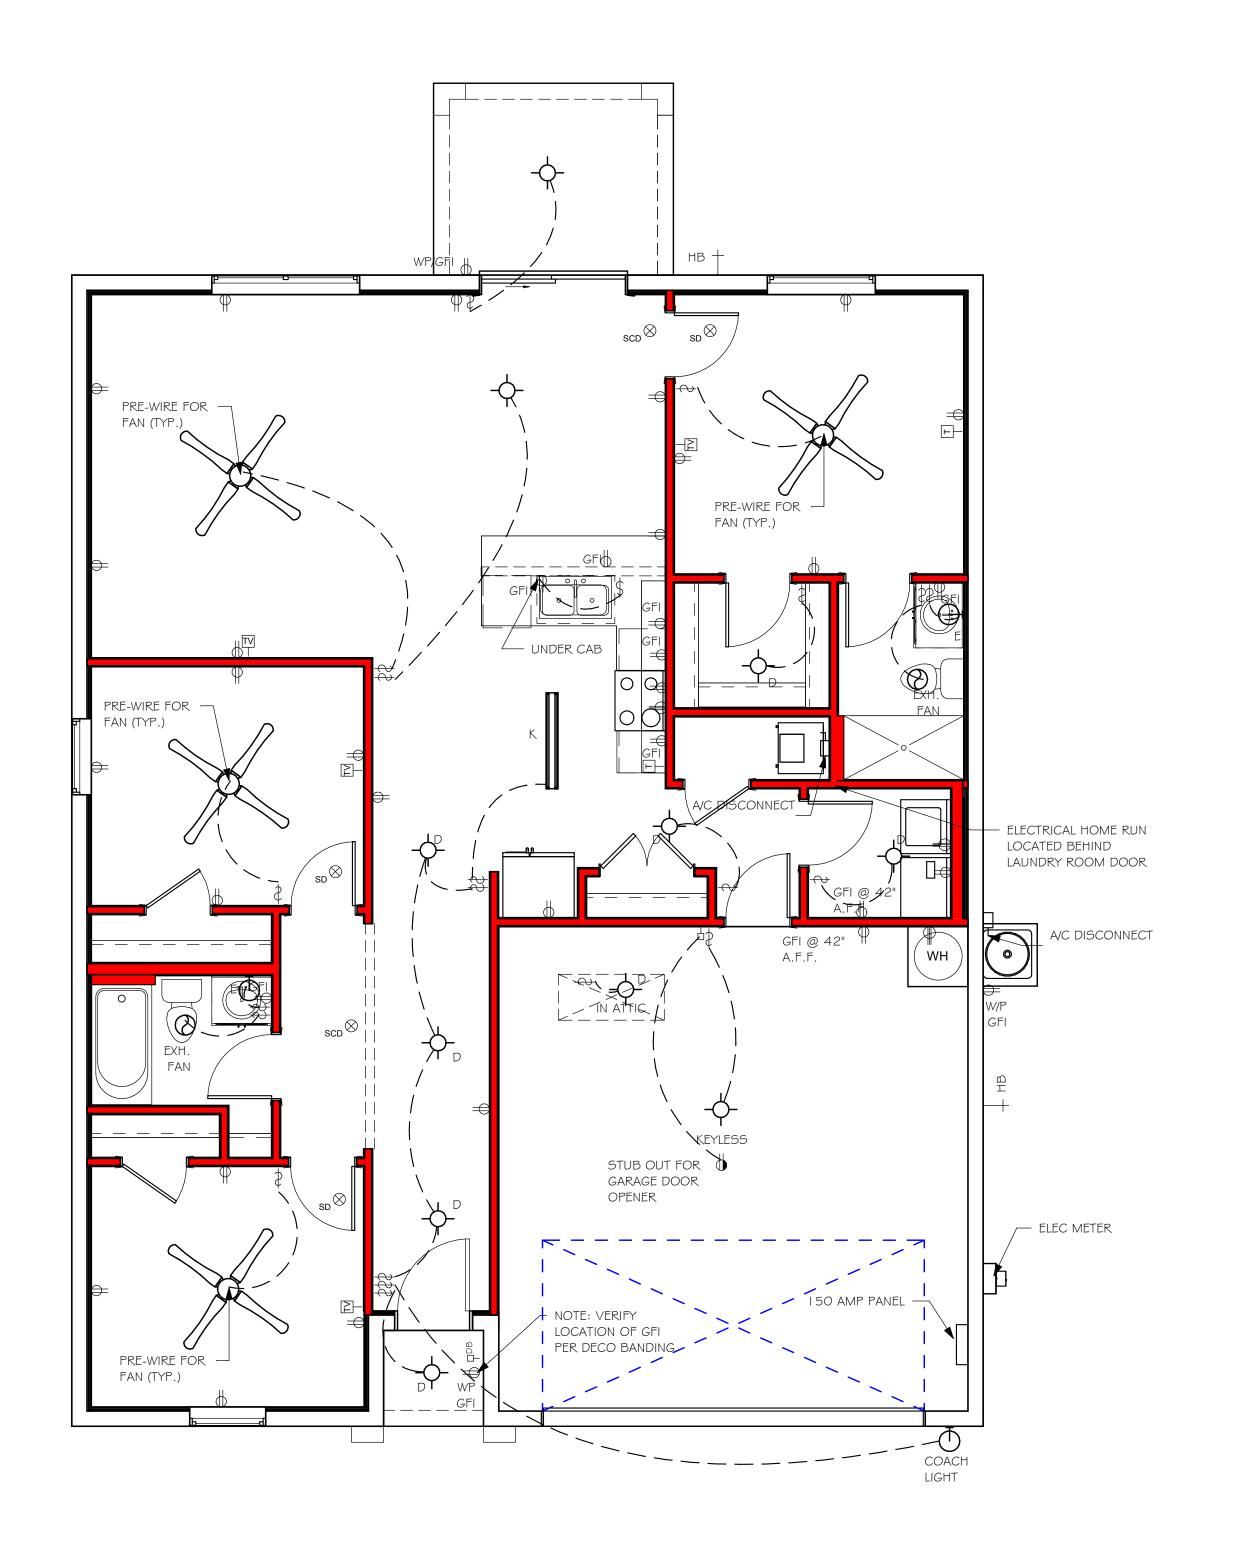

DESIGN IN ACCORDANCE WITH THE RESIDENTIAL FLORIDA BUILDING CODE 2020 - 7TH EDITION

DATE:

DRAWN BY:

CHECKED BY:

REVISED:

PLAN:

SCALE:


04/01/21

CWL

JWC


ELECTRIC

As indicated

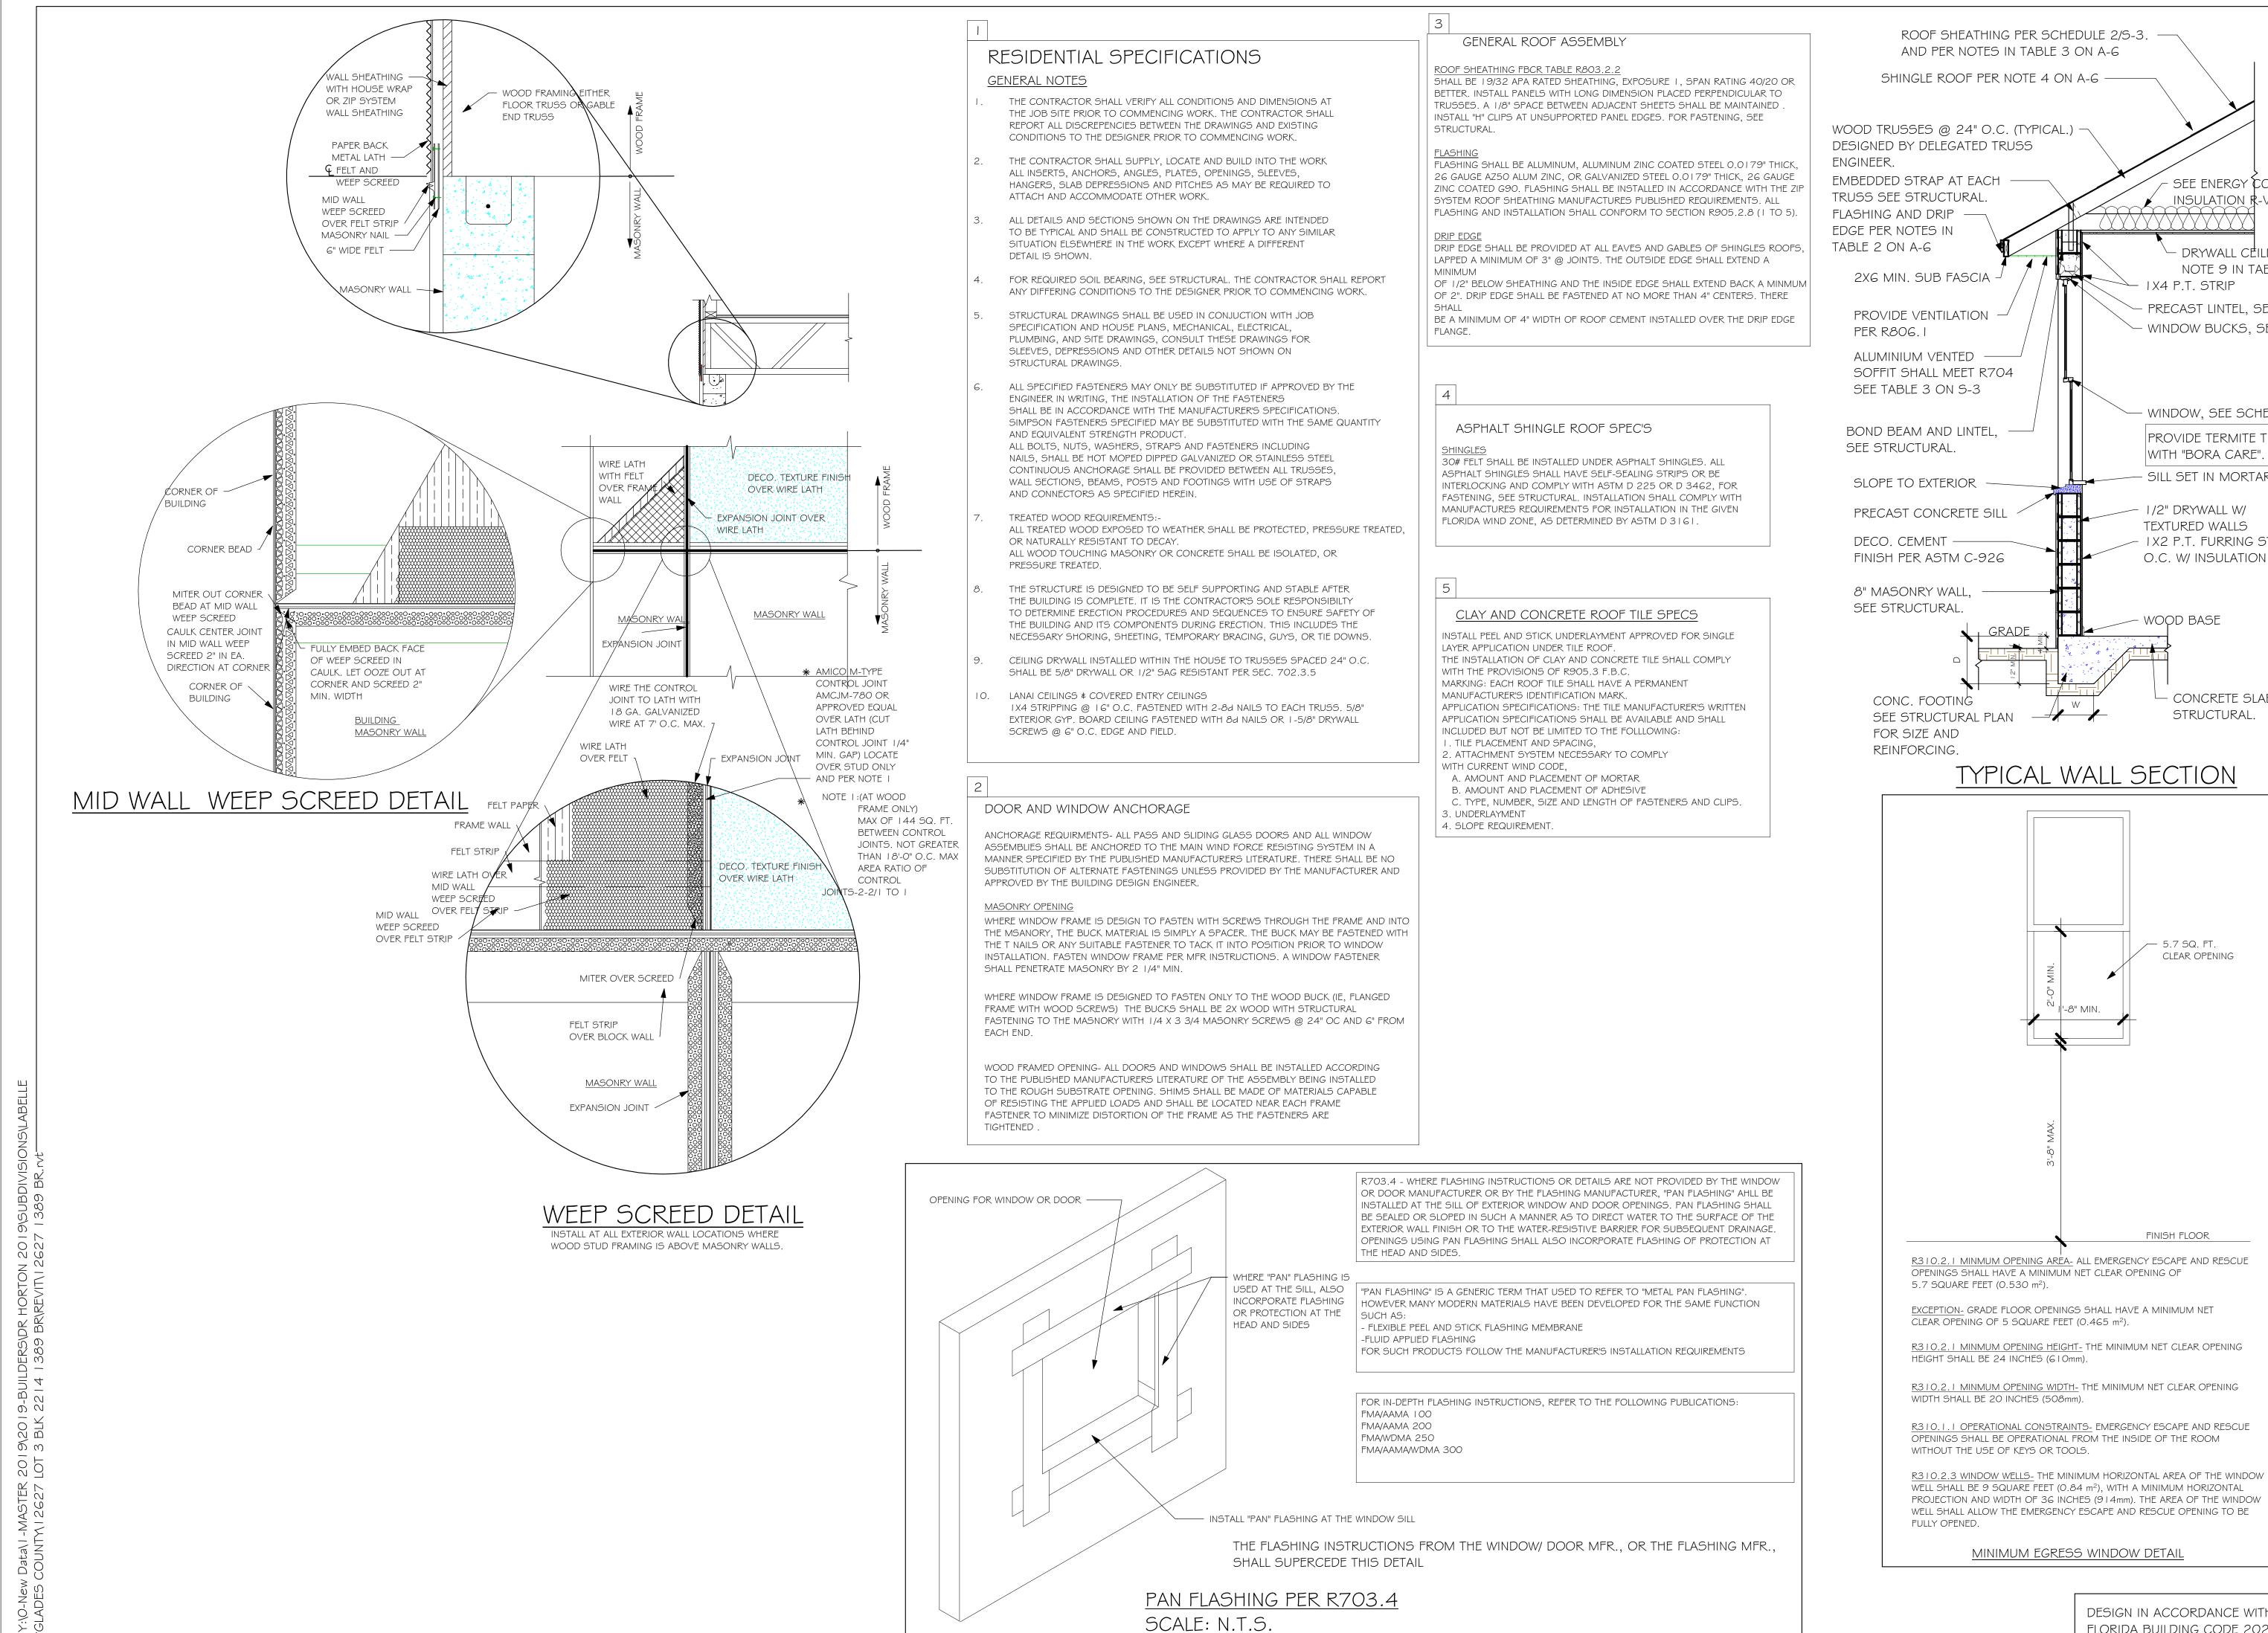

SEE ENERGY CODE FORMS FOR INSULATION R-VALUES - DRYWALL CÉILING PER NOTE 9 IN TABLE I ON A-G ► IX4 P.T. STRIP PRECAST LINTEL, SEE STRUCTURAL. WINDOW BUCKS, SEE STRUCTURAL. WINDOW, SEE SCHEDULE AND PLAN PROVIDE TERMITE TREATMENT WITH "BORA CARE". - SILL SET IN MORTAR 1/2" DRYWALL W/ TEXTURED WALLS IX2 P.T. FURRING STRIPS @ 24" O.C. W/ INSULATION (MIN. R4.1) OOD BASE CONCRETE SLAB ON GRADE, SEE

TYPICAL WALL SECTION

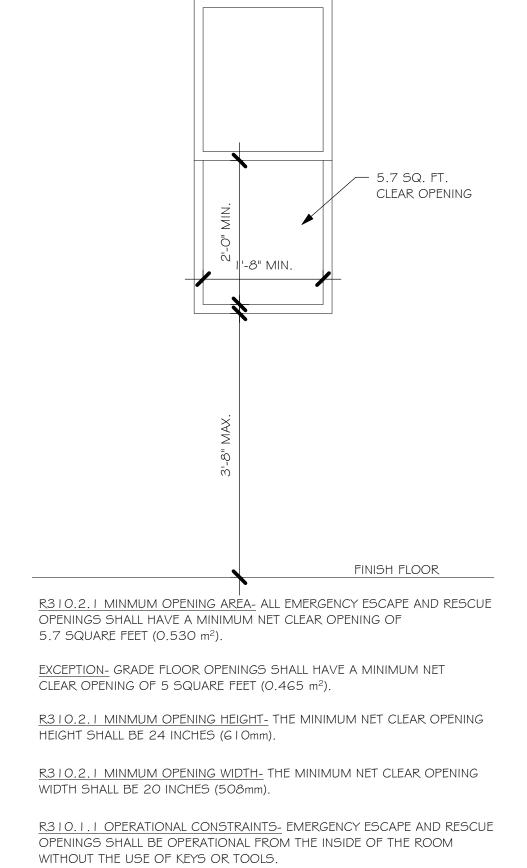

REVISED:

DESIGN IN ACCORDANCE WITH THE RESIDENTIAL FLORIDA BUILDING CODE 2020 - 7TH EDITION

04/01/21 DRAWN BY: CWL


CHECKED BY: JWC

SECTIONS As indicated


A-6


"F3" FOOTING

1/2" = 1'-0"

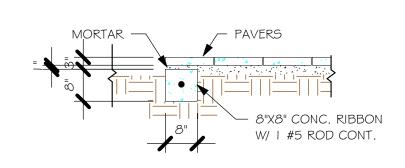


"P" PAVERS DETAIL ENTRY/ LANAI 1/2" = 1'-0"

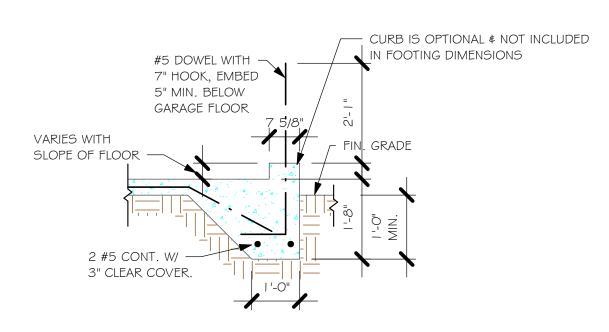

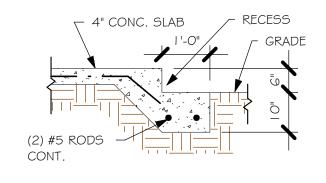

"F3" WITH CURB AT GARAGE 1/2" = 1'-0"

GARAGE DOOR RECESS 1/2" = 1'-0"

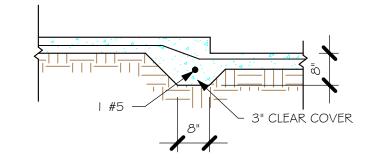

 $\frac{\text{"F6A" STEP DOWN}}{1/2\text{"} = 1\text{'-0"}}$

| | | PAD FOOTING SCHEDULE | | | | | | |
|-----|------------------------------|----------------------|-------|-------|----------|-----------|---------|--|
| Ω | | | | | | | | |
| USE | TYPE | LENGTH | WIDTH | DEPTH | LONG WAY | SHORT WAY | REMARKS | |
| X | $\langle \mathbf{A} \rangle$ | 2'-6" | 2'-6" | 1'-0" | 3-#5 | 3-#5 | - | |
| | \bigcirc | 3'-0" | 3'-0" | 1'-0" | 4-#5 | 4-#5 | - | |
| | (<u>c</u>) | 3'-6" | 3'-6" | 1'-0" | 4-#5 | 4-#5 | - | |
| | $\langle \mathbf{D} \rangle$ | 4'-0" | 4'-0" | 1'-2" | 5-#5 | 5-#5 | - | |
| | (E) | 5'-0" | 5'-0" | 1'-2" | 6-#5 | 6-#5 | - | |


| | WALL FOOTING SCHEDULE | | | | | | |
|------|-----------------------|--------|-------|--------|-----------------------|----------|--------------------------------------|
| USED | TYPE | LENGTH | WIDTH | DEPTH | BOTTOM REINFORCING | SHAPE | |
| | F1 | CONT. | 1'-4" | 0'-8" | 2-#5 | | |
| | F2 | CONT. | 1'-8" | 0'-10" | 2-#5 | | |
| X | F3 | CONT. | 1'-0" | 1'-8" | 2-#5 | ₩ | ADD CURB TO GARAGE, SEI DETAIL |
| | F4 | CONT. | 1'-4" | 1'-8" | 2-#5 | | DETAL |
| | F5 | CONT. | 1'-4" | 1'-0" | 2-#5 | - | |
| | F6 | CONT. | 1'-4" | 1'-0" | 2-#5 | | |
| X | F6A | CONT. | 0'-8" | 0'-8" | 1-#5 | | |

TE CONT. 0'-8" 0'-8" PROVIDE CORNER BARS PER 6/S-3



SCALE: 1/4" = 1'-0"

- **PLAN NOTES:** TOP OF GROUND FLOOR SLAB DATUM ELEVATION 0'-0"
- "F#" DENOTES CONTINUOUS WALL FOOTING TYPE PER SCHEDULE THIS SHEET.
- ALL DIMENSIONS ARE TO OUTSIDE FACE OF MASONRY WALLS. SOME SLAB EDGES MAY
- EXTEND BEYOND FACE OF WALL. FOR DIMENSIONS OF ROUGH OPENINGS IN MASONRY WALLS, COORDINATE WITH WINDOW/
- PROVIDE PRESSURE TREATED BUCKS AT WINDOWS/ DOORS PER DETAIL 7/S-3.

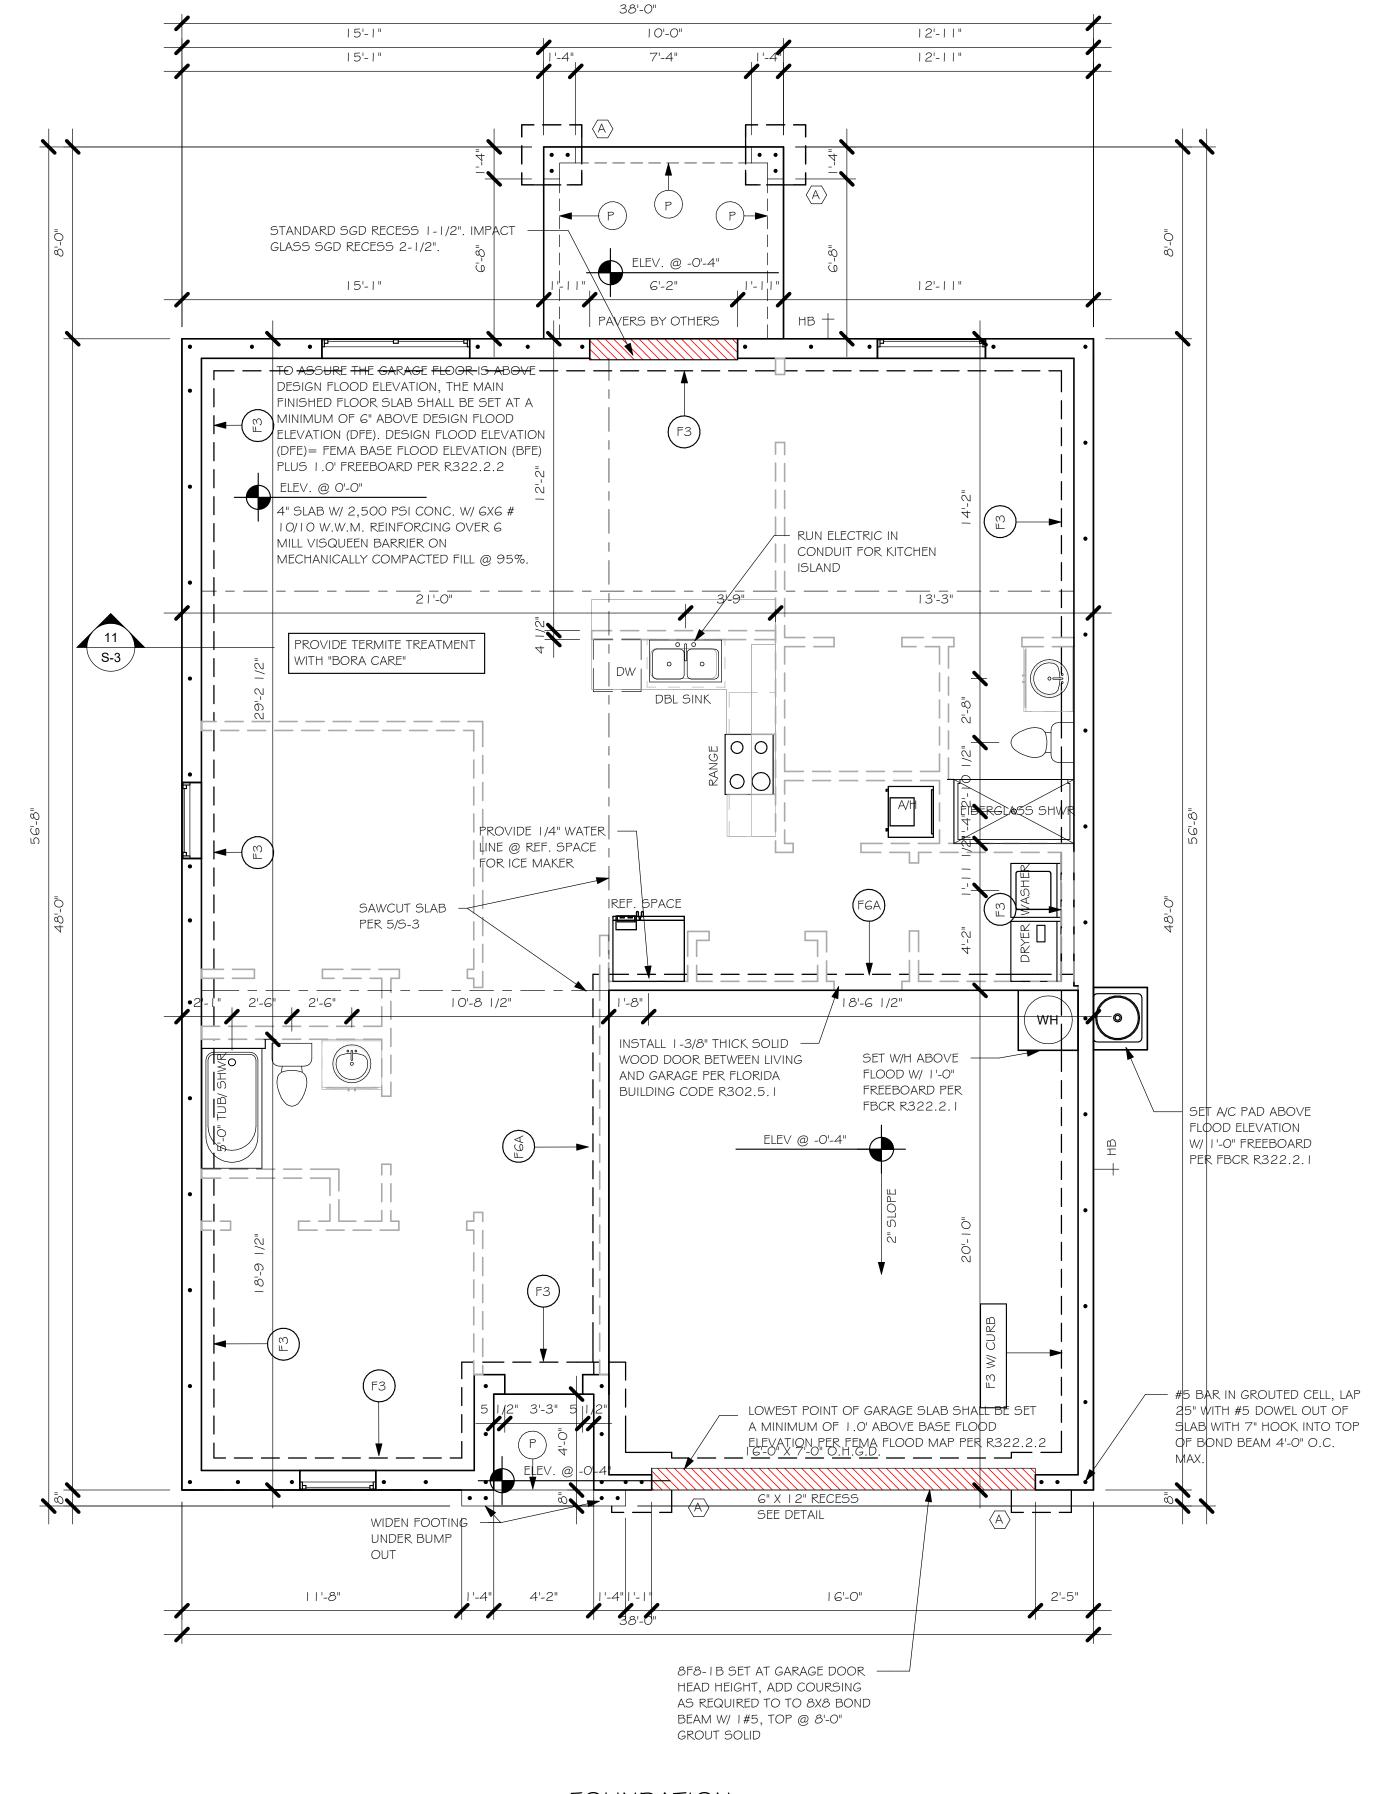

DESIGN IN ACCORDANCE WITH THE RESIDENTIAL FLORIDA BUILDING CODE 2020 - 7TH EDITION

FOUNDATION PLAN


As indicated

DATE: 04/01/21 DRAWN BY: FOUNDATION 1/4" = 1'-0" CHECKED BY: REVISED: PROVIDE #5 VERTICAL REINFORCING AT DOT LOCATIONS SHOWN ON PLAN FROM FOOTING

I. PROVIDE A STRAP FROM THE ABOVE LIST AT EACH ROOF TRUSS BEARING POINT, BASED ON THE TRUSS UPLIFT VALUES IN THE SIGNED AND SEALED TRUSS DESIGN PACKAGE AND SUITABLE FOR THE GEOMETRY. EMBED STRAP ON CENTERLINE OF WALL.


- CONNECTORS ARE SIMPSON STRUCTURAL CONNECTORS. ALL CONNECTORS SHALL BE INSTALLED IN STRICT ACCORDANCE WITH SIMPSON PRINTED INSTUCTIONS.
- SUBSTITUTIONS MUST BE APPROVED IN WRITING BY THE ENGINEER OF RECORD. WHERE EMBEDDED STRAPS ARE MISSING, OR MIS-LOCATED, INSTALL RETROFIT STRAP PER 10/5-3.

SIMPSON CATALOG C-C- 2019

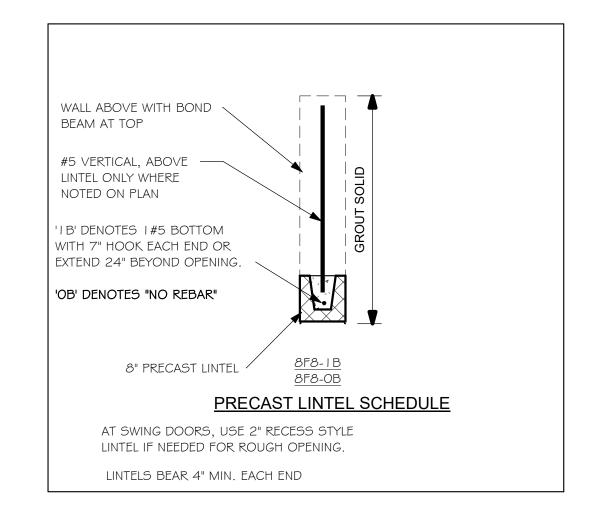

PLAN NOTES:

- ROOF TRUSS BEARING @ 8'-0".
- ROOF FRAMING SHALL BE WOOD TRUSSES DESIGNED BYA DELEGATED TRUSS ENGINEER PER DESIGN CRITERIA ON SHEET S-3.
- PROVIDE STRAPPING AT TRUSSES PER NOTES ON THIS SHEET.
- FOR NAILING OF ROOF AND FLOOR DECK, SEE I AND 2 ON S-3.
- 8F8-1B etc., DENOTES PRECAST LINTEL ABOVE
- DOORWINDOW OPENING PER SCHEDULE THIS SHEET.
- AT TRUSS BEARING, PROVIDE 8x8 MASONRY BOND BEAM W/ I #5 CONTINUOUS, SEE DETAIL I I/S-3.

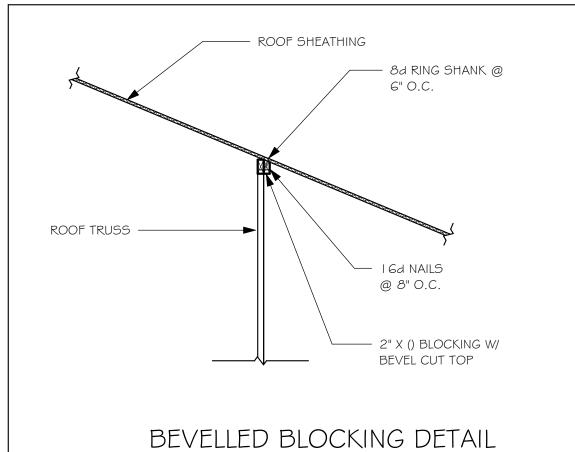


TRUSS BEARING CONDITIONS AND STRAPPING IS

BASED ON TRUSS LAYOUT PREPARED BY SCOSTA

JOB#: DR | 389BL DATED: | 1/30/20 REVISED: NONE

BEARING HEIGHT

= BEARING @ 8'-0"

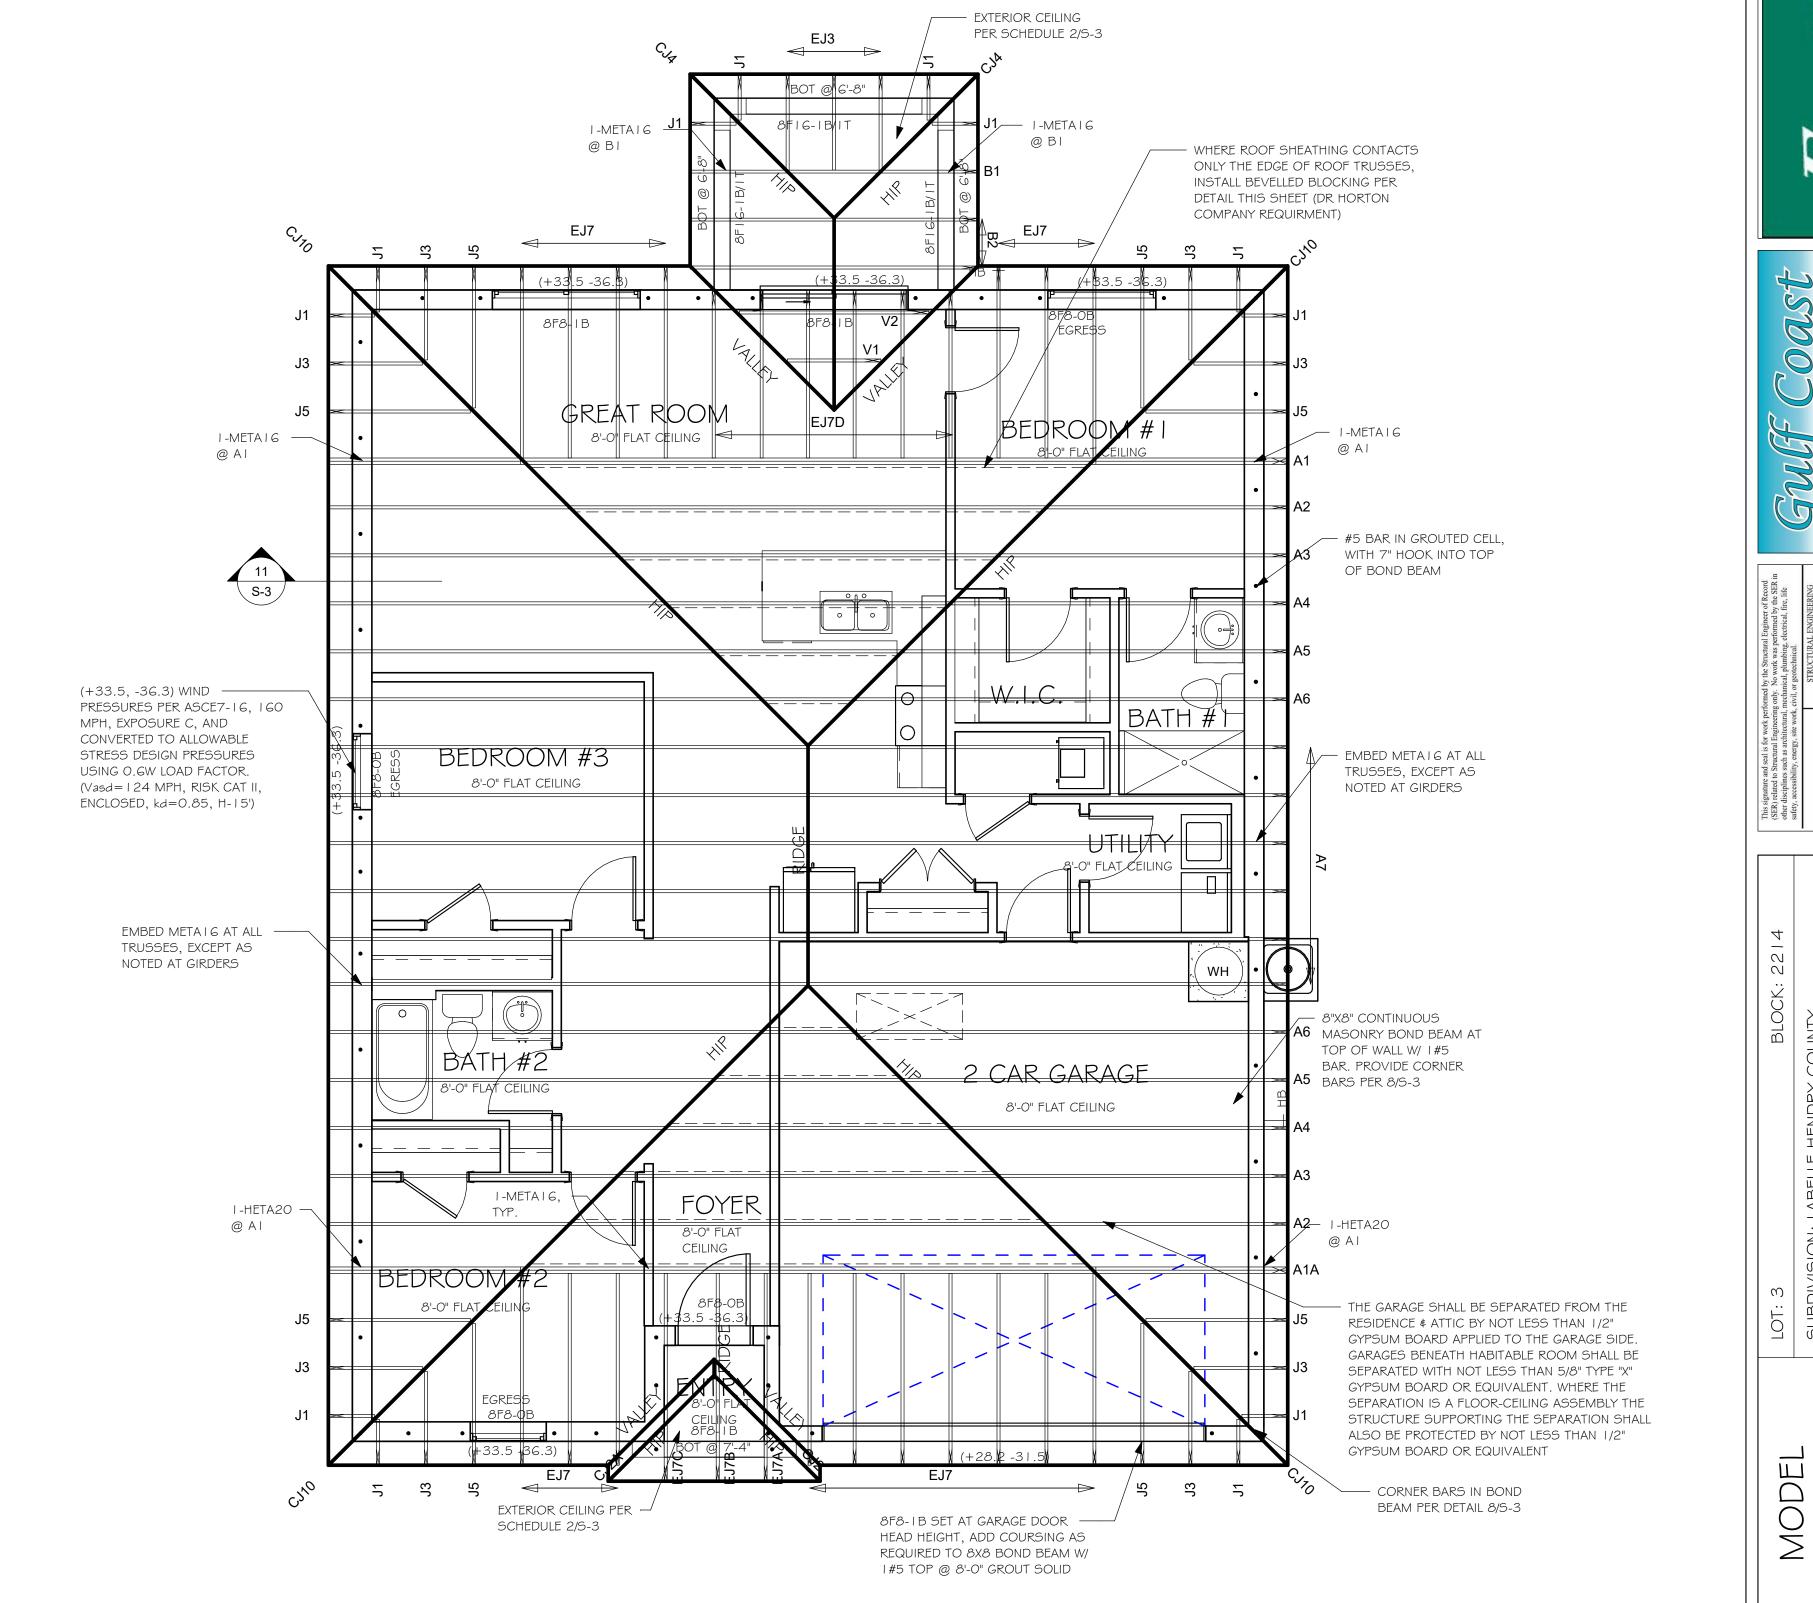

ROOF FRAMING PLAN 1/4" = 1'-0"

> DESIGN IN ACCORDANCE WITH THE RESIDENTIAL FLORIDA BUILDING CODE 2020 - 7TH EDITION

STRUCTURAL SYSTEMS OF NORTH FLORUM 1634 SE, 47th ST SUITE #3 CAPE CIRAL, FL 33904 (239) 549-4554

 \mathcal{O}

 \mathcal{C}

04/01/21

CWL

JWC

As indicated

DATE:

DRAWN BY:

CHECKED BY:

ROOF FRAMING PLAN

REVISED:

SCALE:

