

Engineer of Record for the Structure Structural Systems of N. Fl, Inc. Raul Reyes, PE 88925 1634 SE 47th Street #3 Cape Coral, FL 33904


This document has been reviewed for conformance with the design intent of the structure and specified design criteria.


☐ As Noted

Accepted Revise and

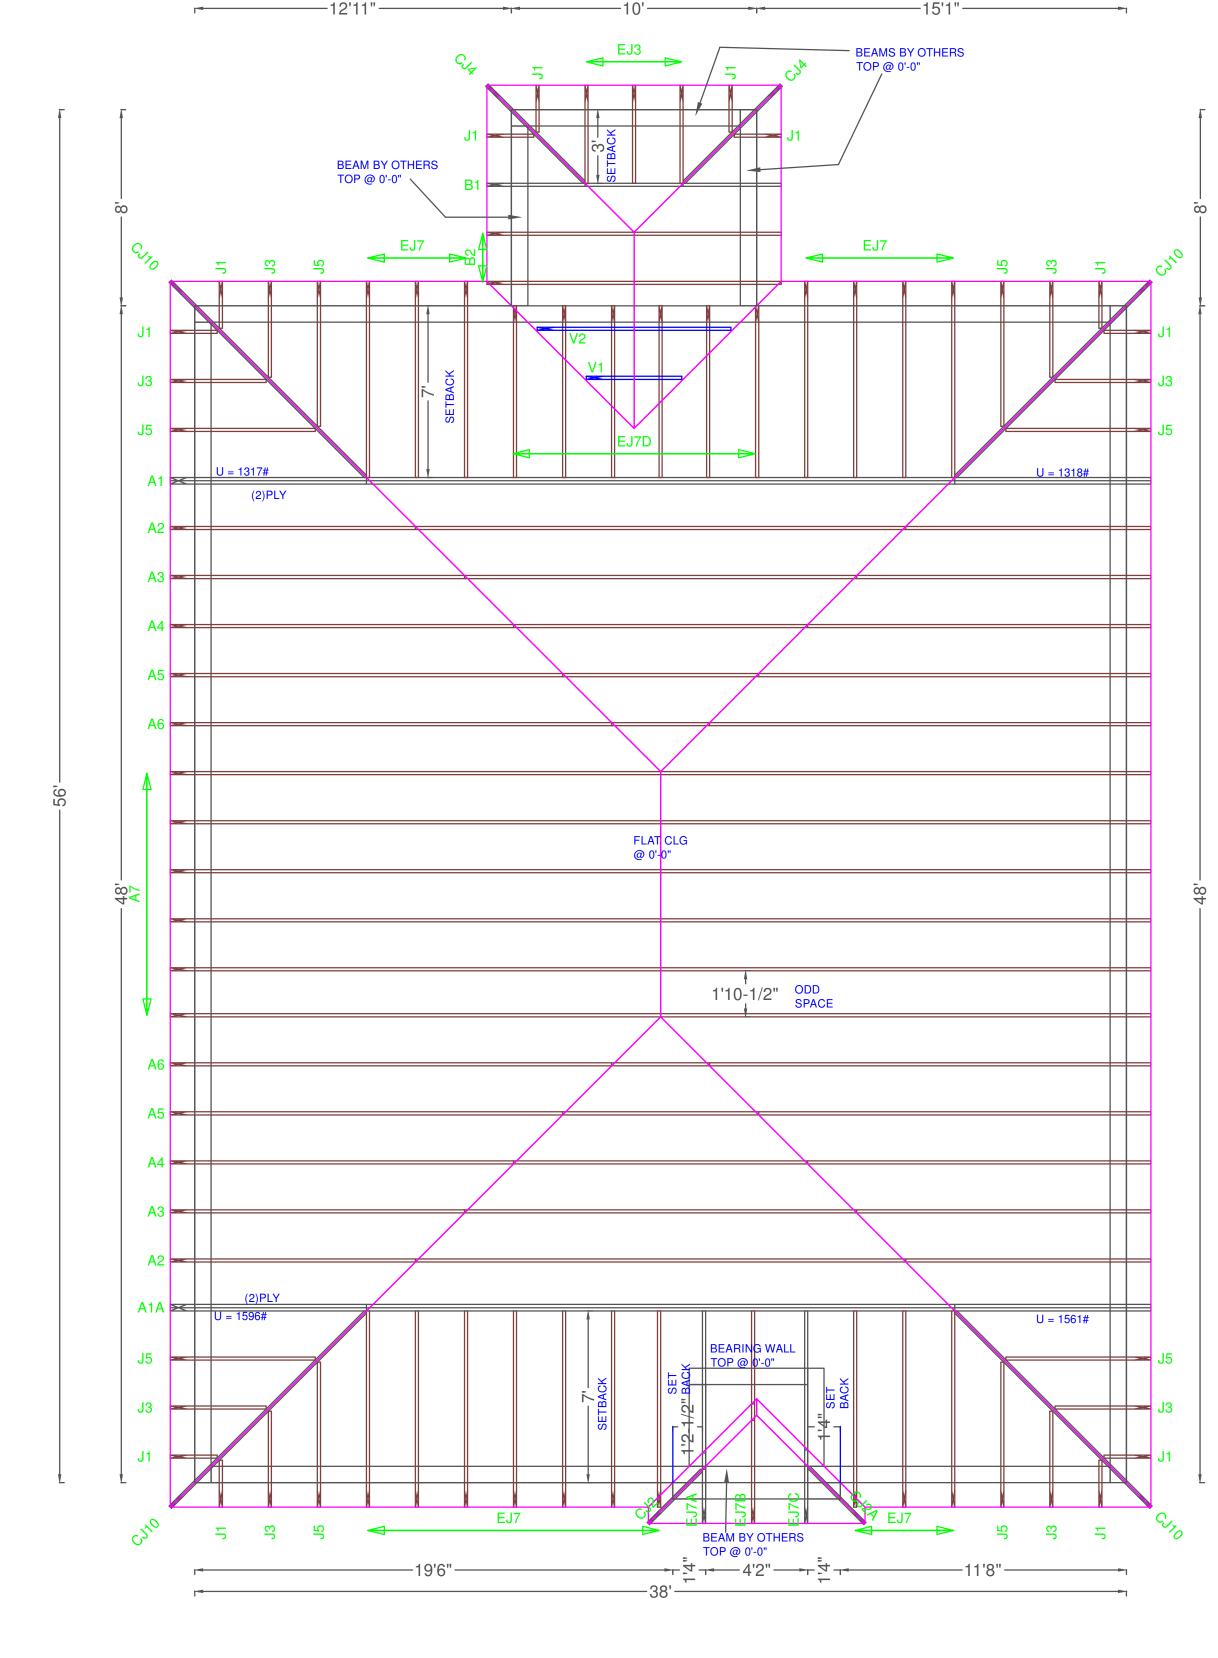

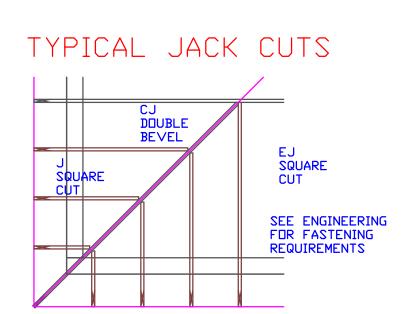

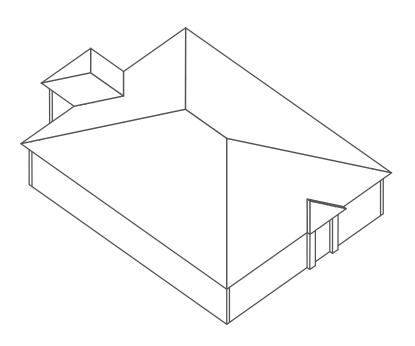

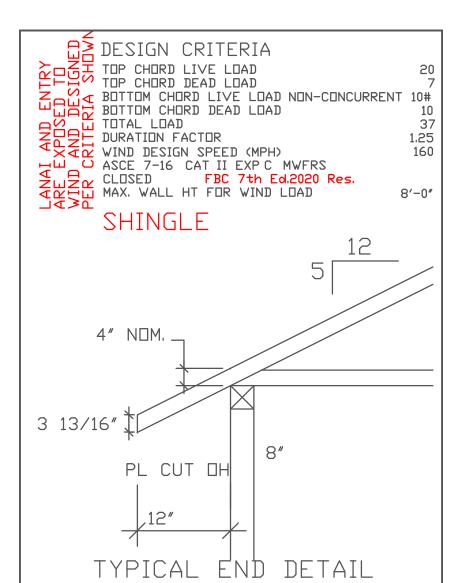

UNLESS NOTED

REACTION VALUES ARE UNDER 5000# UPLIFT VALUES ARE UNDER 1000#

ALL TRUSSES 24"o.c. UNLESS NOTED OTHERWISE

********* DO NOT ATTEMPT TO ERECT TRUSSES WITH-DUT REFERRING TO THE ENGINEERING DWGS.

IT IS NECESSARY TO REFER TO THE ENGINEERING DRAWINGS FOR NUMBER OF MEMBERS, BEARING LOCATION, DRIENTATION AND WEB BRACING

REFER TO WTCA/TPI BSCI-B1 SUMMARY SHEET FOR HANDLING METHODS & TEMPORARY BRACING, WHICH IS ALWAYS REQUIRED BEARING HEIGHTS BASED ON PLANS PROVIDED TO SCOSTA CORP. "+/-" BEARING DIFFERENCES SHOWN ARE CRITICAL. IF ANY HEIGHTS DEVIATE - INFORM SCOSTA

BEARING WALL & BEAM HEIGHTS

	0'-0"	ELE
7/////		ELE
		ELE
		ELE
HURRIGHE		ELE
		ELE
		ELE

TYPICAL HANGER SCHEDULE

- (C) SIMPSON HUS 26 (M) SIMPSON HGUS 28-3
- F SIMPSON HUS 28 N SIMPSON HHUS 48
- (H) SIMPSON HGUS 28 (P) SIMPSON LUS 24
- I SIMPSON HGUS 28-2 B SIMPSON THA 422
- (M) SIMPSON THJA26 (X)

HANGER VALUES HAVE BEEN BASED ON 16D COMMON NAILS EXCEPT THE FOLLOWING LUS24 - 10D COMMON THJA26 - 10D x 1-1/2


APPROVAL OF THIS TRUSS LAYOUT IS NECESSARY BEFORE FABRICATION CAN BEGIN. VERIFY DIMENSIONS, PITCHES, OVERHANGS, ELEVATIONS, CEILING & BEARING CONDITIONS. SCOSTA CORPORATION IS RESPONSIBLE FOR ACCURACY IN ACCORDANCE WITH PLANS AND/OR INFORMATION PROVIDED BY CUSTOMER, WITH ANY DEVIATIONS NOTED HEREIN. CUSTOMER IS RESPONSIBLE TO VERIFY ACCURACY OF INFORMATION AND PLANS PROVIDED TO SCOSTA CORPORATION, AND TO VERIFY CONFORMANCE TO FIELD CONDITIONS, AND/OR OWNER CHANGES. TRUSSES WILL BE BUILT IN ACCORDANCE WITH THE APPROVED LAYOUT.

APPROVED BY: _____

DATE: _____ REQUESTED DELIVERY DATE: JOBSITE CONTACT NAME:


PHONE #: ____ E-MAIL: _



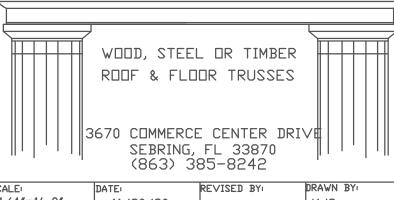

1/4"=1'-0" 11/30/20 JOB ADDRESS: 1389 B W/ LANAI GARAGE LEFT LEE CUSTOMER: JDB #


DR1389BL D.R. HORTON

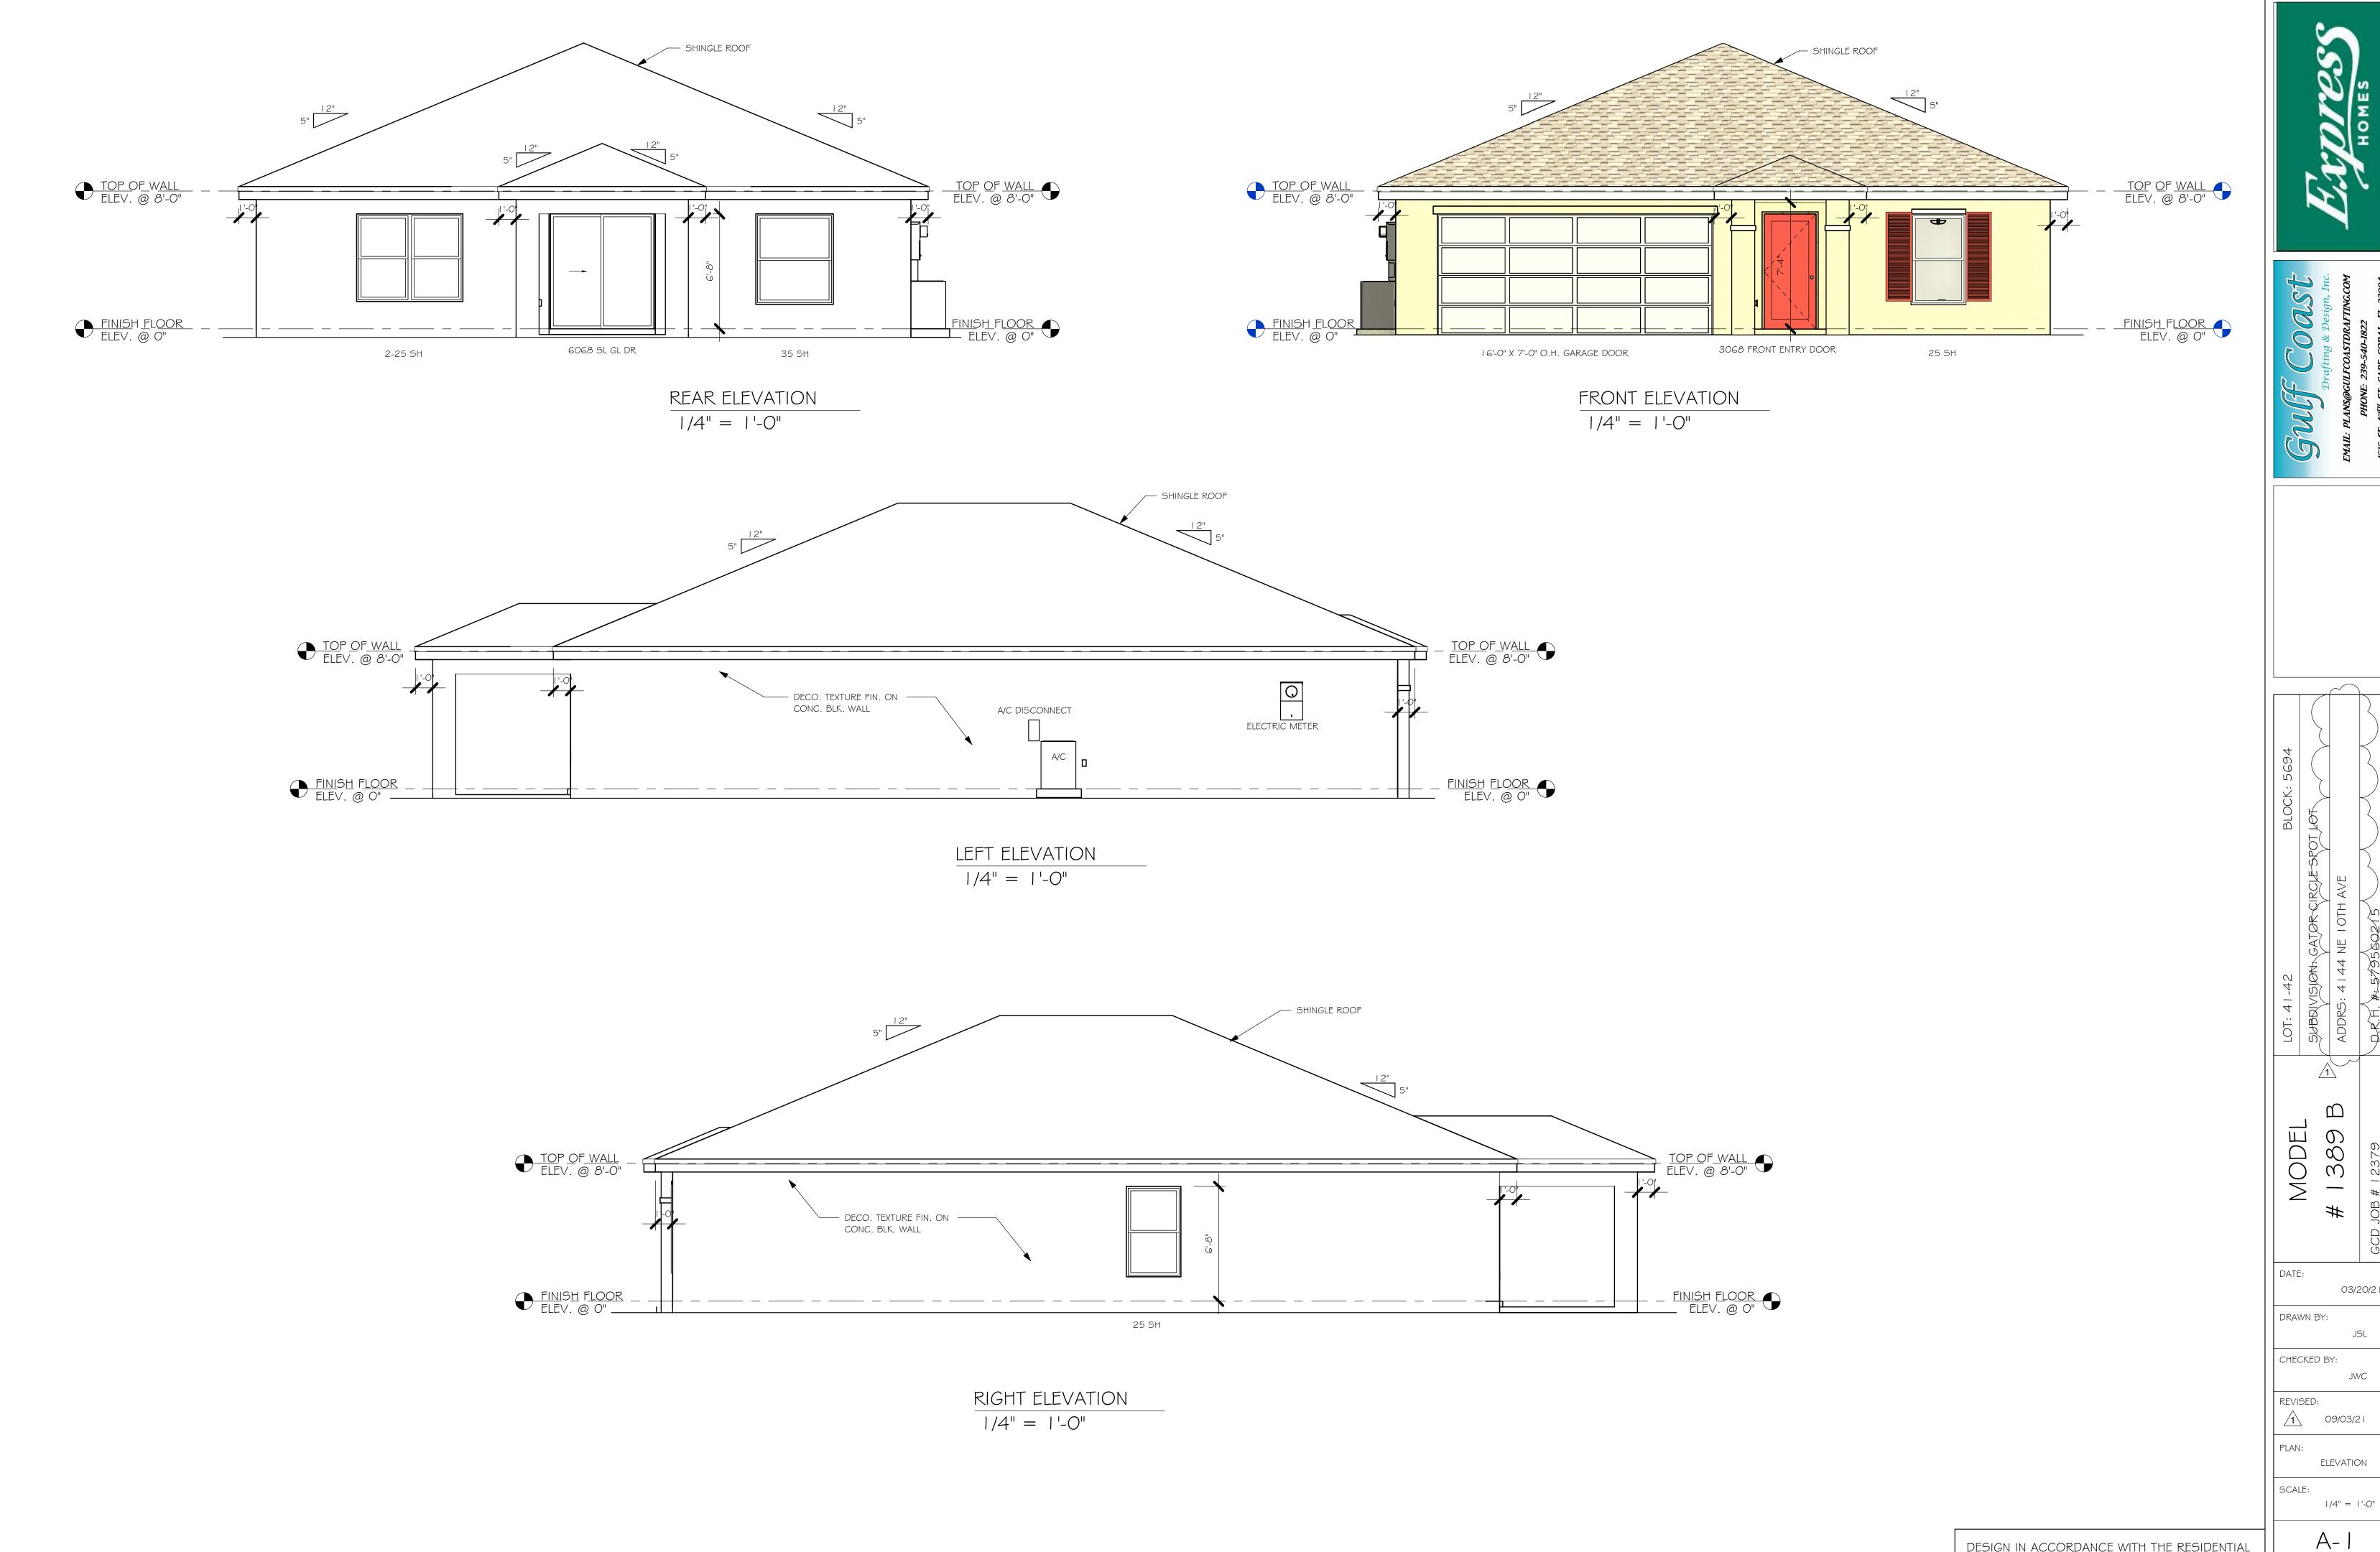



DESIGN IN ACCORDANCE WITH THE RESIDENTIAL FLORIDA BUILDING CODE 2020 - 7TH EDITION

03/20/21



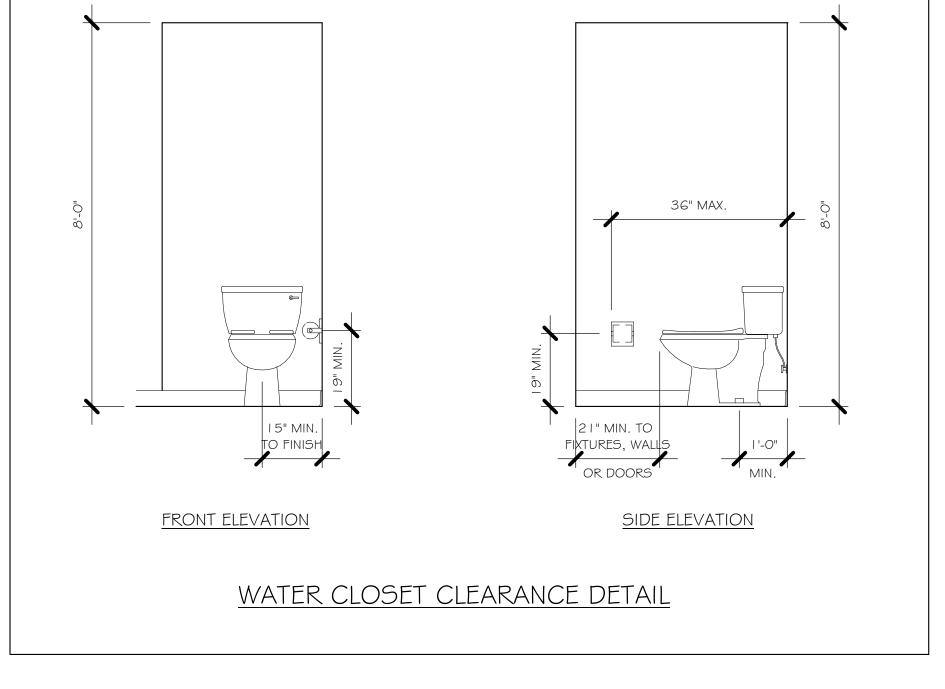

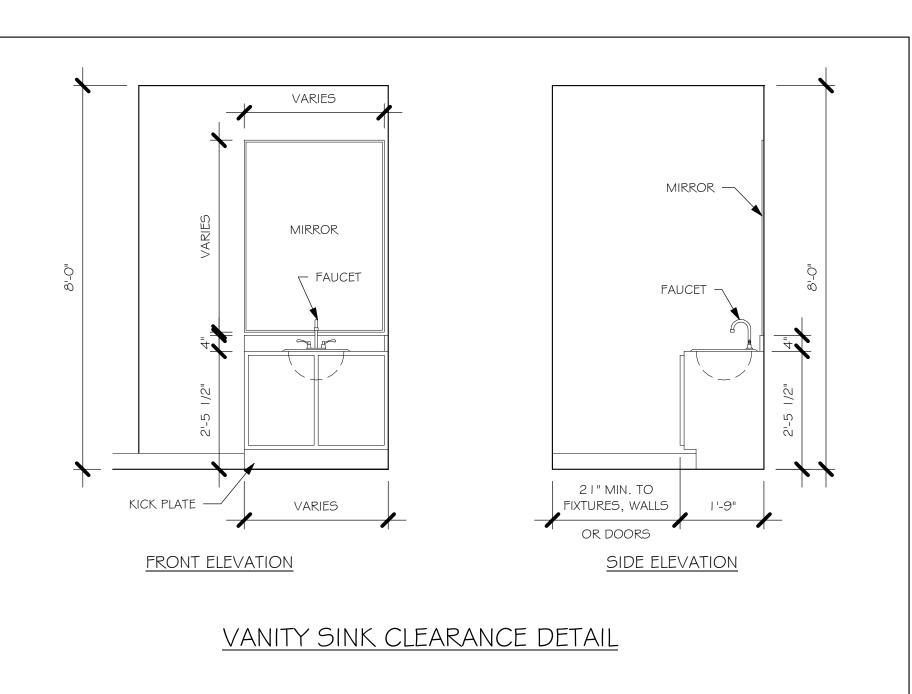

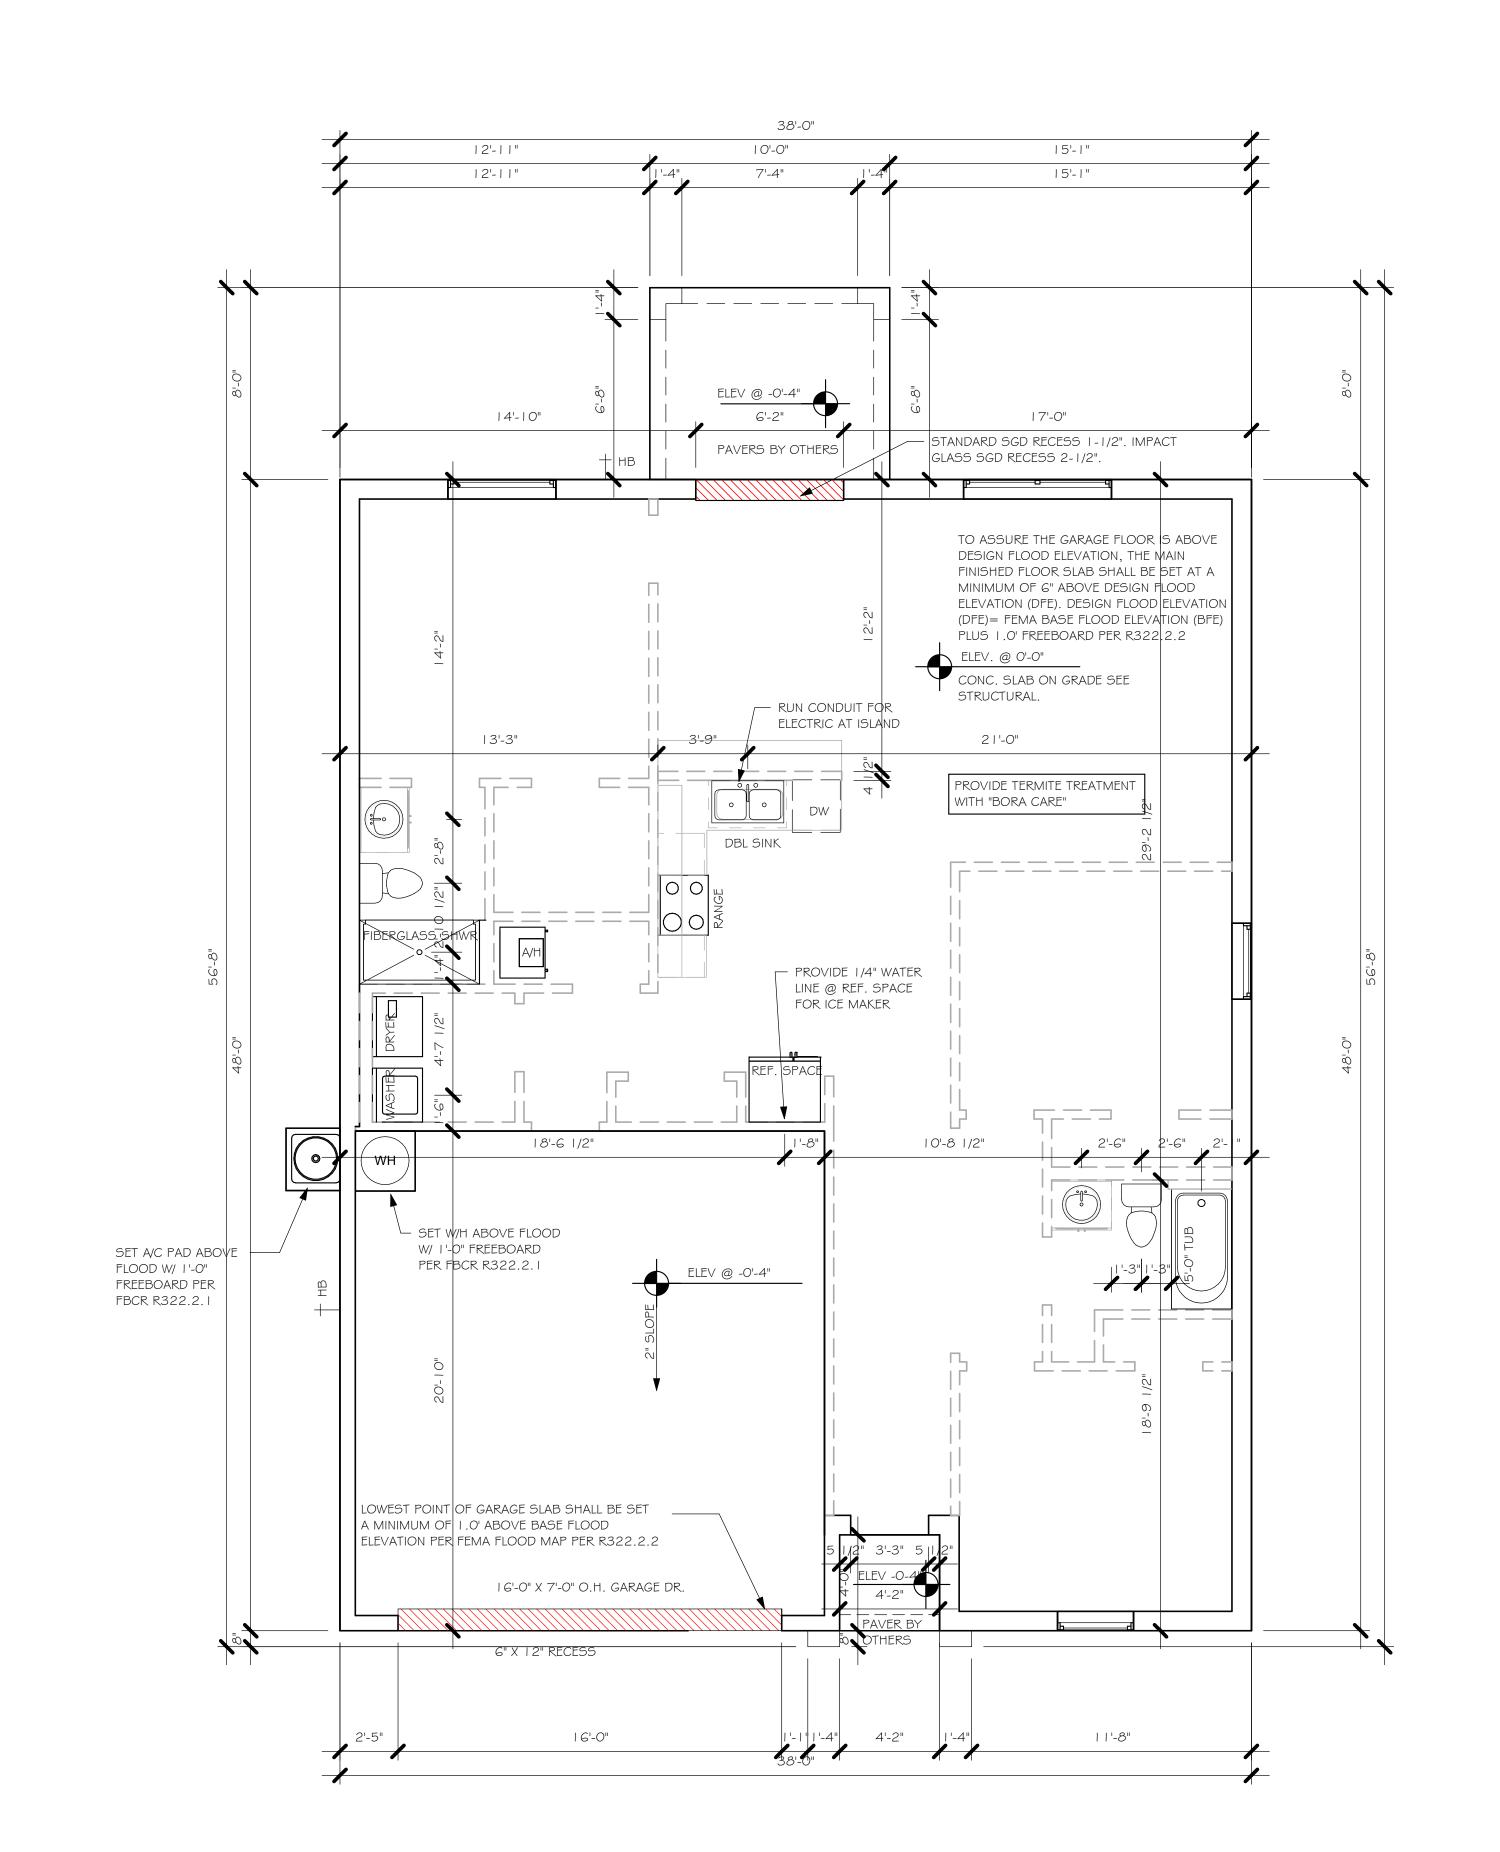

 $\frac{\text{SLAB } \text{ } \text{PLUMBING}}{1/4" = 1'-0"}$

DESIGN IN ACCORDANCE WITH THE RESIDENTIAL FLORIDA BUILDING CODE 2020 - 7TH EDITION

MODEL

DATE:

DRAWN BY:

CHECKED BY:

REVISED:

PLAN:


SCALE:

03/20/21

09/03/21

As indicated

SLAB & PLUMBING

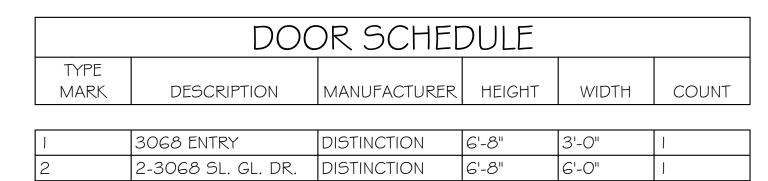

GARAGE DOOR

7'-0"

16'-0"

	WINDOW SCHEDULE							
MARK	MARK DESCRIPTION MANUFACTURER HEIGHT WIDTH COUNT							

Α	2-25 SH	5'-3"	6'-4"	1
В	25 SH	5'-5"	3'-4"	2
С	35 SH	5'-5"	4'-8"	1

DOOR HEADERS						
6'-8" BI-FOLD	HEADER HEIGHT	82" A.F.F.				
6'-8" SWING	HEADER HEIGHT	82 I/2" A.F.F.				
8'-0" SWING	HEADER HEIGHT	98 I/2" A.F.F.				

PLAN NOTES

VERIFY ALL ROUGH OPENING DIMENSIONS FOR ALL WINDOWS AND DOORS

16070 OHGD

- PROVIDE SAFETY GLAZING WITHIN 24" FROM EXIT PER FLORIDA BUILDING CODE R 308.4.2.
- PROVIDE SAFETY GLAZING AT BATH/ SHOWER PER FLORIDA BUILDING CODE R 308.4.5.
- NON BEARING INTERIOR FRAME WALLS SHALL BE FRAMED W/ WOOD OR METAL STUDS. SPACING SHALL NOT EXCEED 24" O.C. (NON BEARING WALLS ONLY)
- PROVIDE DEAD WOOD IN ATTIC FOR OVERHEAD GARAGE DOOR HARDWARE
- KITCHEN KNEE WALL TO BE FRAMED W/ TOP @ 34 I/2" A.F.F.
- INSTALL SMOOTH WALLS IN KITCHEN AND ALL

BATHROOM AREAS

- WHERE DRYWALL CEILING IS APPLIED TO TRUSSES @ 24" O.C. USE 5/8" DRYWALL OR 1/2" SAG RESISTANT PER SEC. R702.3.5
- THE GARAGE SHALL BE SEPARATED FROM THE RESIDENCE & ATTIC BY NOT LESS THEN 1/2" GYPSUM BOARD APPLIED TO THE GARAGE SIDE. GARAGES BENEATH HABITABLE ROOMS SHALL BE SEPARATED WITH NOT LESS THAN 5/8" TYPE "X" GYPSUM BOARD OR EQUIVALENT. WHERE THE SEPARATIION IS A FLOOR - CEILING ASSEMBLY, THE STRUCTURE SUPPORTING THE SEPARTION SHALL ALSO BE PROTECTED BY NOT LESS THAN 1/2" GYPSOM BOARD OR EQUIVALENT
- 10) INSTALL 1 3/8" THICK SOLID WOOD DOOR BETWEEN LIVING AND GARAGE PER FLORIDA BUILDING CODE R302.5.1,
- II) ALL WINDOWS INSTALLED 72" ABOVE GRADE MUST COMPLY WITH R3 | 2.2 MIN 24" SILL HEIGHT OR PROVIDED WITH AN APPROVED WINDOW FALL PREVENTION DEVICE
- 12) ALL CLOSET SHELVES TO BE 12". ALL PANTRY \$ LINEN TO BE (4)-16" SHELVES 18" O.F.F. W/ 15" INCREMENT.
- 13) ALL MECHANICAL AND ELECTRICAL EQIUPMENT TO BE INSTALLED AT OR ABOVE FLOOD PLUS 1'-0" FREEBOARD.

INTERIOR DOOR SCHEDULE							
MARK	DOOR WIDTH	NOTES					
	3'-0"	P.K. = POCKET DOOR					
2	2'-8"	B.F. = BI-FOLD DOOR					
3	2'-6"	D.1 DI-1 OLD DOOK					
4	2'-4"	B.P. = BI-PASS DOOR					
5	2'-0"	L.V. = LOUVERED DOOI					
6	1'-8"						
7	1'-6"						
8	2'-11"						


SQUARE FOOTAGE					
LIVING AREA	1,389				
GARAGE AREA	419				
LANAI AREA	80				
FRONT PORCH/ ENTRY AREA	16				
TOTAL SQUARE FOOTAGE	1,904				


CABINET BACKING							
KITCHEN	UPPER TOP @ 84"	BASE TOP @ 35"					
MASTER BATH	UPPER	BASE TOP @ 35"					
GUEST BATH	UPPER	BASE TOP @ 31"					
LAUNDRY ROOM	UPPER TOP @ 84"	BASE					
·	-						

TYPICAL DIMENSION STRING

FACE OF OUTSIDE WALL TO FACE OF STUD WALL FACE OF STUD TO FACE OF STUD

	· ·	
TP	TOILET PAPER	ALL BLOCKING TO BE PT IN SHOWERS
	10-14 -0-14	TOWEL BAR TOILET PAPER ROLL A A A A A A A A A A A A A A A A A A

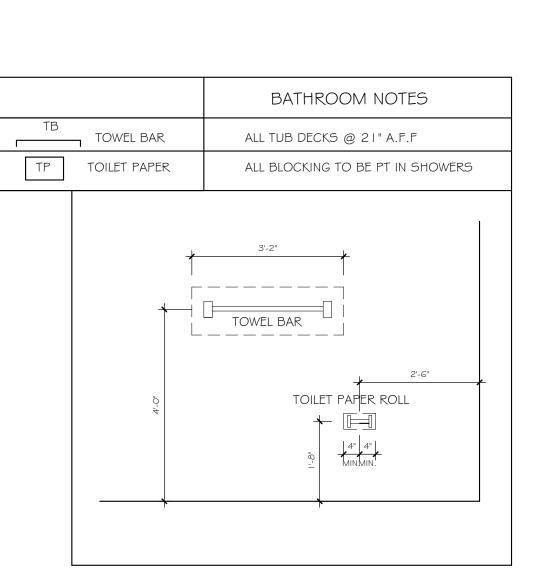

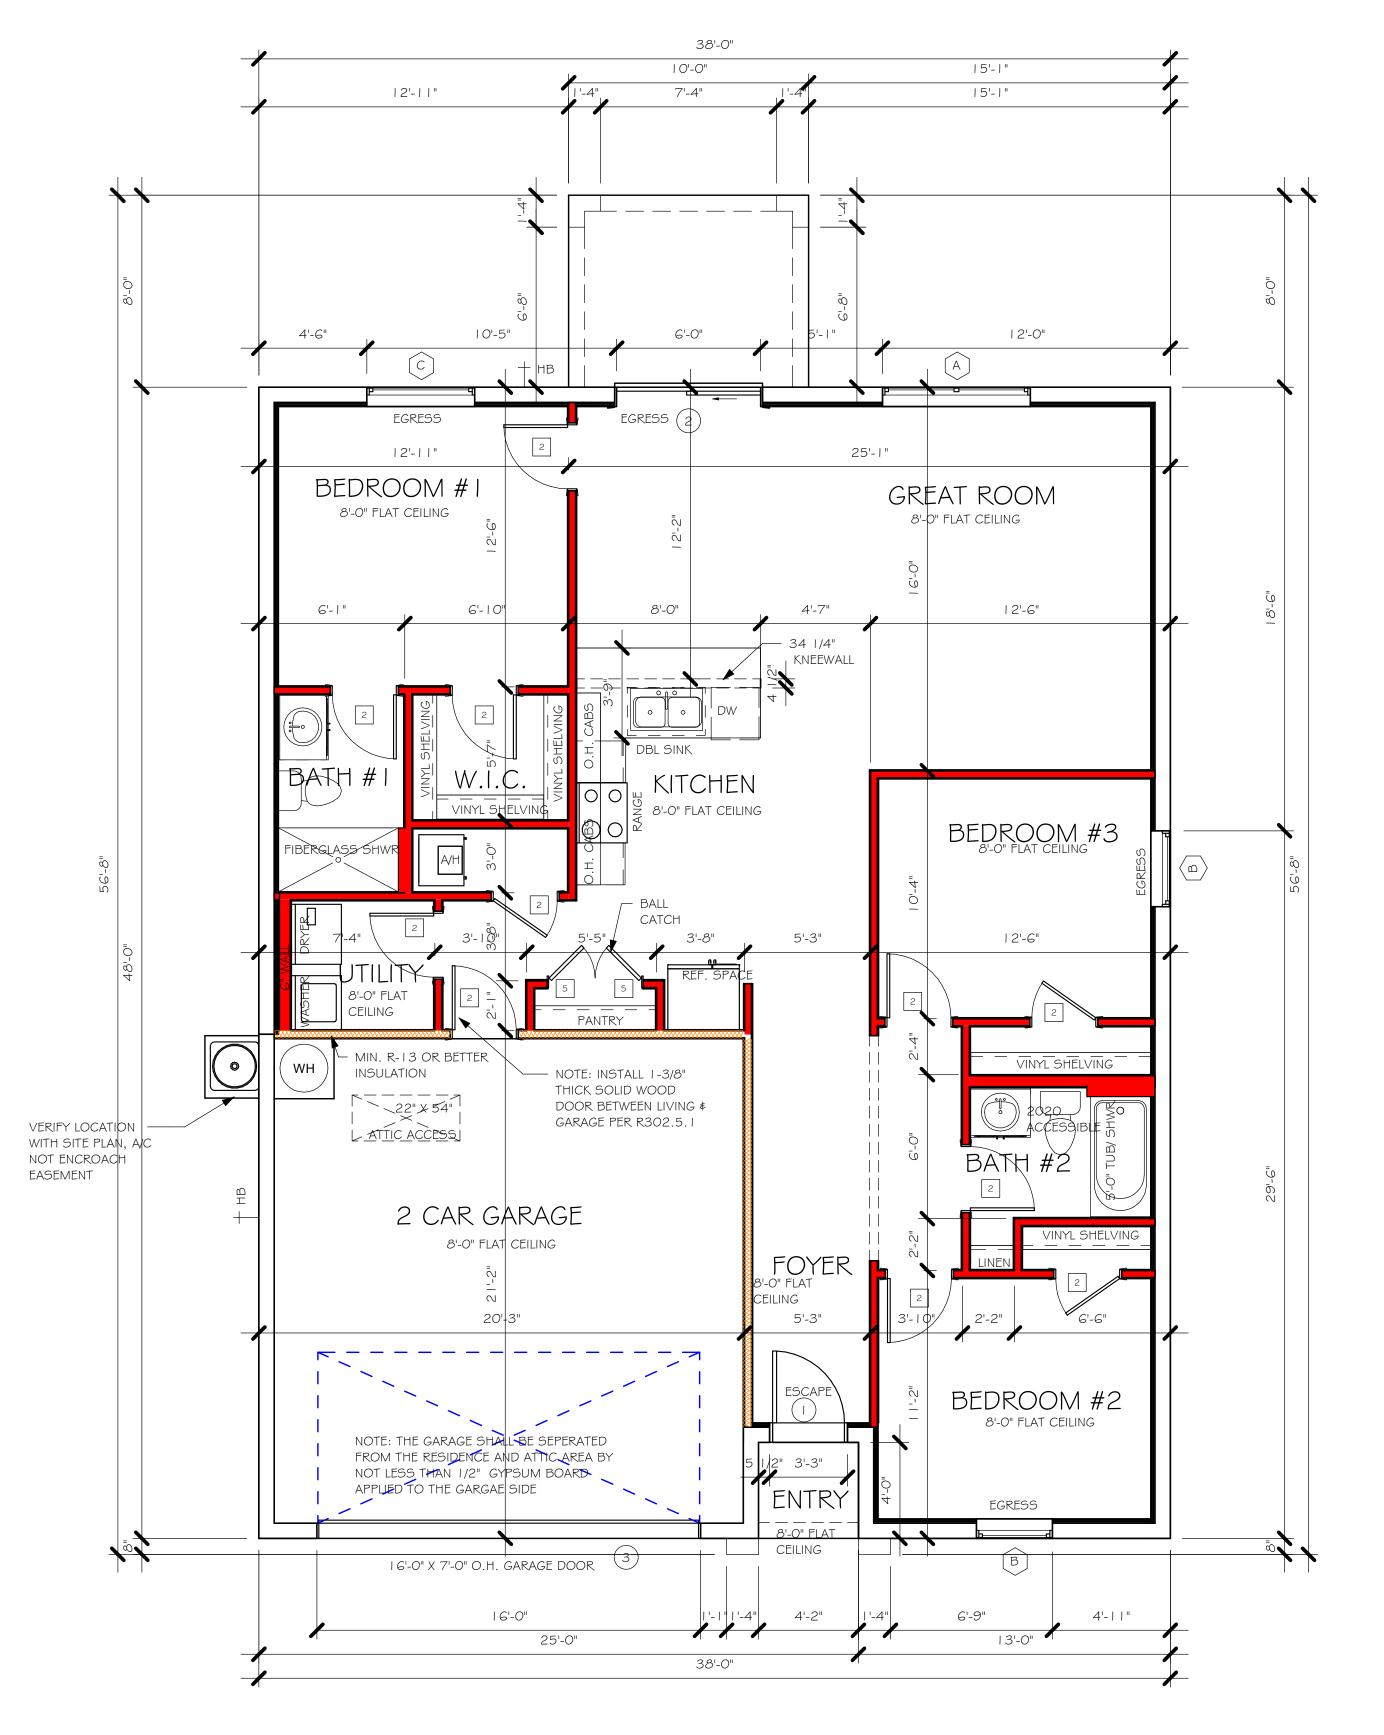

FLOOR PLAN 1/4" = 1'-0"

FACE OF EXTERIOR WALL —

DESIGN IN ACCORDANCE WITH THE RESIDENTIAL FLORIDA BUILDING CODE 2020 - 7TH EDITION

DATE:

DRAWN BY:

CHECKED BY:

REVISED:

PLAN:

SCALE:

03/20/21

JWC

09/03/21

FLOOR

As indicated

MODEL 1389 B: ATTIC VENTILATION FBCR R806

WITH ROOF VENTS (1/300)

(R.V.)

ATTIC VENTILATION REQUIRED

ATTIC AREA/300 QUANTITY OF ROOF VENTS MIN AIR FLOW OF SOFFIT

ROOF VENT MODEL

LOMANCO 770-D 0.97 SQ. FT. FREE AIR

ROOF VENTS ARE NOT REQUIRED

-.-- SQ. FT. -

COORDINATE VENTING REQUIREMENTS WITH ENERGY CALCULATIONS

SOFFIT ONLY (1/150) (NO ROOF VENTS)

ATTIC AREA/150 | REQ'D AIR FLOW | QUAD 4 SOFFIT | HAS | 13.33 SQ. FT. | 7.57% | 8.15%

"SOFFIT ONLY" QUALIFIES

SOFFIT MODEL

WALL HEIGHT

ACM QUAD 4, FULL VENT, NARROW PATTERN, 8.15% FREE AIR FLOW

= WALL @ 8'-0"

ATTIC VENTILATION REQUIRED

AREAS (SQ. FT.)

MARK ATTIC SOFFIT 1st STORY 2000.0 SQ. FT. 176.0 SQ. FT.

> ROOF PLAN 1/4" = 1'-0"

GREAT ROON 8'-0" FLAT CEILING BEDROOM #3 8'-0" FLAT CEILING 8'-0" FLAT CEILING 2 CAR GARAGE FOYER 8'-0" FLAT CEILING

> DESIGN IN ACCORDANCE WITH THE RESIDENTIAL FLORIDA BUILDING CODE 2020 - 7TH EDITION

SCALE: As indicated A-4

MODEL

DATE:

DRAWN BY:

CHECKED BY:

REVISED:

PLAN:

03/20/21

09/03/21

ROOF

_	
Θ	SINGLE POLE SWITCH
() 3	3 WAY SWITCH
() □	DIMMER SWITCH
₩ ^S	MOTION SENSOR SWITCH
Sp Scp	AC/DC SMOKE DETECTOR TO BE INTERCONNECTED ANY RESIDENT HAVING A FOSSIL-BURNIN HEATER OR APPLIANCE, A FIREPLACE, OR AN ATTACHED GARAGE SHALL HAVE AN OPERATIONAL CARBON MONOXIDE ALARN INSTALLED WITHIN 10 FEET OF EACH ROOM USED FOR SLEEPING PERPOSES. PER RULE 9B-3.04.72 SD (SMOKE DETECTOR) SCD (CARBON MONOXIDE/ SMOKE DETECTOR)
-[T]	TELEPHONE OUTLET
-TV	TELEVISION RECEPTION OUTLET
-	SURFACE MOUNTED CEILING LIGHT
0	FLUSH MOUNTED LIGHT
Ю	WALL MTD. BRACKET LIGHT
464	DUPLEX FLOOD LIGHT
	EXHAUST FAN
	TRACK MTD. LIGHTS
마	A/C DISCONNECT
Ю	PUSH BUTTON (PB) / DOOR BELL (DB)
(IC)	INTERCOM
P	KEYPAD
)	4' FLUORESCENT LIGHT
)	2' UNDER COUNTER LIGHT
NOTE: NO	OT ALL SYMBOLS ARE USED FOR THIS
ARC-FAUI RESISTAN IN DWELLI ALL ELECT OR ABOV	AL NOTES: LT CIRCUIT-INTERRUPTERS AND TAMPER IT RECEPTACLES SHALL BE INSTALLED ING UNITS PER N.E.C 2 0 , 2 AND 406 , TRIC, ELECTRICAL EQUIPMENT AND APPLIANCES TO BE SET A' /E BASE FLOOD ELEVATION PLUS '-0" FREEBOARD. ETS IN WET AREAS AND ALL
	R OUTLETS TO BE GFI'S.

INSTALL PHONE AND T.V PER CONTRACT.

INSTALL ALL ELECTRICAL PER NEC 2014

ELECTRICAL LEGEND

ELECTRICAL METER

I 20 V JUNCTION BOX

SINGLE RECEPTACLE OUTLET

220 V RECEPTACLE OUTLET

4-PLEX RECEPTACLE OUTLET

DUPLEX RECEPTACLE OUTLET


1/2 SWITCHED DUPLEX OUTLET


DUPLEX RECEPTACLE AT ELEV. A.F.F.


DUPLEX RECEPTACLE - ABOVE COUNTER


ELECTRICAL PANEL


	ELECTRIC	AL PLAN 1389	
200	AMP SERVICE		
TAG	QUANTITY	PRODUCT	
Α	(X)	(FLUSH MOUNTED LT)	
В	(X)	(VAPORS)	
С	(X)	(PENDANT LIGHT	
D	(10)	(10" MUSHROOMS)	
E	(2)	(24" 3 LT)	
F	(X)	(36" 4 LT)	
G	(X)	(NOT USED)	
Н	(2)	(COACH LIGHTS)	
- 1	(X)	(COACH LIGHTS)	
J	(X)	(J BOX)	
Κ	(1)	(4' FLUORESCENT)	
L	(X)	(2' FLUORESCENT)	
М	(X)	(5LT CHANDELIER)	
Ν	(X)	(3 LT)	
0	(X)	(PENDANT/ NOOK)	
Р	(X)	(X)	
Q	(X)	(X)	

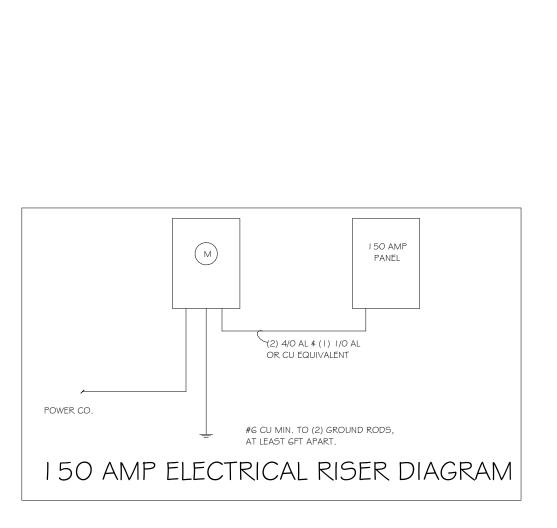

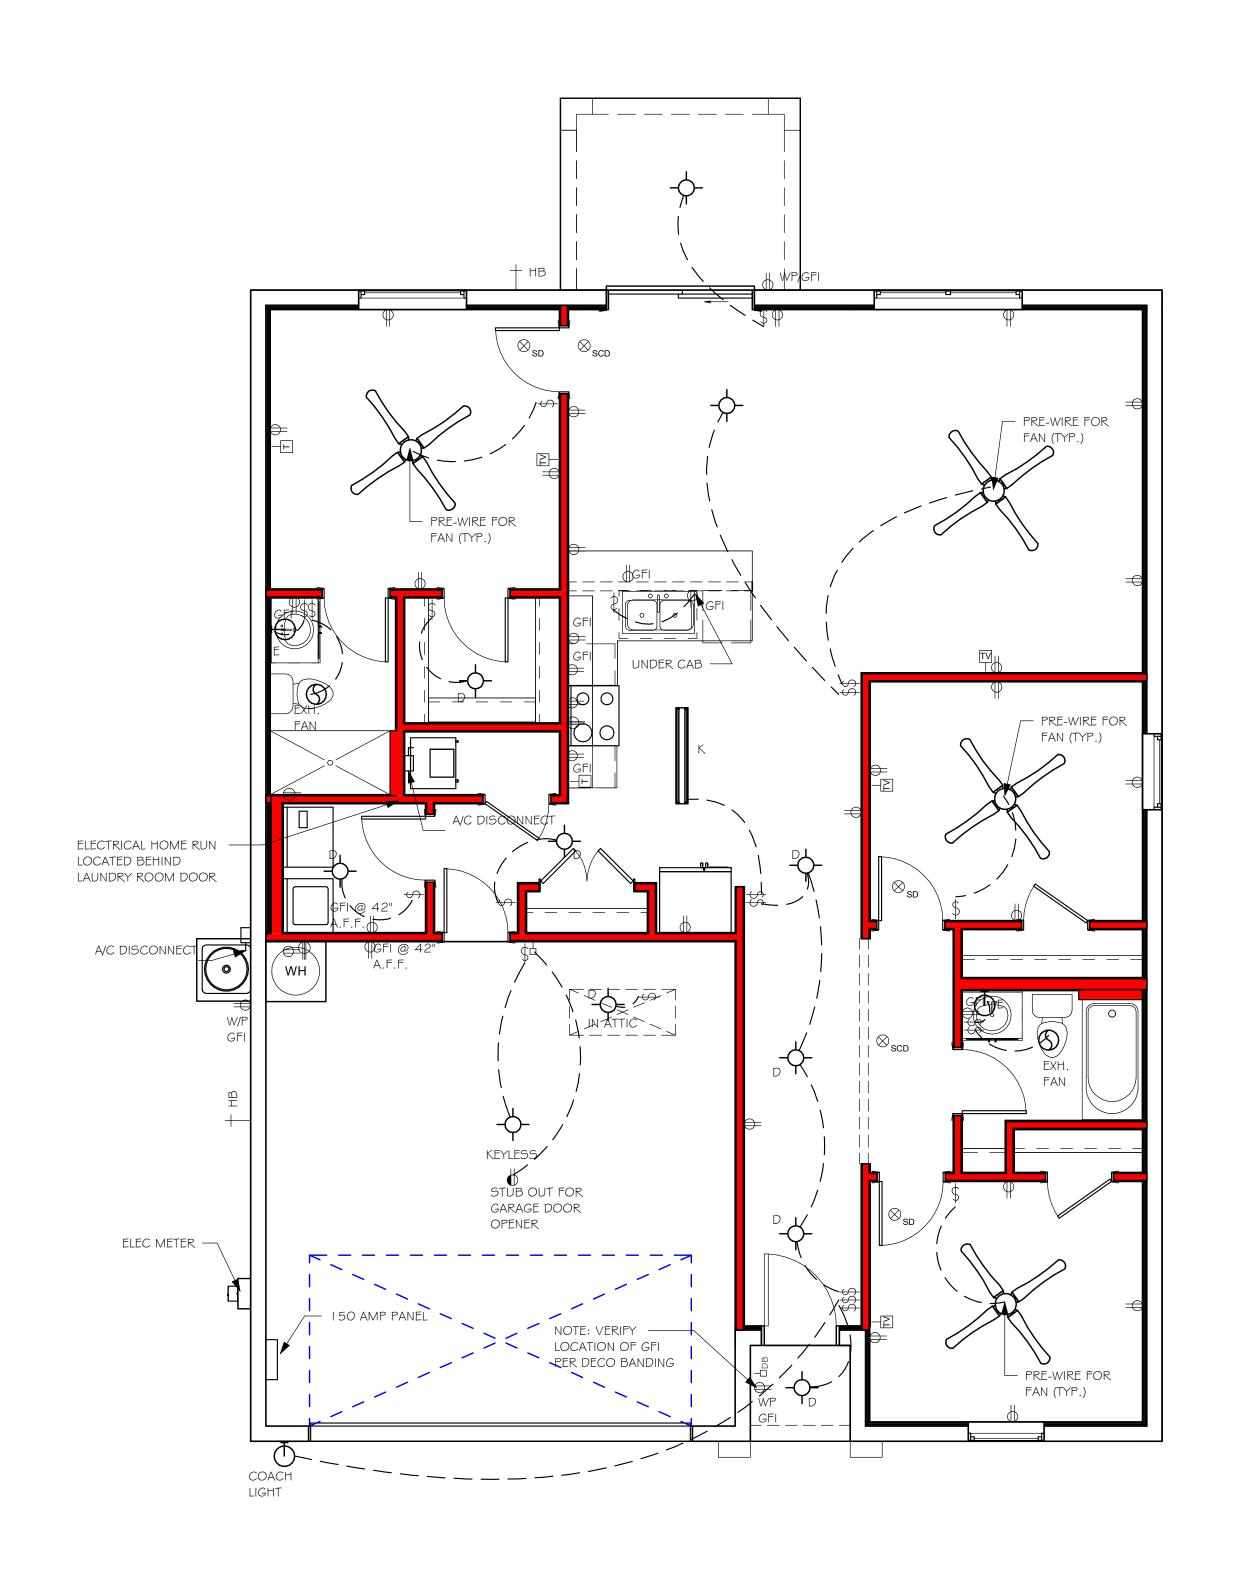


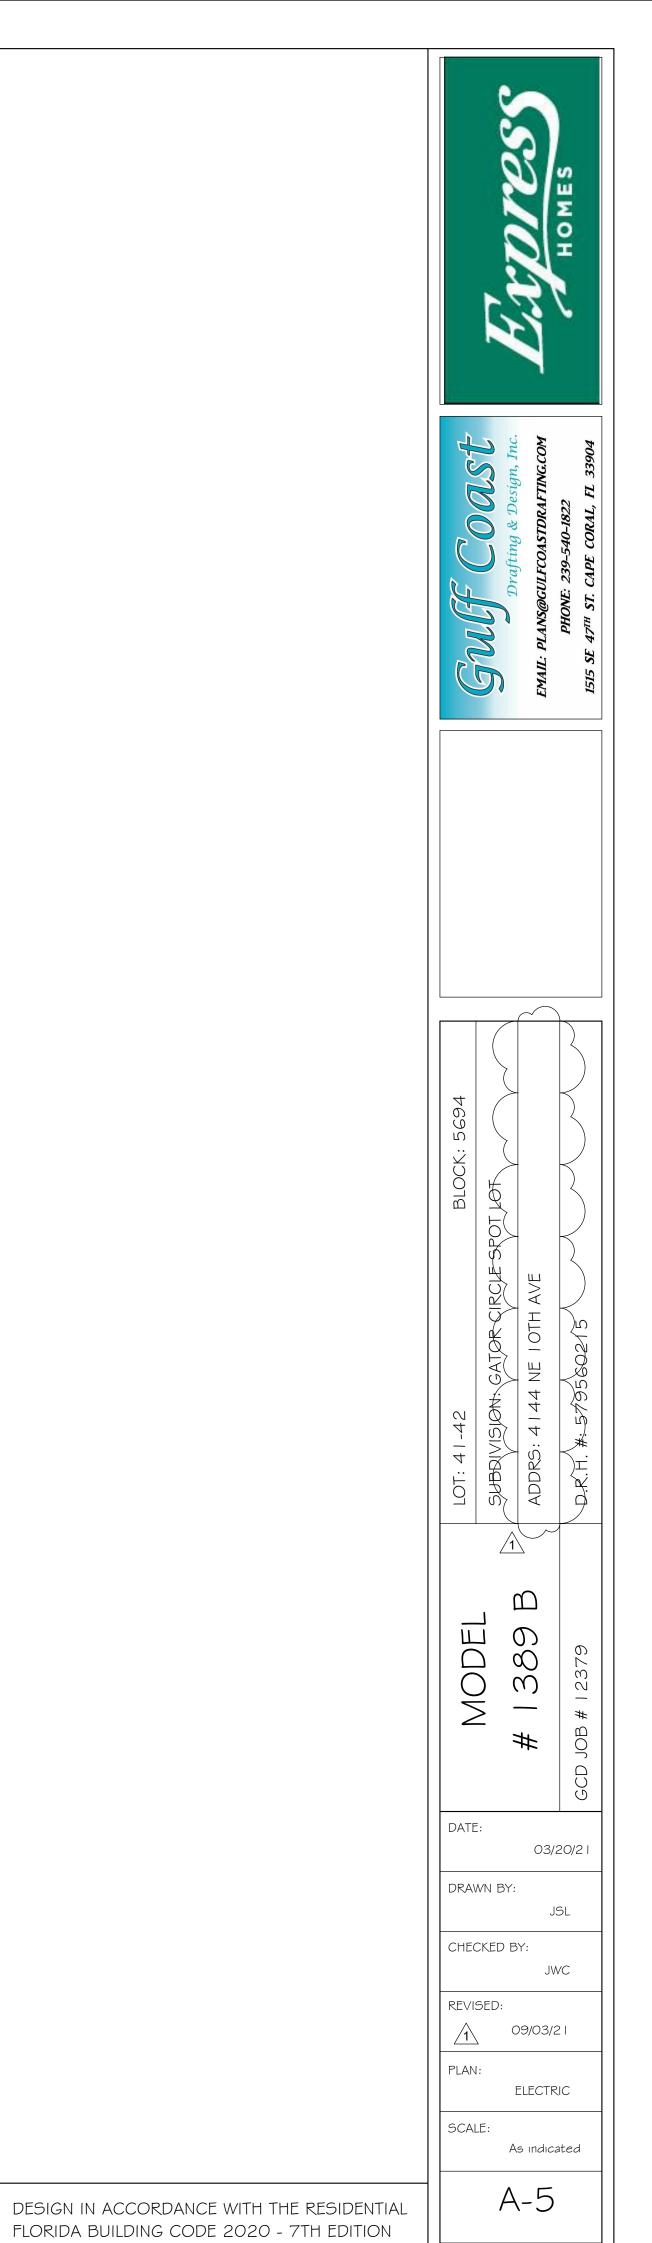

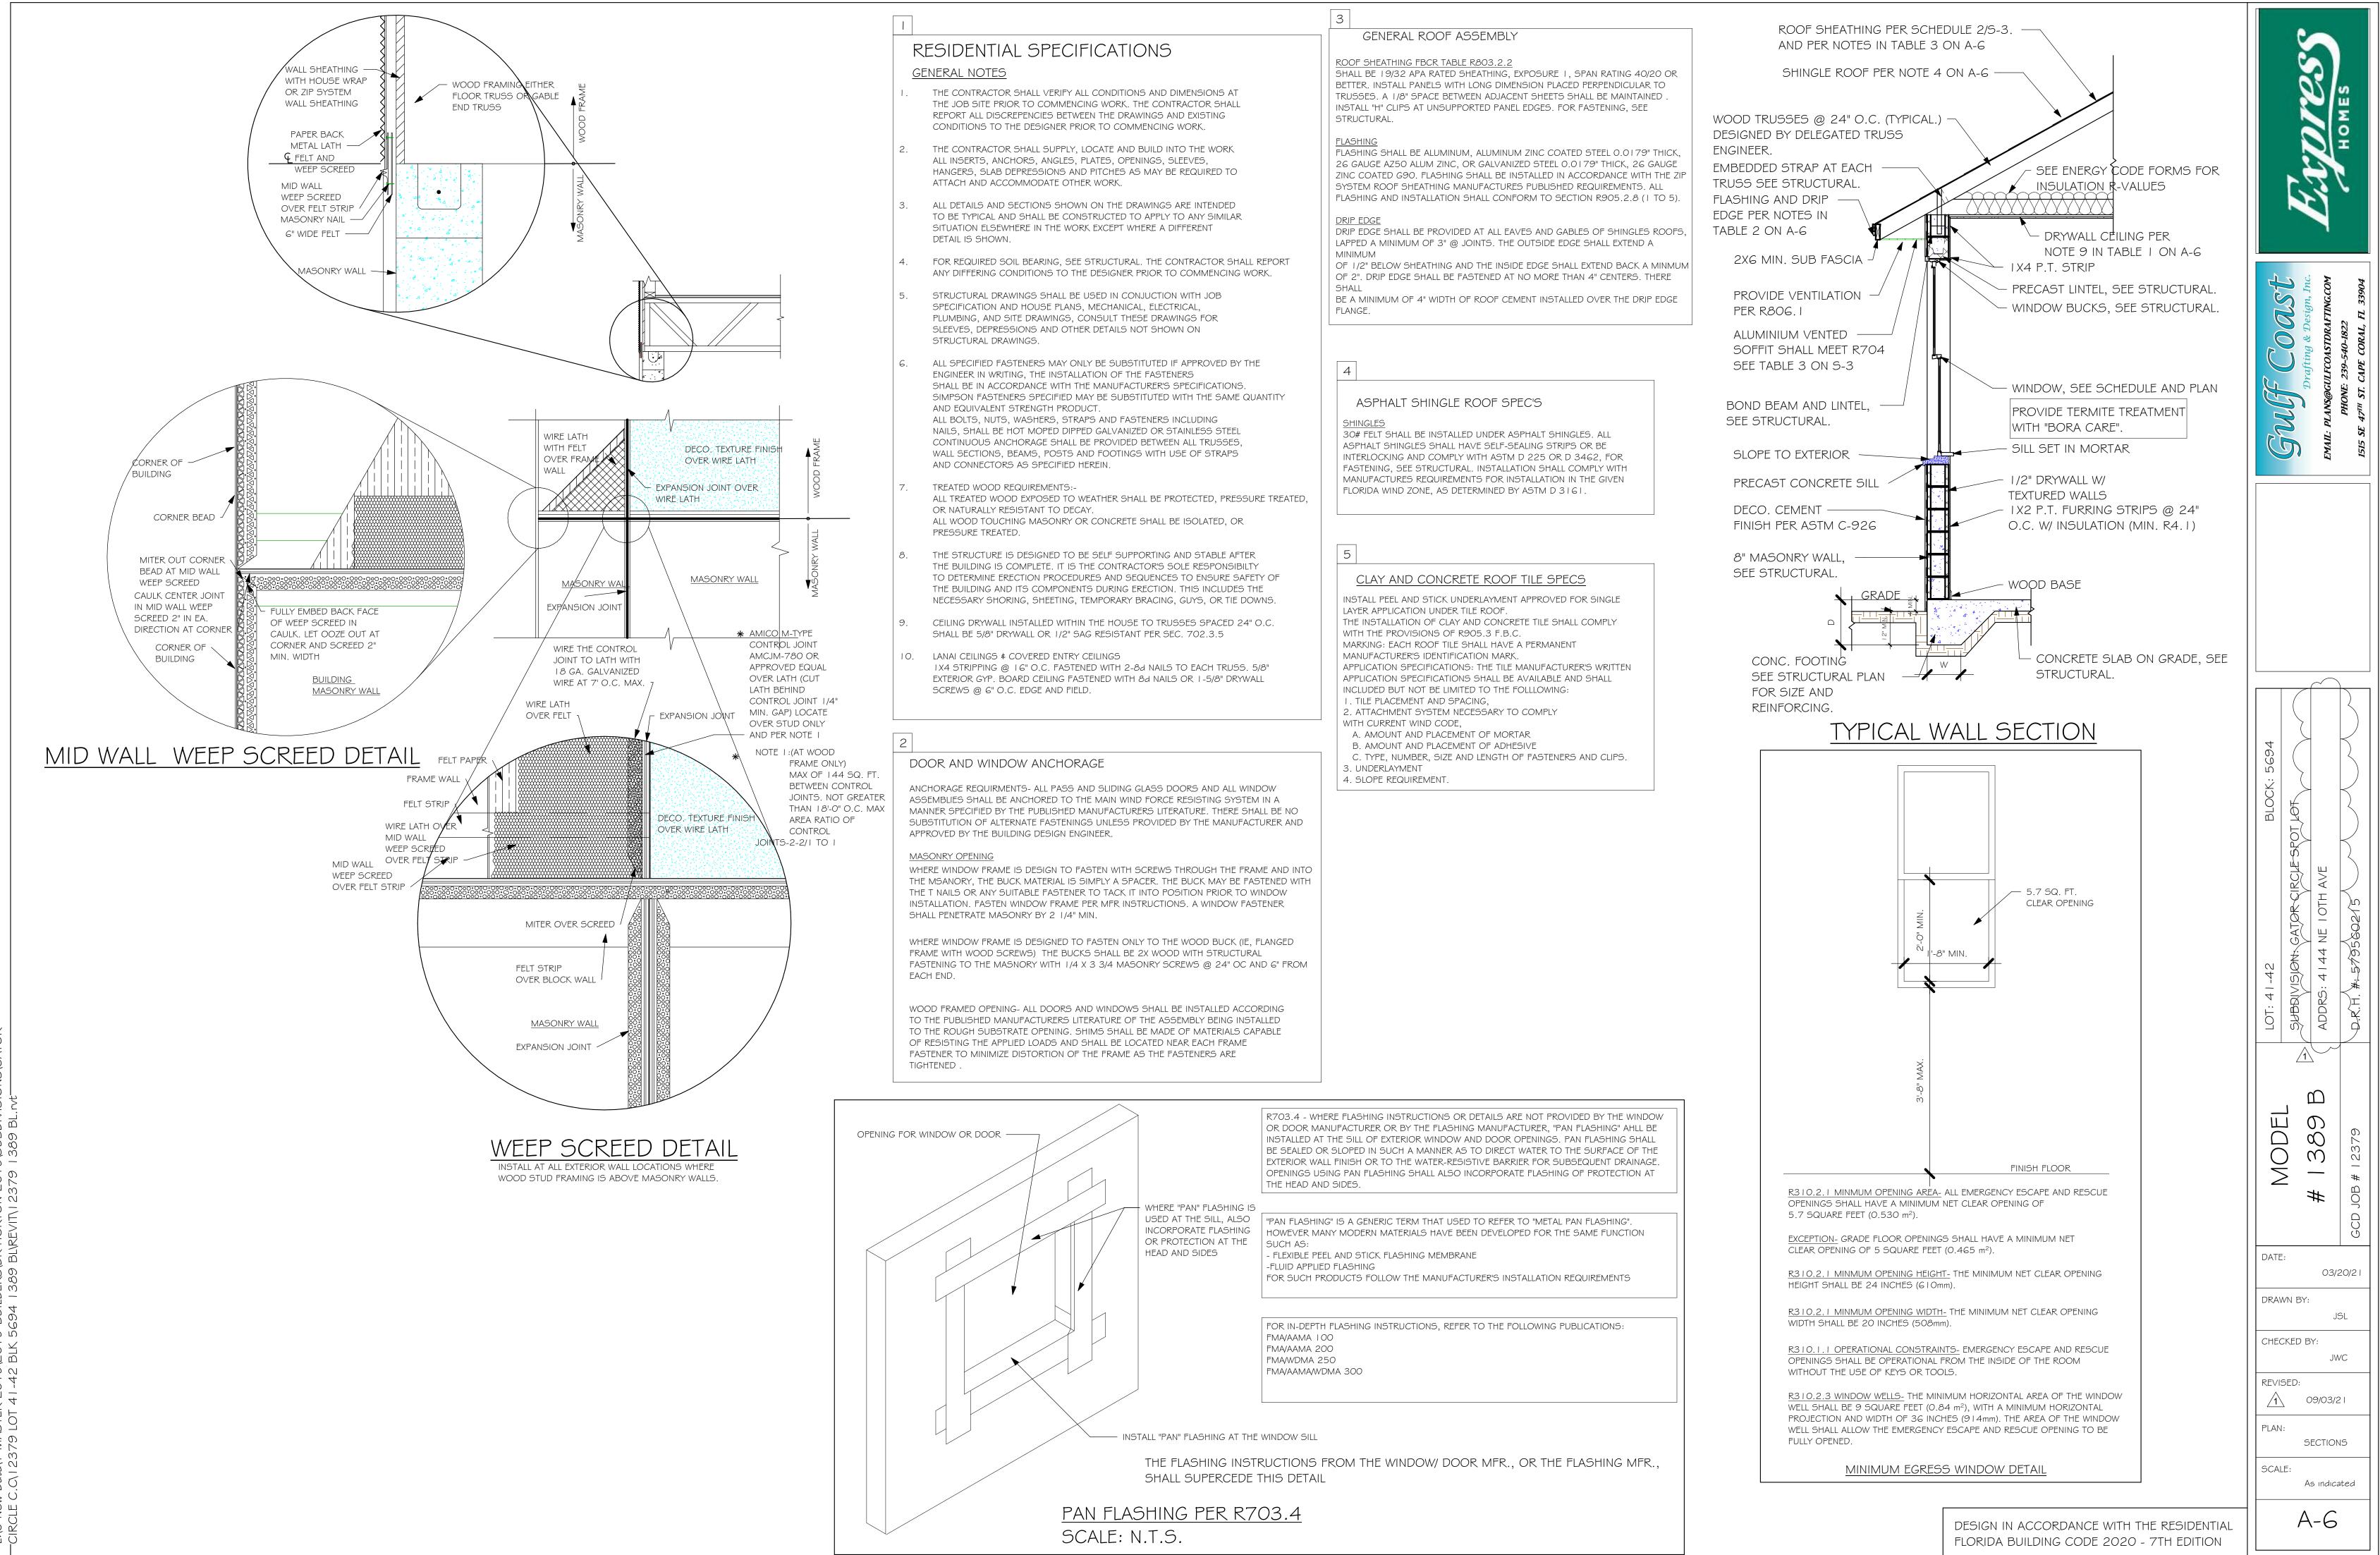


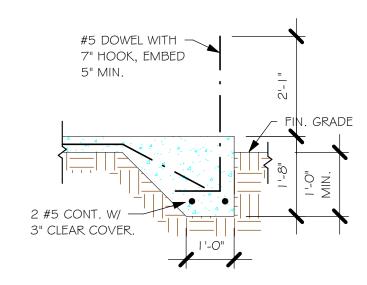


 $\frac{\text{"F3" FOOTING}}{1/2\text{"} = 1\text{'-0"}}$

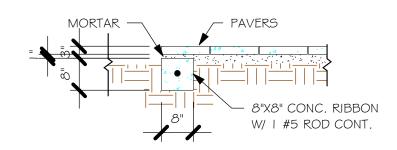


 $\frac{\text{"P" PAVERS DETAIL ENTRY/ LANAI}}{1/2" = 1'-0"}$

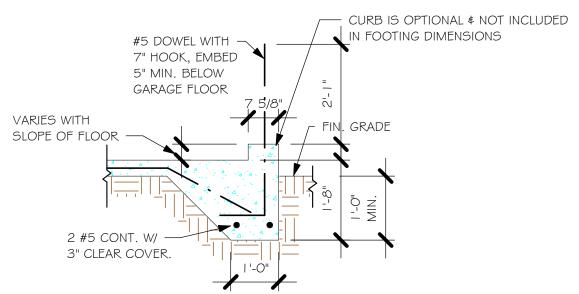

"F3" WITH CURB AT GARAGE $\frac{1}{2} = 1'-0$ "

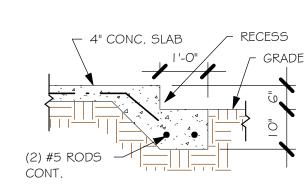

 $\frac{\text{GARAGE DOOR RECESS}}{1/2" = 1'-0"}$

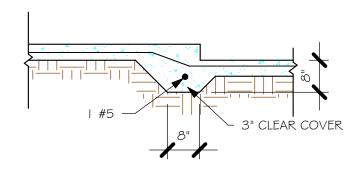

 $\frac{\text{"F6A" STEP DOWN}}{1/2\text{"} = 1\text{'-0"}}$

	PAD FOOTING SCHEDULE									
요	T\/DE	LENGTH	MOTI	DEDTIL	ВОТТ	TOM REINF.	DEMARKS			
USED	TYPE	LENGTH	WIDTH	DEPTH	LONG WAY	SHORT WAY	REMARKS			
X	$\langle \mathbf{A} \rangle$	2'-6"	2'-6"	1'-0"	3-#5	3-#5	-			
	$\langle \mathbf{B} \rangle$	3'-0"	3'-0"	1'-0"	4-#5	4-#5	-			
	(C)	3'-6"	3'-6"	1'-0"	4-#5	4-#5	-			
	(D)	4'-0"	4'-0"	1'-2"	5-#5	5-#5	-			
	(E)	5'-0"	5'-0"	1'-2"	6-#5	6-#5	-			


	WALL FOOTING SCHEDULE								
USED	TYPE	LENGTH	WIDTH	DEPTH	BOTTOM REINFORCING	SHAPE			
	F1	CONT.	1'-4"	0'-8"	2-#5				
	F2	CONT.	1'-8"	0'-10"	2-#5				
X	F3	CONT.	1'-0"	1'-8"	2-#5	₩	ADD CURE GARAGE, DETAIL		
	F4	CONT.	1'-4"	1'-8"	2-#5		DETAIL		
	F5	CONT.	1'-4"	1'-0"	2-#5	—			
	F6	CONT.	1'-4"	1'-0"	2-#5				
X	F6A	CONT.	0'-8"	0'-8"	1-#5	-			
	TE	CONT.	0'-8"	0'-8"	1-#5	F			

PROVIDE CORNER BARS PER 6/S-3



SCALE: 1/4" = 1'-0"


- PLAN NOTES:
 1. TOP OF GROUND FLOOR SLAB DATUM ELEVATION 0'-0"
- 2. "F#" DENOTES CONTINUOUS WALL FOOTING TYPE PER SCHEDULE THIS SHEET.
- PROVIDE #5 VERTICAL REINFORCING AT DOT LOCATIONS SHOWN ON PLAN FROM FOOTING TO BOND BEAM.
 ALL DIMENSIONS ARE TO OUTSIDE FACE OF MASONRY WALLS. SOME SLAB EDGES MAY
- EXTEND BEYOND FACE OF WALL.
 FOR DIMENSIONS OF ROUGH OPENINGS IN MASONRY WALLS, COORDINATE WITH WINDOW/
- DOOR SUPPLIER.
 6. PROVIDE PRESSURE TREATED BUCKS AT WINDOWS/ DOORS PER DETAIL 7/S-3.

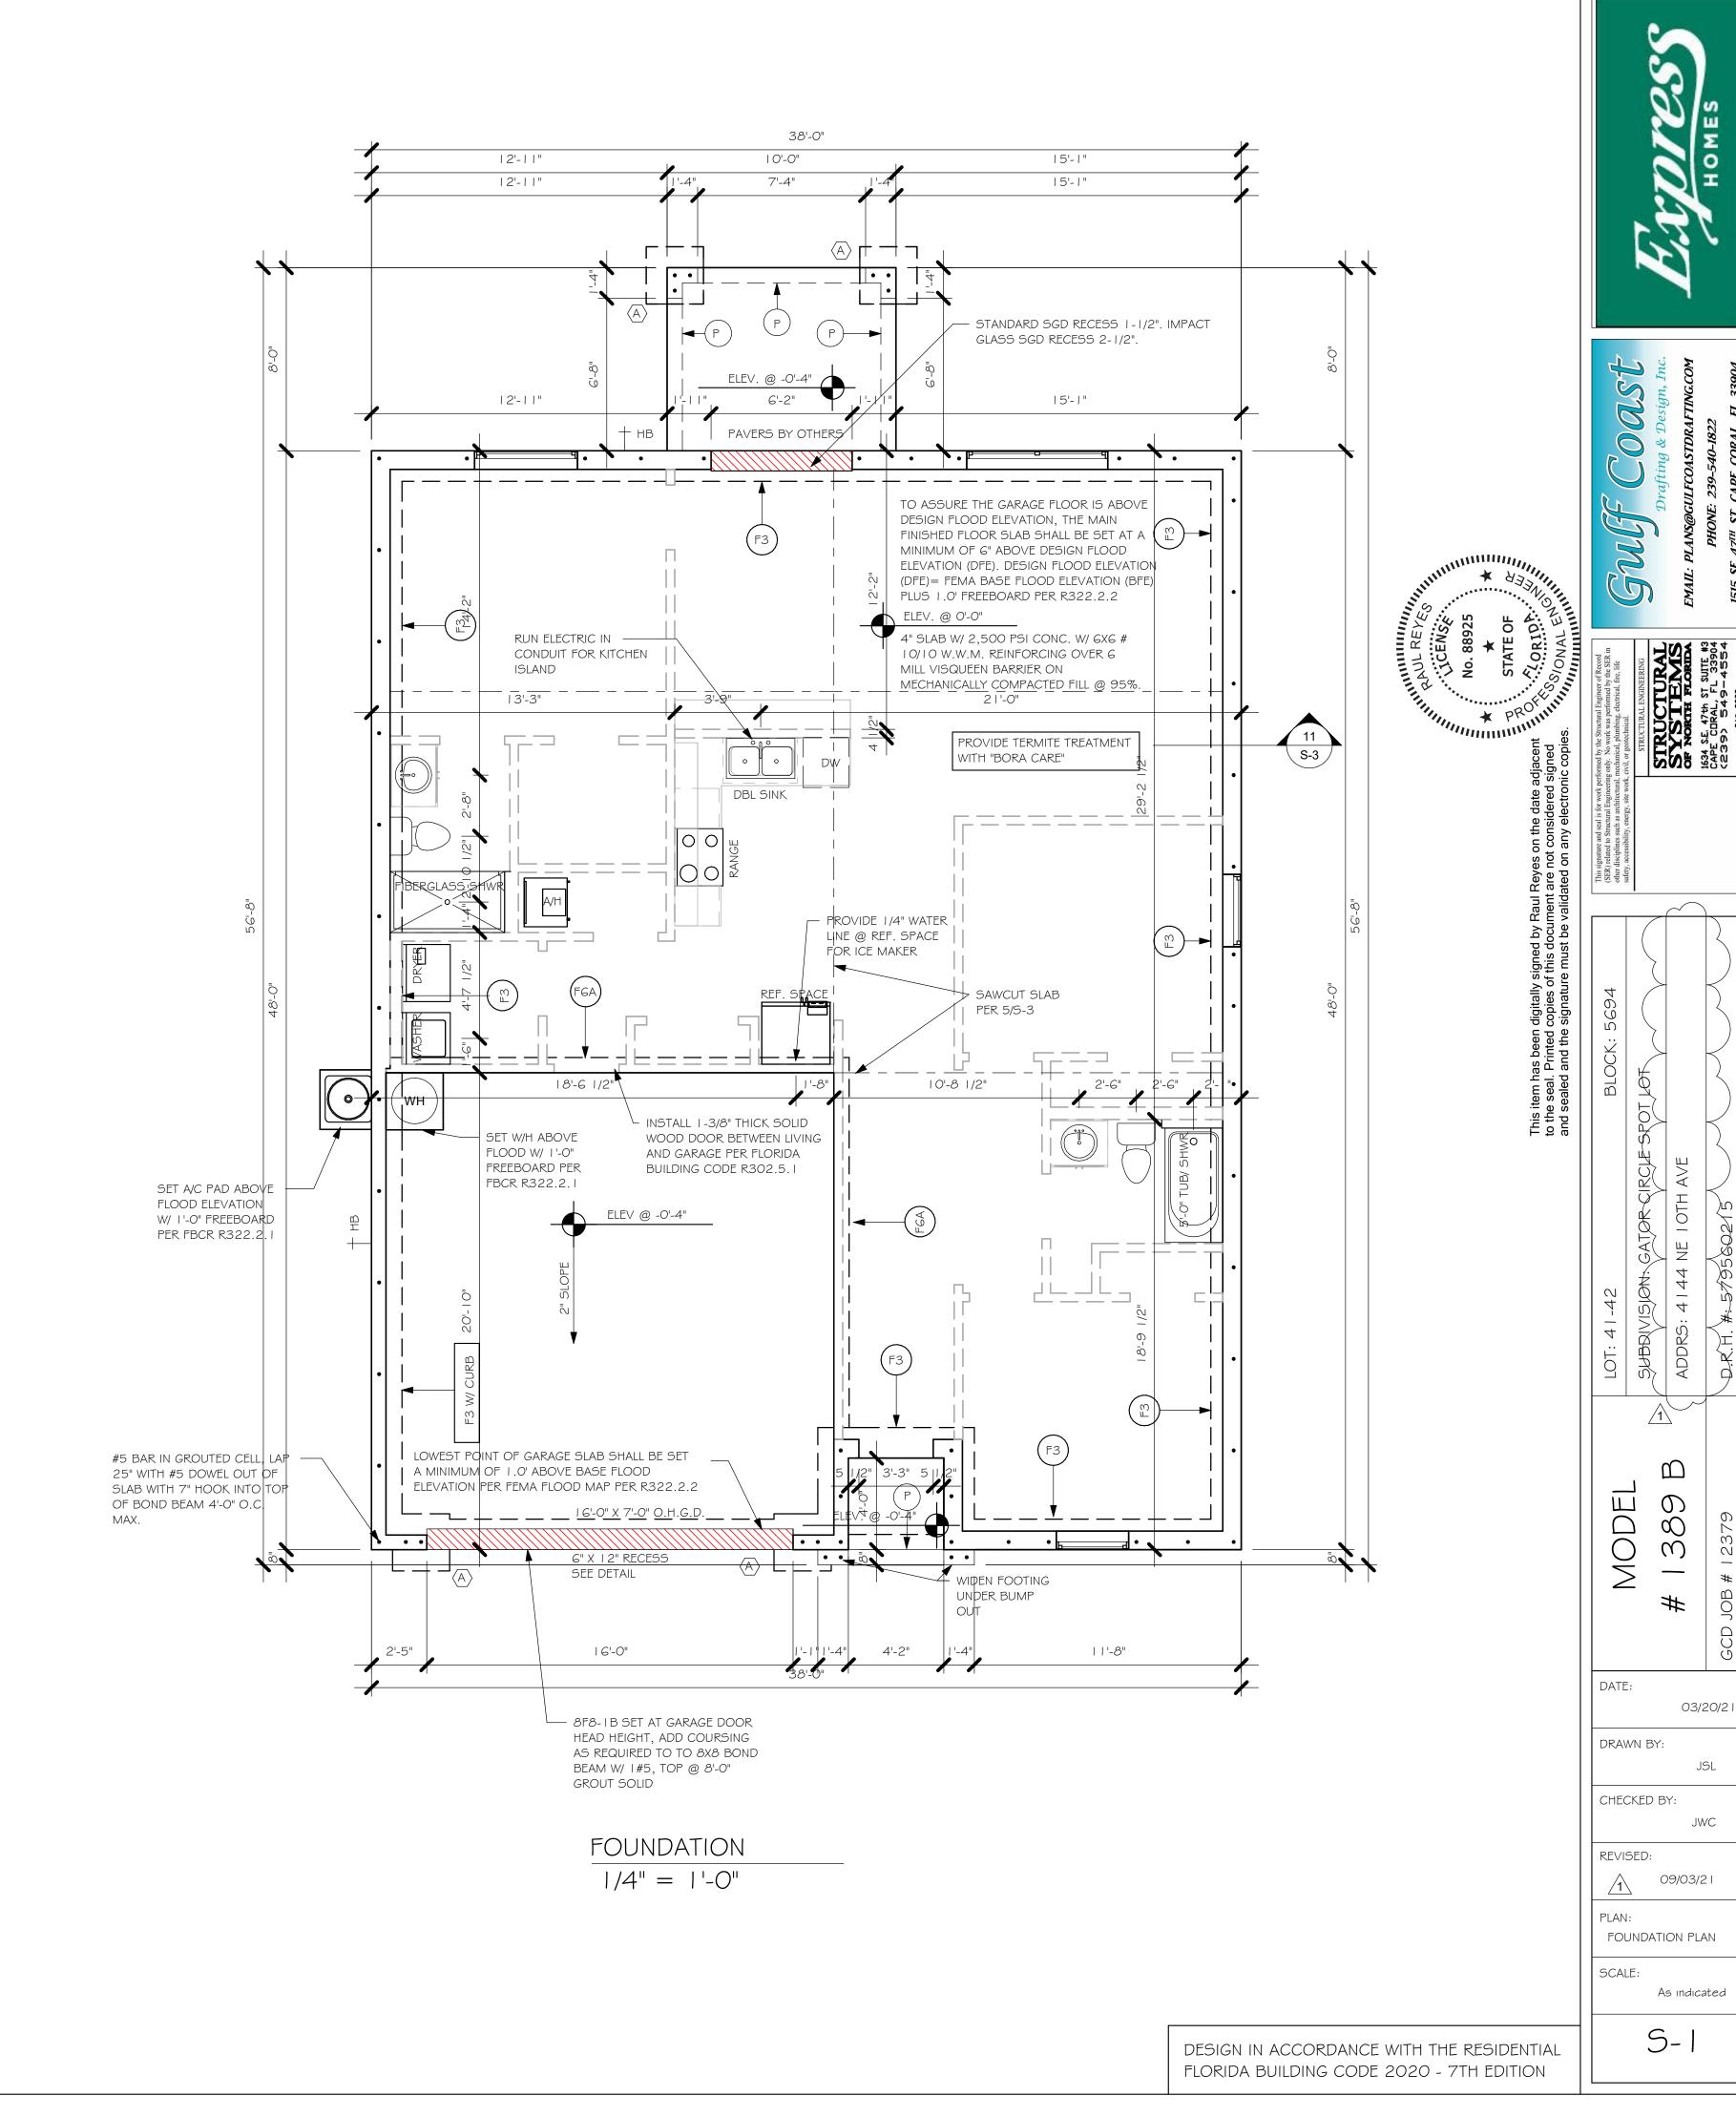

I. PROVIDE A STRAP FROM THE ABOVE LIST AT EACH ROOF TRUSS BEARING POINT, BASED ON THE TRUSS UPLIFT VALUES IN THE SIGNED AND SEALED TRUSS DESIGN PACKAGE AND SUITABLE FOR THE GEOMETRY. EMBED STRAP ON CENTERLINE OF WALL.

- CONNECTORS ARE SIMPSON STRUCTURAL CONNECTORS. ALL CONNECTORS SHALL BE INSTALLED IN STRICT ACCORDANCE WITH SIMPSON PRINTED INSTUCTIONS.
- SUBSTITUTIONS MUST BE APPROVED IN WRITING BY THE ENGINEER OF RECORD. WHERE EMBEDDED STRAPS ARE MISSING, OR MIS-LOCATED, INSTALL RETROFIT STRAP PER 10/5-3.

SIMPSON CATALOG C-C- 2019

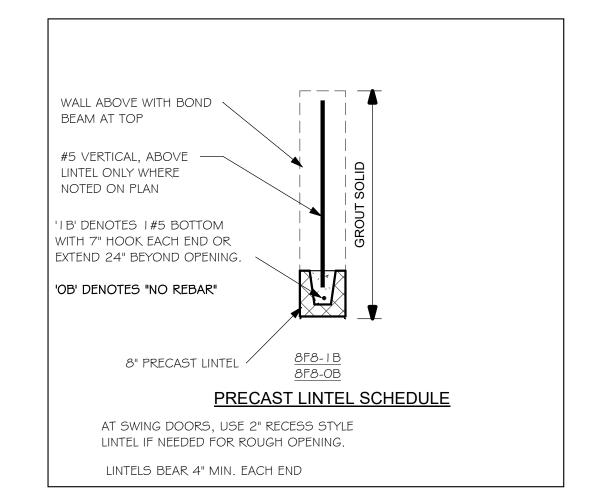


PLAN NOTES:


- ROOF TRUSS BEARING @ 8'-0".
- ROOF FRAMING SHALL BE WOOD TRUSSES DESIGNED BYA DELEGATED TRUSS ENGINEER PER DESIGN CRITERIA ON SHEET S-3.
- PROVIDE STRAPPING AT TRUSSES PER NOTES ON THIS
- SHEET. FOR NAILING OF ROOF AND FLOOR DECK, SEE | AND 2
- ON S-3. 8F8-1B etc., DENOTES PRECAST LINTEL ABOVE
- DOORWINDOW OPENING PER SCHEDULE THIS SHEET.
- AT TRUSS BEARING, PROVIDE 8x8 MASONRY BOND BEAM W/ I #5 CONTINUOUS, SEE DETAIL I I/S-3.

BEARING HEIGHT

= BEARING @ 8'-0"

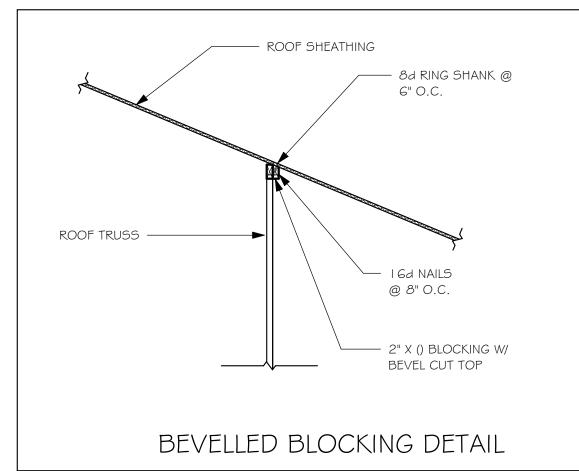

TRUSS BEARING CONDITIONS AND STRAPPING IS BASED ON TRUSS LAYOUT PREPARED BY SCOSTA JOB#: DR | 389BL DATED: | 1/30/20 REVISED: NONE

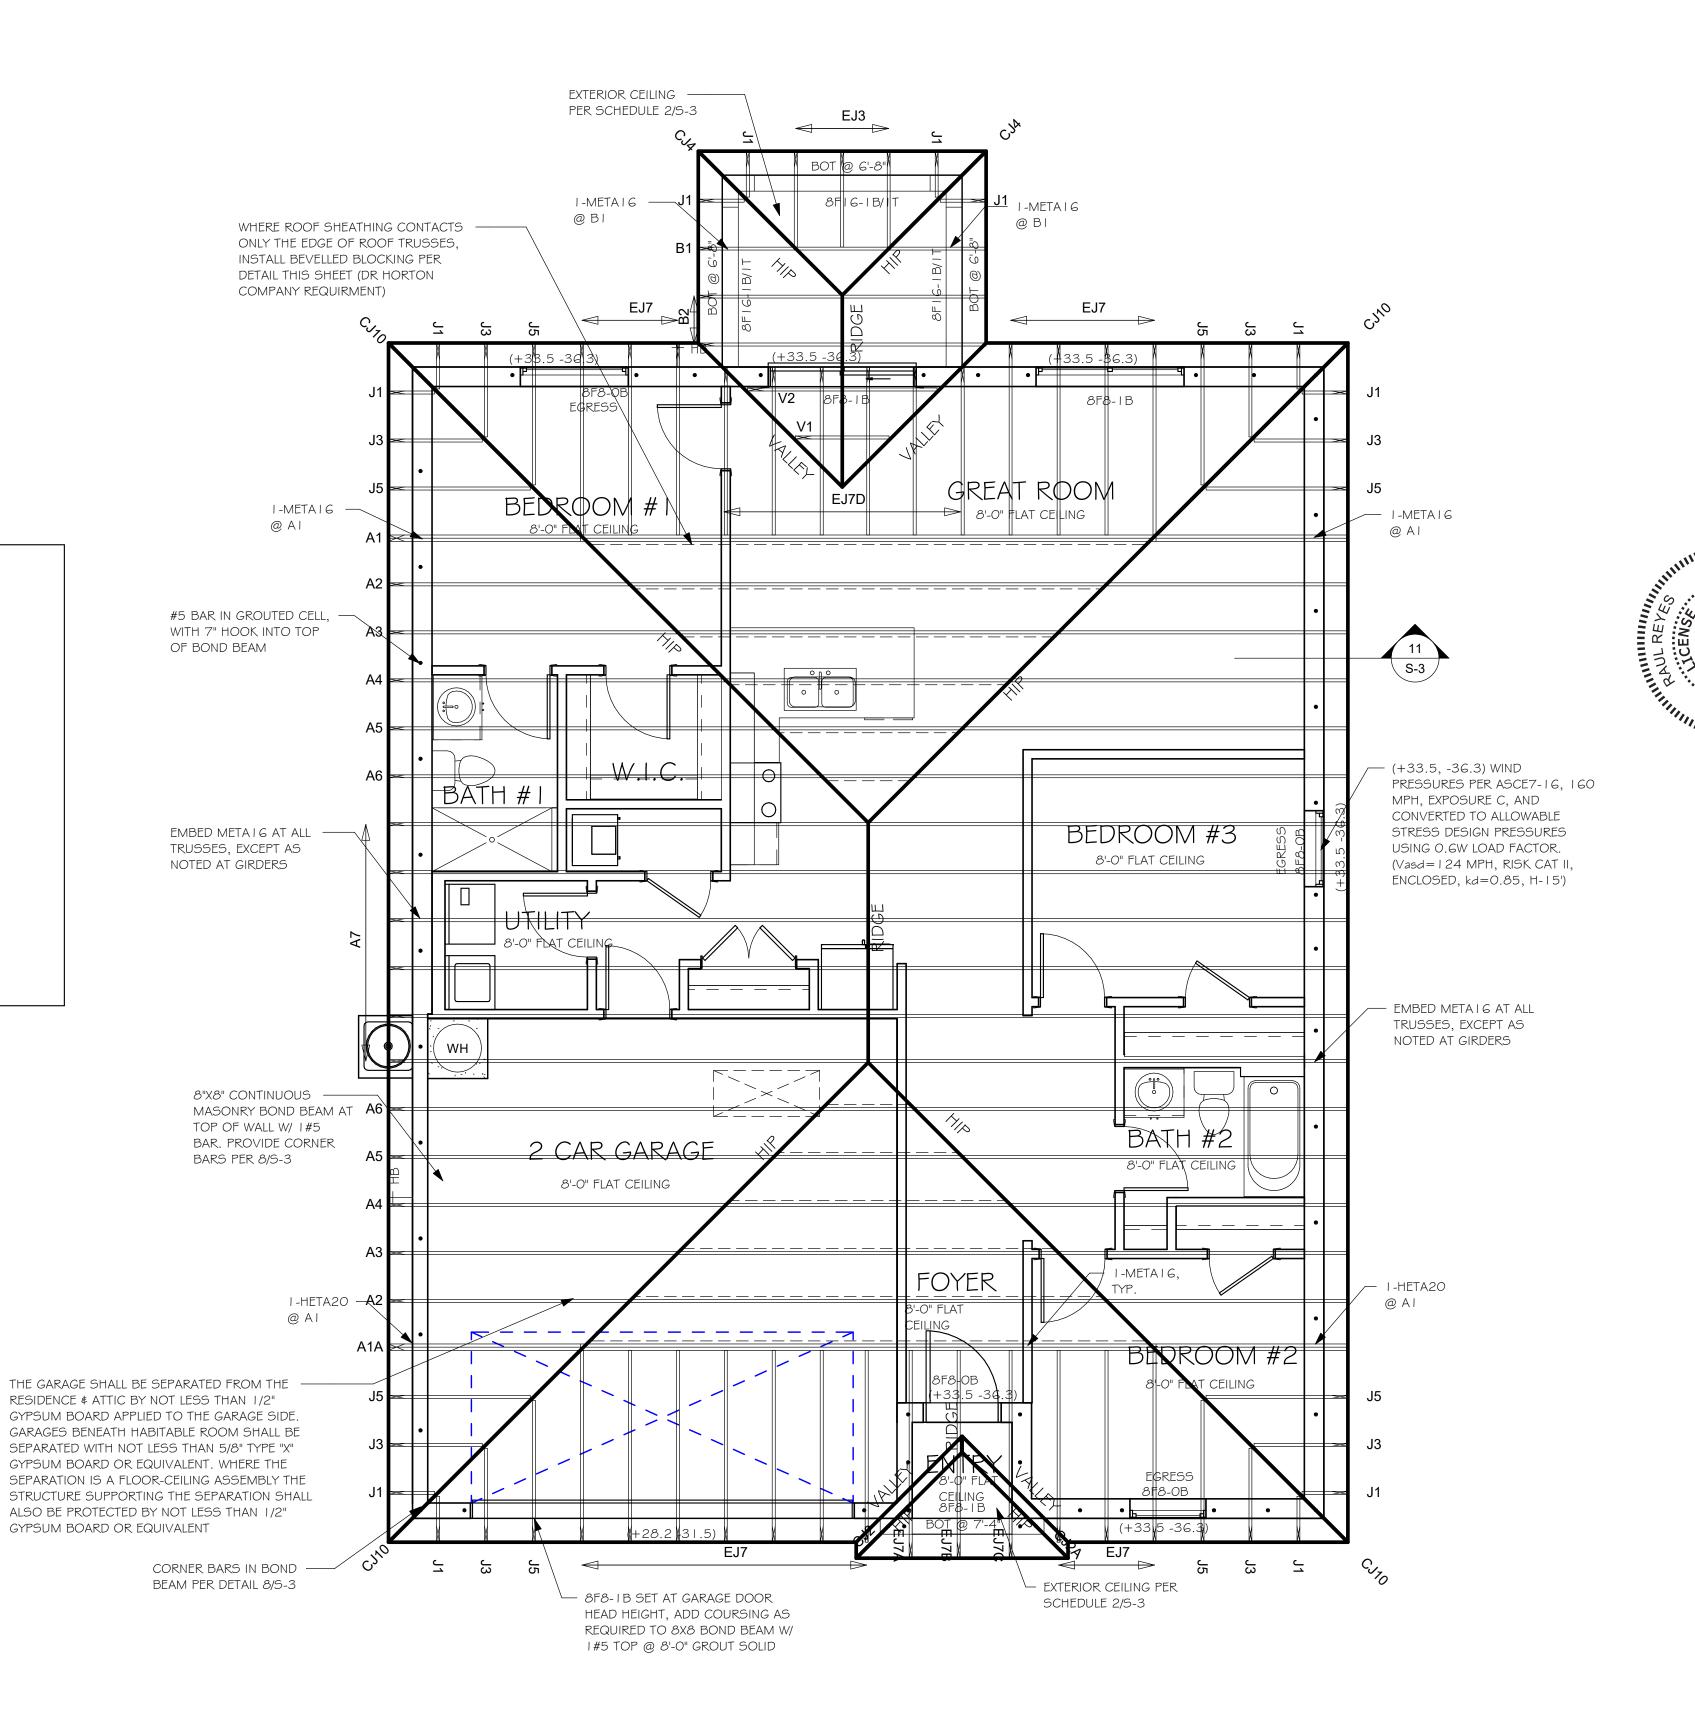

ROOF FRAMING PLAN 1/4" = 1'-0"

> DESIGN IN ACCORDANCE WITH THE RESIDENTIAL FLORIDA BUILDING CODE 2020 - 7TH EDITION

09/03/21 PLAN: ROOF FRAMING PLAN

As indicated

SCALE:

日

MOD

DATE:

DRAWN BY:

CHECKED BY:


REVISED:

38

03/20/21

JSL

JWC

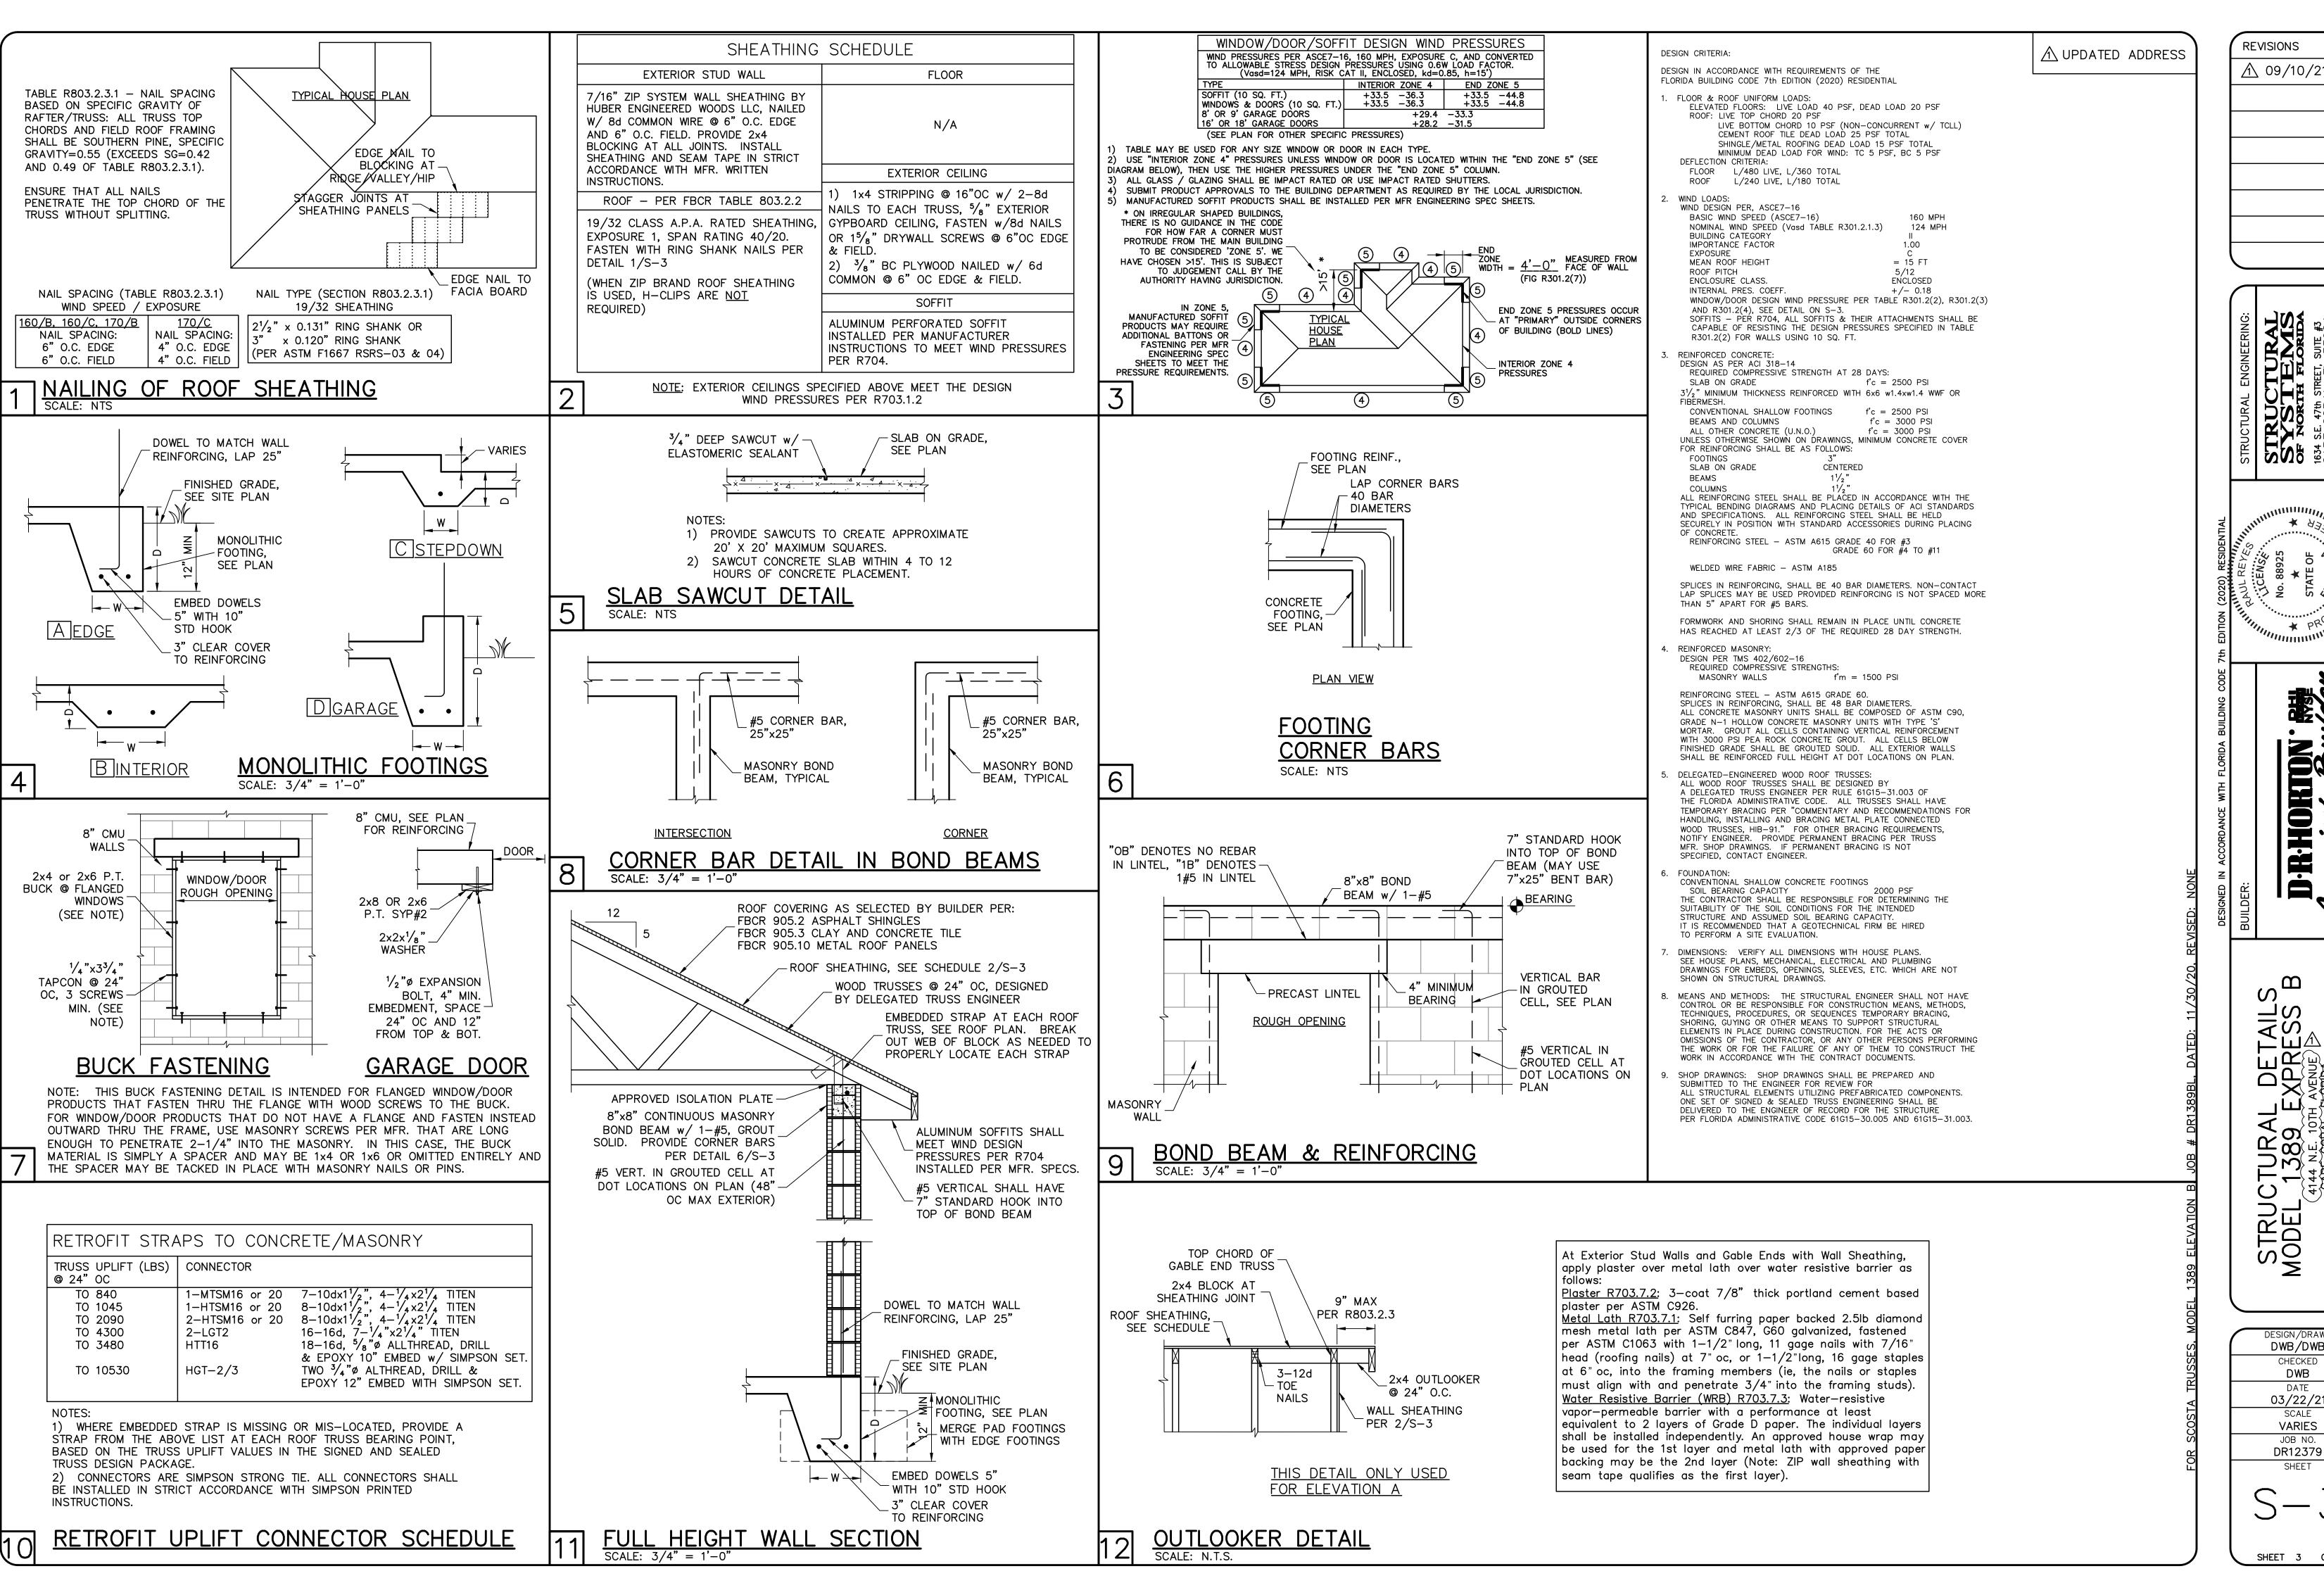

REVISIONS <u>/1</u>\ 09/10/21| RR

OKTON D-R-H

APL 389 4 N.E. 10T PE CORAL. \circ

DESIGN/DRAWN DWB/DWB CHECKED DWB 03/22/21 SCALE **VARIES** JOB NO.

SHEET

SHEET 3 OF 3