



36" MAX.

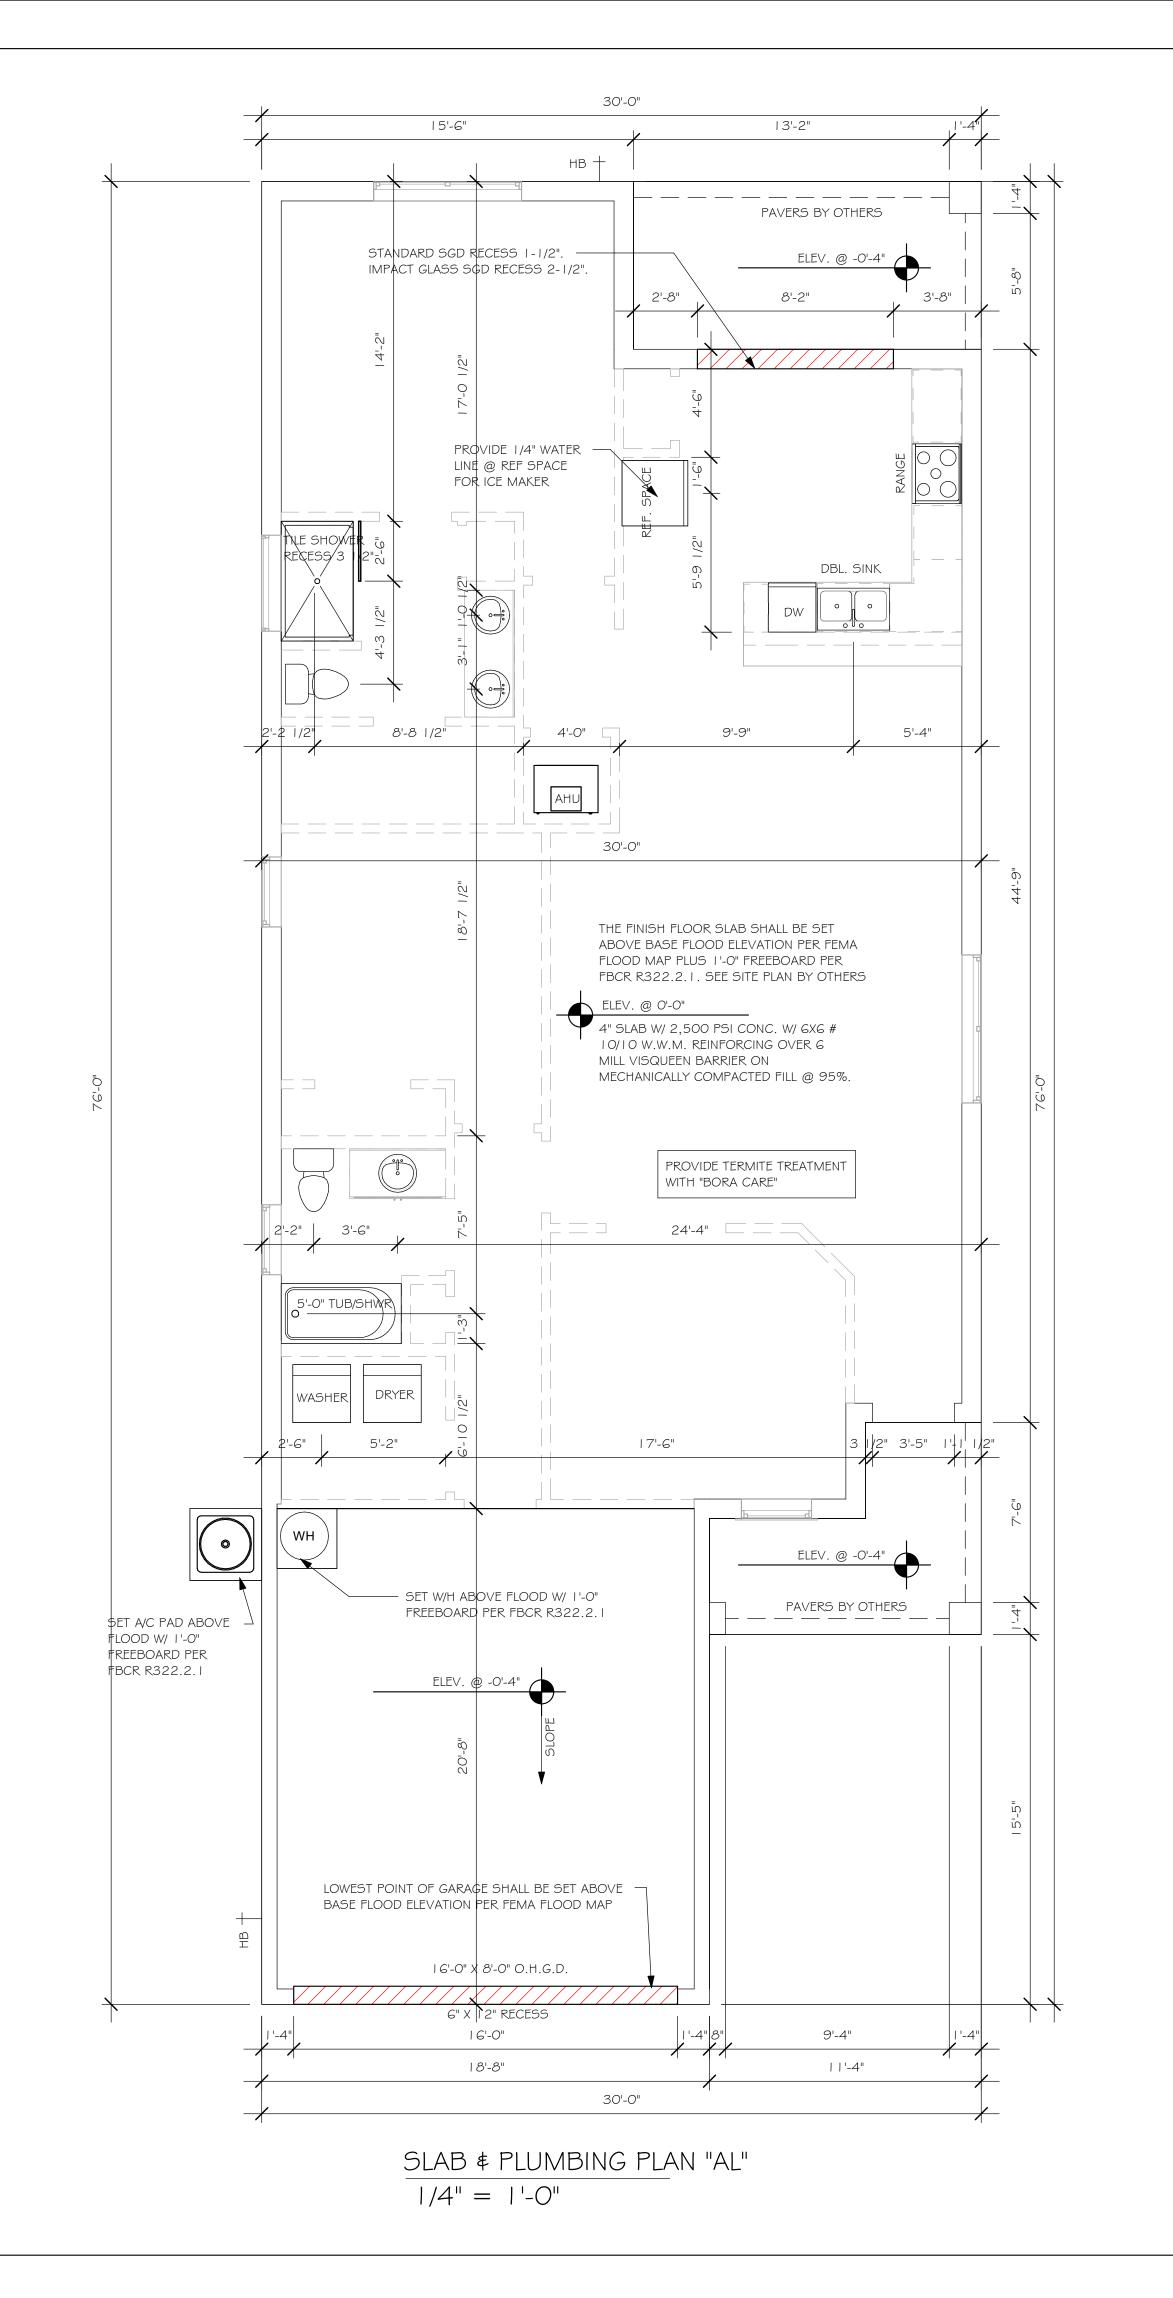

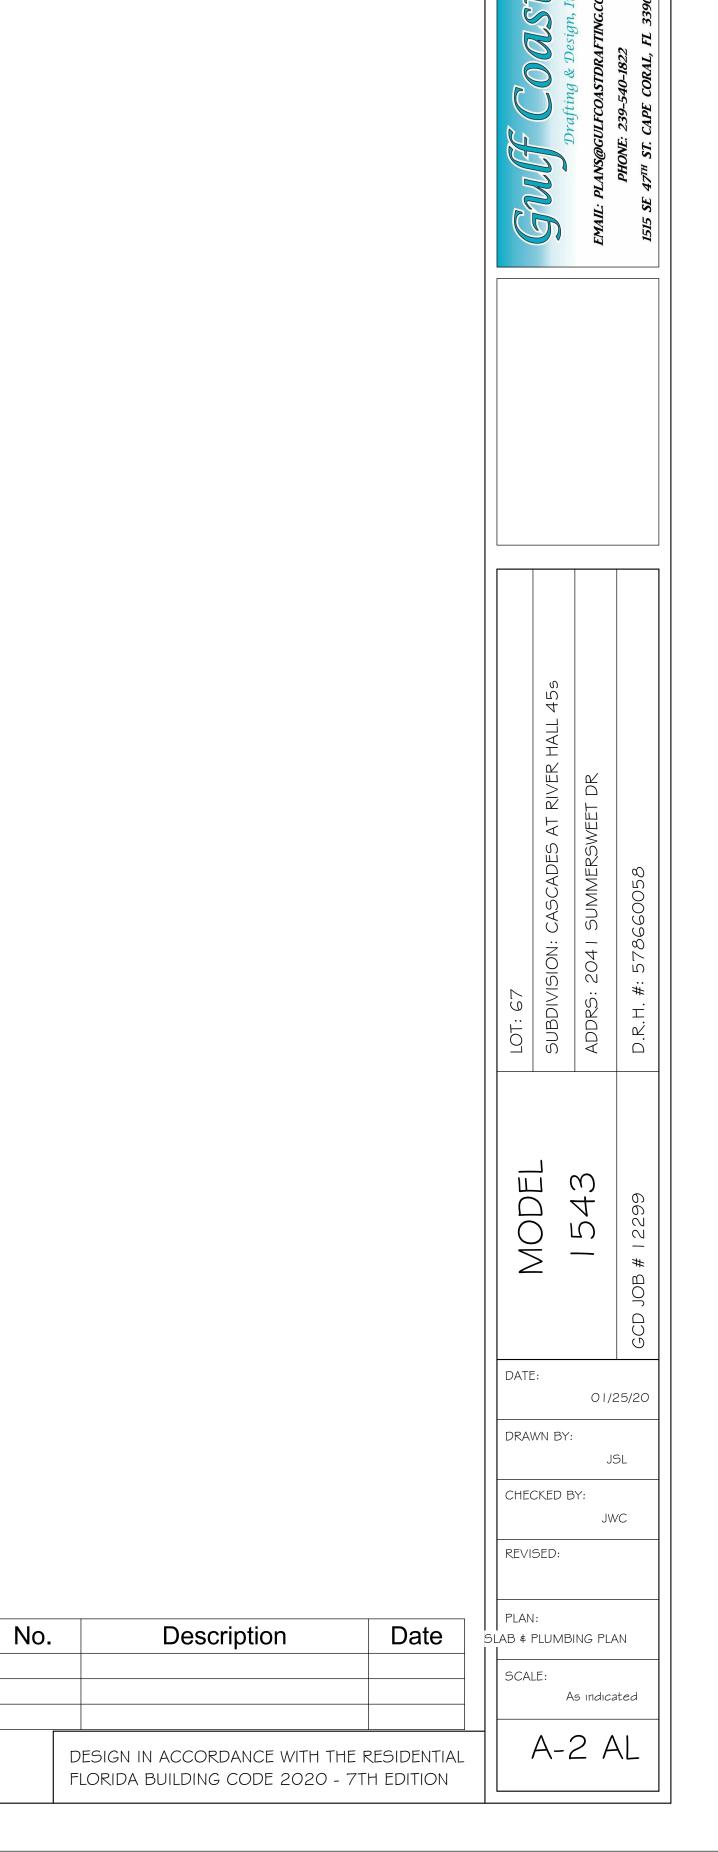





		16080 OHGD	GARAGE DOOR	8'-0"	16'-0"		
	2/	V 3080 EMTRY V	~ \ \ \ \ \	8'-01	3/-0	$\bigvee \qquad \bigvee$	
(	3	2-4080 SL. GL. DR.		8'-0"	8'-0"	IMPACT	1
	1				1	1	

	WINDOW SCHEDULE								
		DESCRIPTIO							
	MARK	M	MANUFACTURER	HEIGHT	WIDTH	COMMENTS	QTY		
1	r	' '	, ,	'	, ,	'	r r	1	
	Α	25 SH		5'-1"	2'-11"	IMPACT	2		
	В	23 SH		3'-0"	2'-11"	IMPACT			
_	С	2-25 SH		5'-1"	6'-2"	IMPACT	2		
	D	48" X 12"	FIXED GLASS	I '-O"	4'-0"	IMPACT			
7	[ J		, , , , , , , , , , , , , , , , , , ,	۱ ،	, , , , , , , , , , , , , , , , , , ,	,			

OPT-IMPRACT GLASS MAY BE INSTALLED IN LIEU OF SHUTTERS VERIFY WI CONTRACT

## DOOR HEADERS

6'-8" BI-FOLD	HEADER HEIGHT	82" A.F.F.
6'-8" SWING	HEADER HEIGHT	82 I/2" A.F.F.
8'-0" SWING	HEADER HEIGHT	98 I/2" A.F.F.

## PLAN NOTES

- VERIFY ALL ROUGH OPENING DIMENSIONS FOR ALL WINDOWS AND DOORS
- PROVIDE SAFETY GLAZING WITHIN 24" FROM EXIT PER FLORIDA BUILDING CODE R 308.4.2.
- PROVIDE SAFETY GLAZING AT BATH/ SHOWER PER FLORIDA BUILDING CODE R 308.4.5.
- NON BEARING INTERIOR FRAME WALLS SHALL BE FRAMED W/ WOOD OR METAL STUDS. SPACING SHALL NOT EXCEED 24" O.C. (NON BEARING WALLS ONLY)
- PROVIDE DEAD WOOD IN ATTIC FOR OVERHEAD GARAGE DOOR HARDWARE
- KITCHEN KNEE WALL TO BE FRAMED W/ TOP @ 34 I/2" A.F.F.
- INSTALL SMOOTH WALLS IN KITCHEN AND ALL BATHROOM AREAS
- WHERE DRYWALL CEILING IS APPLIED TO TRUSSES @ 24" O.C. USE 5/8" DRYWALL OR 1/2" SAG RESISTANT PER SEC. R702.3.5
- THE GARAGE SHALL BE SEPARATED FROM THE RESIDENCE \$ ATTIC BY NOT LESS THEN 1/2" GYPSUM BOARD APPLIED TO THE GARAGE SIDE. GARAGES BENEATH HABITABLE ROOMS SHALL BE SEPARATED WITH NOT LESS THAN 5/8" TYPE "X" GYPSUM BOARD OR EQUIVALENT. WHERE THE SEPARATIION IS A FLOOR - CEILING ASSEMBLY, THE STRUCTURE SUPPORTING THE SEPARTION SHALL ALSO BE PROTECTED BY NOT LESS THAN 1/2" GYPSOM BOARD OR EQUIVALENT
- 10) INSTALL 1 3/8" THICK SOLID WOOD DOOR BETWEEN LIVING AND GARAGE PER FLORIDA BUILDING CODE
- 11) ALL WINDOWS INSTALLED 72" ABOVE GRADE MUST COMPLY WITH R6 | 2.2 MIN 24" SILL HEIGHT OR PROVIDED WITH AN APPROVED WINDOW FALL PRVENTION DEVICE
- 12) ALL CLOSET SHELVES TO BE 12". ALL PANTRY \$ LINEN TO BE (4)-16" SHELVES 18" O.F.F. W/ 15"
- 13) ALL MECHANICAL AND ELECTRICAL EQUIPMENT TO BE INSTALLED AT OR ABOVE FLOOD PLUS 1'-0" FREEBOARD.

CA	BINET	BACK	ING
		D 0 0 411	5465

KITCHEN	UPPER TOP @ 84"	BASE TOP @ 35"
MASTER BATH	UPPER	BASE TOP @ 35"
GUEST BATH	UPPER	BASE TOP @ 31"
LAUNDRY ROOM	UPPER TOP @ 84"	BASE


## SQUARE FOOTAGE

ANAI AREA	102 SF
IVING AREA	1544 SF
GARAGE AREA	383 SF
ENTRY AREA	74 SF
OTAL AREA	2102 SF

INTERIOR DOOR SCHEDULE							
MARK	DOOR WIDTH	NOTES					
	3'-0"	P.K. = POCKET DOOR					
2	2'-10"	B.F. = BI-FOLD DOOR					
3	2'-8"	D.I. DITOLD DOOK					
4	2'-6"	B.P. = BI-PASS DOOR					
5	2'-4"	LV - LOUVERED DOOR					

MARK	DOOR WIDTH	NOTES
	3'-0"	P.K. = POCKET DOOR
2	2'-10"	B.F. = BI-FOLD DOOR
3	2'-8"	D.1 DI-1 OLD DOOK
4	2'-6"	B.P. = BI-PASS DOOR
5	2'-4"	L.V. = LOUVERED DOOR
6	2'-0"	
7	1'-8"	
8	1'-6"	

	BATHROOM NOTES
TB TOWEL BAR	ALL TUB DECKS @ 21" A.F.F
TP TOILET PAPER	ALL BLOCKING TO BE PT IN SHOWERS
4.0. <sub>1</sub>	TOWEL BAR  TOILET PAPER ROLL  A* 4* 4* MINMIN.

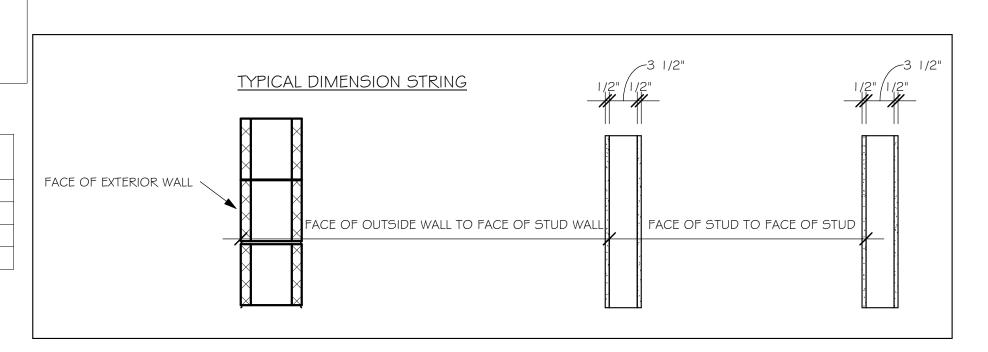

FLOOR PLAN "AL"

1/4" = 1'-0"

Description Date ADDED IMPACT WINDOWS AND 03/22/21 SLIDER DESIGN IN ACCORDANCE WITH THE RESIDENTIAL FLORIDA BUILDING CODE 2020 - 7TH EDITION

MODEL

DRAWN BY:

CHECKED BY:

REVISED:

SCALE:

01/25/20

03/22/21


FLOOR

As indicated

A-3 AL

30'-0" 15'-6" 14'-6" 10'-10" 13'-2" LANAI 9'-4" FLAT CEILING BEDROOM #1 8'-2" 9'-4" FLAT CEILING 15'-0 1/2" 12'-7 1/2" KITCHEN 9'-4" FLAT CEILING - FULL GLASS 9'-11" DBL. SINK 15'-1 1/2" 6" KNEE WALL -34 1/4" TALL NOOK 9'-4" FLAT CEILING 12" SHELF BEDROOM #2 9'-4" FLAT CEILING GREAT ROOM 9'-4" FLAT CEILING SEE NOTE 10 4'-3" 2'-3" 6" 3'-0" MIN. R-13 OR ----9'-4" FLAT CEILING BETTER INSULATION SEE NOTE 9 16'-0" 9'-4" 18'-8" 11'-4" 30'-0"

BEARING HEIGHT =BEARING @ 9'-4"

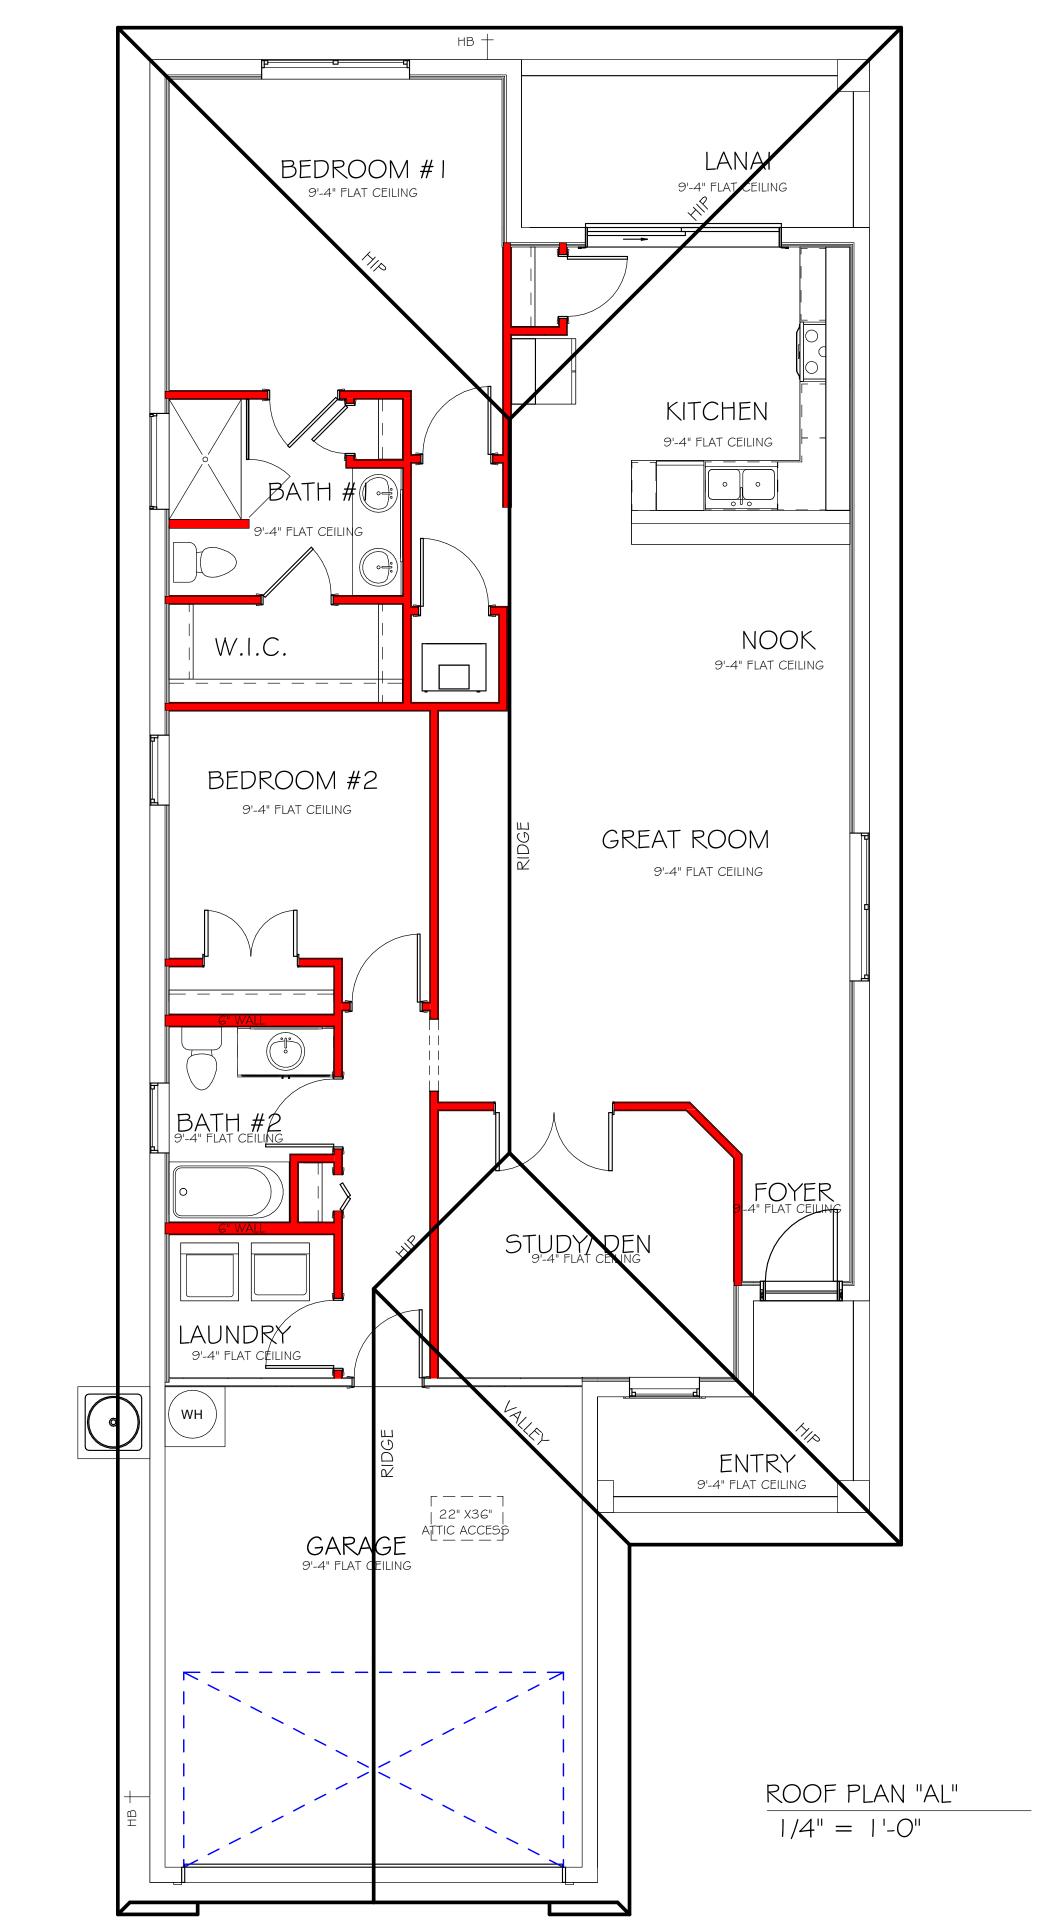

No. Description Date DESIGN IN ACCORDANCE WITH THE RESIDENTIAL FLORIDA BUILDING CODE 2020 - 7TH EDITION


MODEL DATE: 01/25/20 DRAWN BY: CHECKED BY: REVISED: ROOF SCALE: As indicated A-4 AL

ELECTRICAL LEGEND

ELECTRICAL METER


ELECTRICAL PANEL


1 20 V JUNCTION BOX

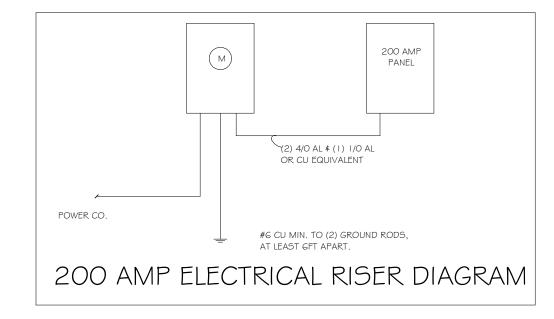



### ELECTRICAL PLAN 1543

200	AMP SERVICE	
TAG	QUANTITY	PRODUCT
Α	(11)	(FLUSH MOUNTED LT)
В	(1)	(VAPORS)
С	(3)	(PENDANT LIGHT
D	(8)	(10" MUSHROOMS)
E	(2)	(24" 3 LT)
F	(1)	(36" 4 LT)
G	(X)	(NOT USED)
Н	(2)	(COACH LIGHTS)
1	(X)	(COACH LIGHTS)
J	(1)	(J BOX)
K	(1)	(4' FLUORESCENT)
L	(X)	(2' FLUORESCENT)
М	(X)	(5LT CHANDELIER)
Ν	(X)	(3 LT)
0	(X)	(PENDANT/ NOOK)
Р	(X)	(X)
	(X)	(X)

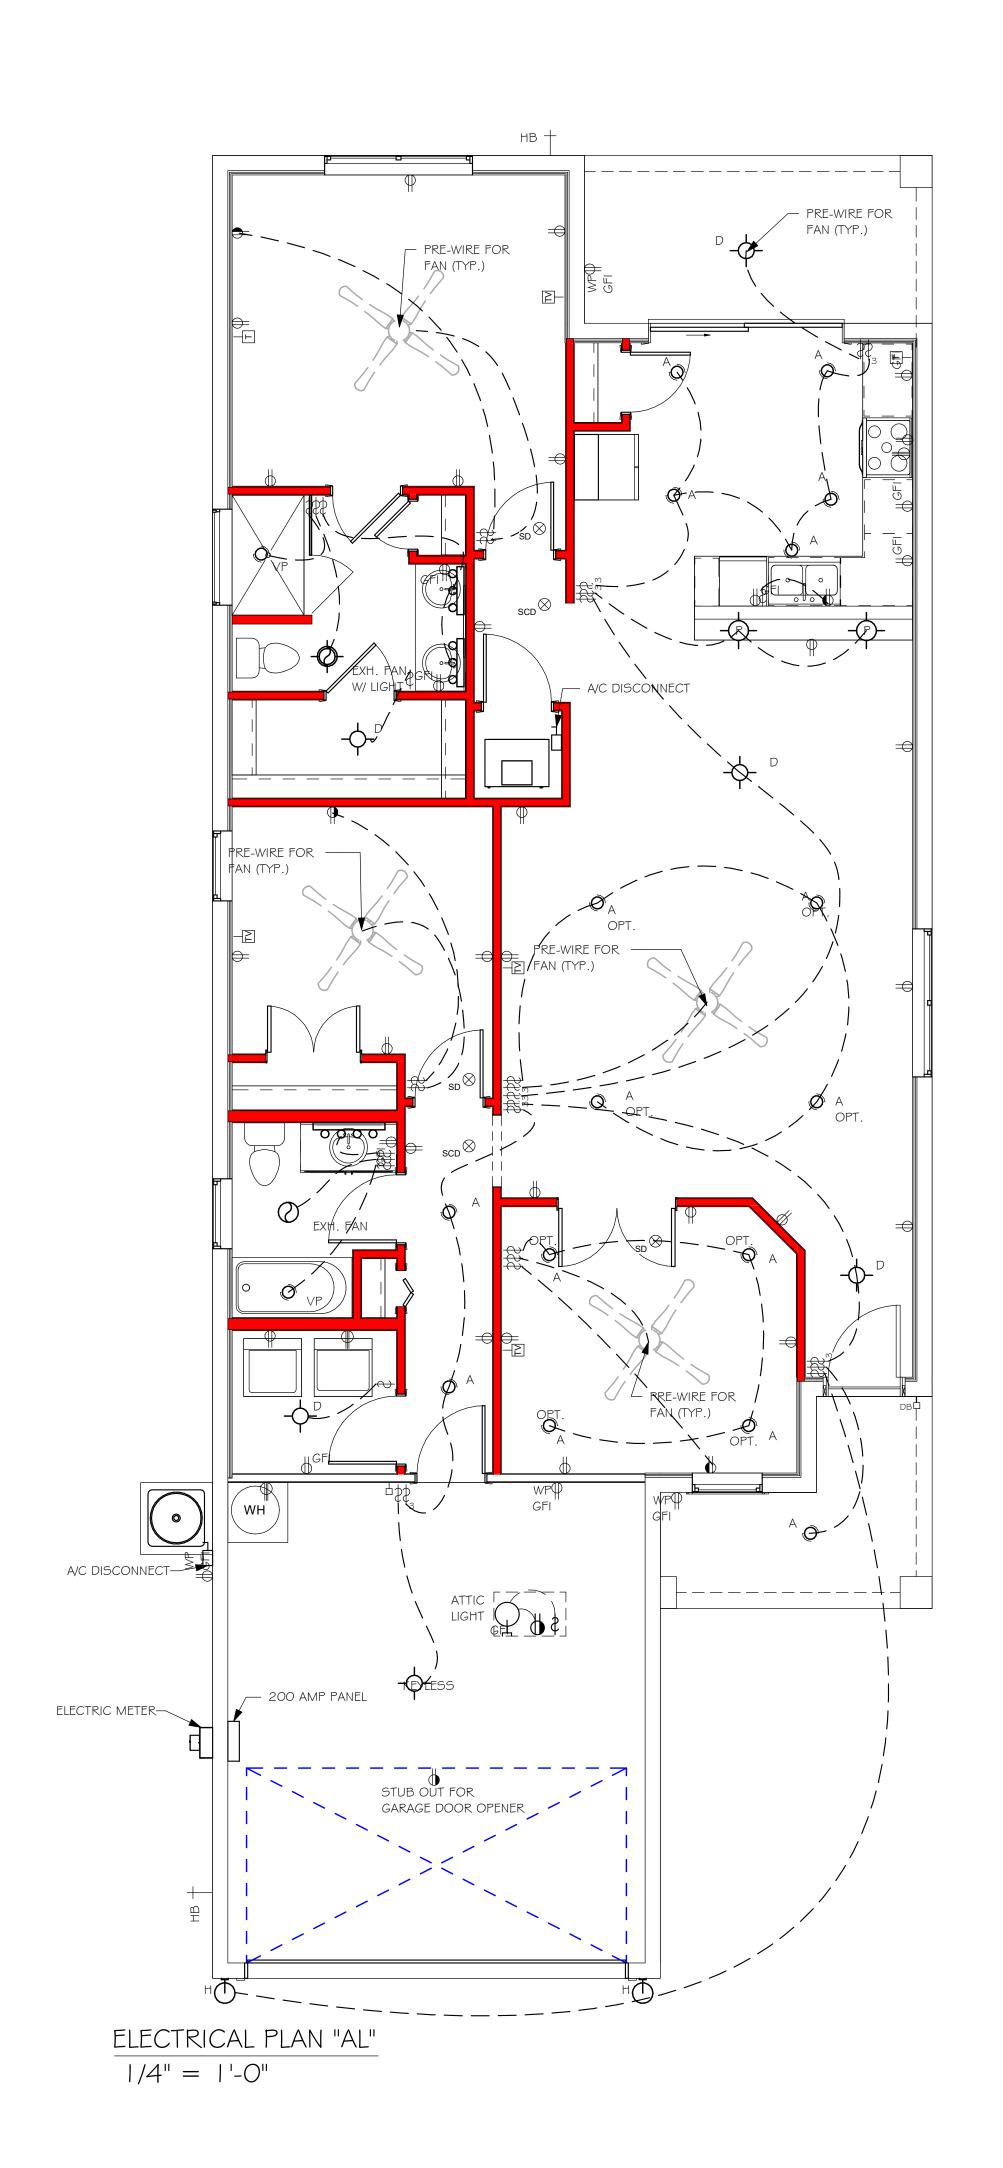

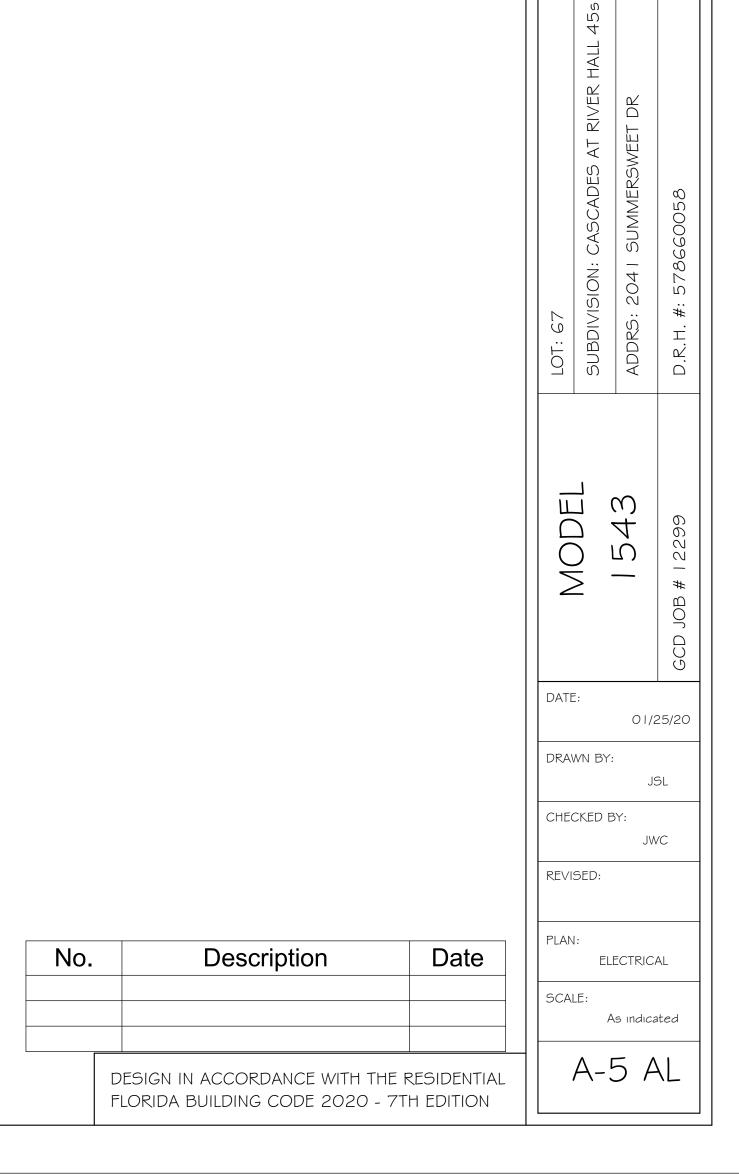

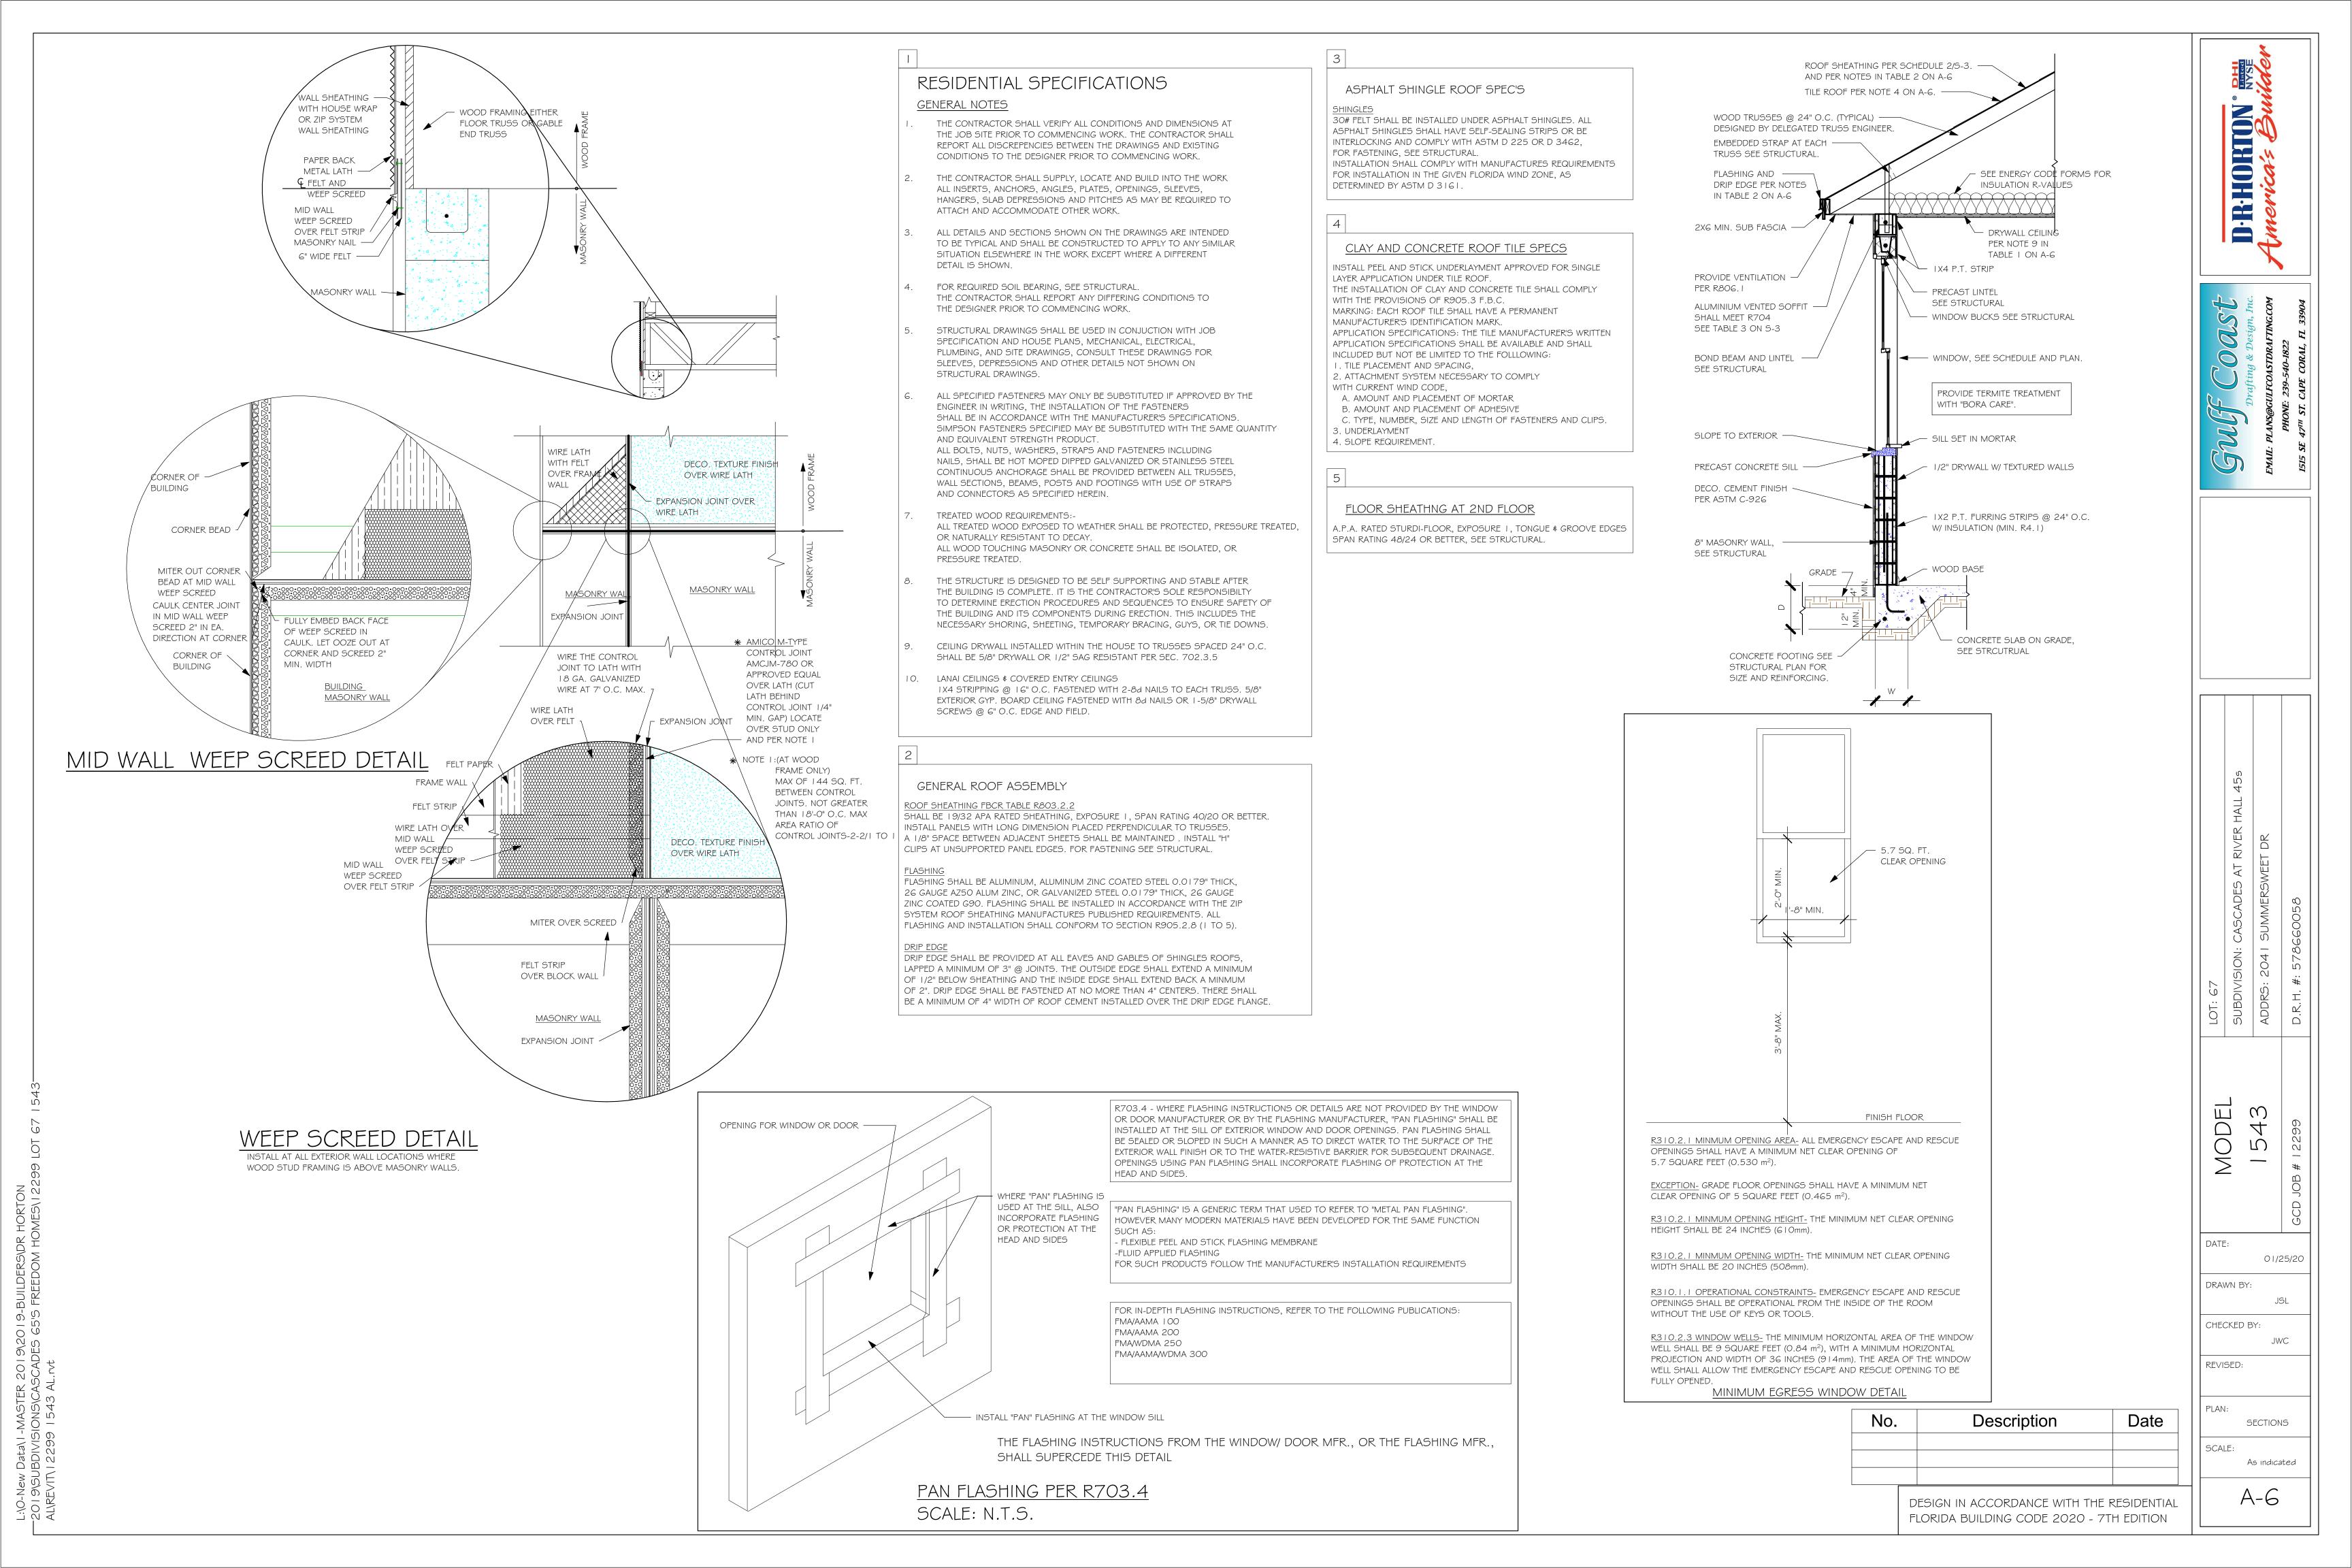

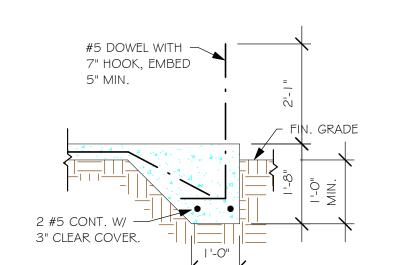

## **FOUNDATION PLAN**


### SCALE: 1/4" = 1'-0"

- PLAN NOTES:
- TOP OF GROUND FLOOR SLAB DATUM ELEVATION 0'-0"
  "F#" DENOTES CONTINUOUS WALL FOOTING TYPE PER SCHEDULE THIS SHEET
- "F#" DENOTES CONTINUOUS WALL FOOTING TYPE PER SCHEDULE THIS SHEET.
- 3. PROVIDE #5 VERTICAL REINFORCING AT DOT LOCATIONS SHOWN ON PLAN FROM FOOTING TO BOND BEAM.


FOR DIMENSIONS OF ROUGH OPENINGS IN MASONRY WALLS, COORDINATE WITH WINDOW/

- 4. ALL DIMENSIONS ARE TO OUTSIDE FACE OF MASONRY WALLS. SOME SLAB EDGES MAY EXTEND BEYOND FACE OF WALL.
- DOOR SUPPLIER.
  6. PROVIDE PRESSURE TREATED BUCKS AT WINDOWS/ DOORS PER DETAIL 7/S-3.


# "F3" FOOTING 1/2" = 1'-0"

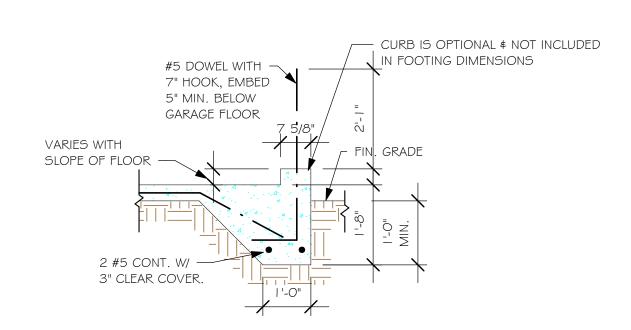


 $\frac{\text{"F3" WITH CURB AT GARAGE}}{1/2\text{"} = 1\text{'-0"}}$ 

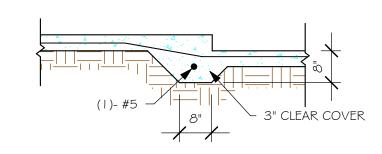

 $\frac{\text{"F6A" STEP DOWN}}{1/2\text{"} = 1\text{'-0"}}$ 

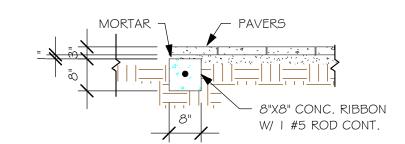

 $\frac{\text{"P" PAVERS DETAIL ENTRY/ LANAI}}{1/2" = 1'-0"}$ 

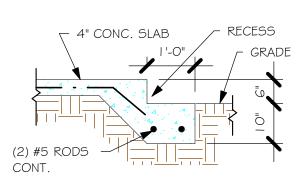


 $\frac{\text{GARAGE DOOR RECESS A}}{1/2" = 1'-0"}$ 

	WALL FOOTING SCHEDULE								
USED	TYPE	LENGTH	WIDTH	DEPTH	BOTTOM REINFORCING	SHAPE			
	F1	CONT.	1'-4"	0'-8"	2-#5				
	F2	CONT.	1'-8"	0'-10"	2-#5				
X	F3	CONT.	1'-0"	1'-8"	2-#5		ADD CUI GARAGE DETAIL		
	F4	CONT.	1'-4"	1'-8"	2-#5	<b>—</b>			
	F5	CONT.	1'-4"	1'-0"	2-#5	<b>—</b>			
	F6	CONT.	1'-4"	1'-0"	2-#5				
X	F6A	CONT.	0'-8"	0'-8"	1-#5				
	TE	CONT.	0'-8"	0'-8"	1-#5				

PROVIDE CORNER BARS IN FOOTING PER DETAIL 6/S-3

# PAD FOOTING SCHEDULE

۵	TYPE	LENGTH	WIDTH	DEPTH	вотт	OM REINF.	REMARKS
USED		LENGIII	WIDIII		LONG WAY	SHORT WAY	- KEMAKKO
X	$\langle A \rangle$	2'-6"	2'-6"	1'-0"	3-#5	3-#5	-
	B	3'-0"	3'-0"	1'-0"	4-#5	4-#5	-
	<b>(C)</b>	3'-6"	3'-6"	1'-0"	4-#5	4-#5	-
	D	4'-0"	4'-0"	1'-2"	5-#5	5-#5	-
	(E)	5'-0"	5'-0"	1'-2"	6-#5	6-#5	-

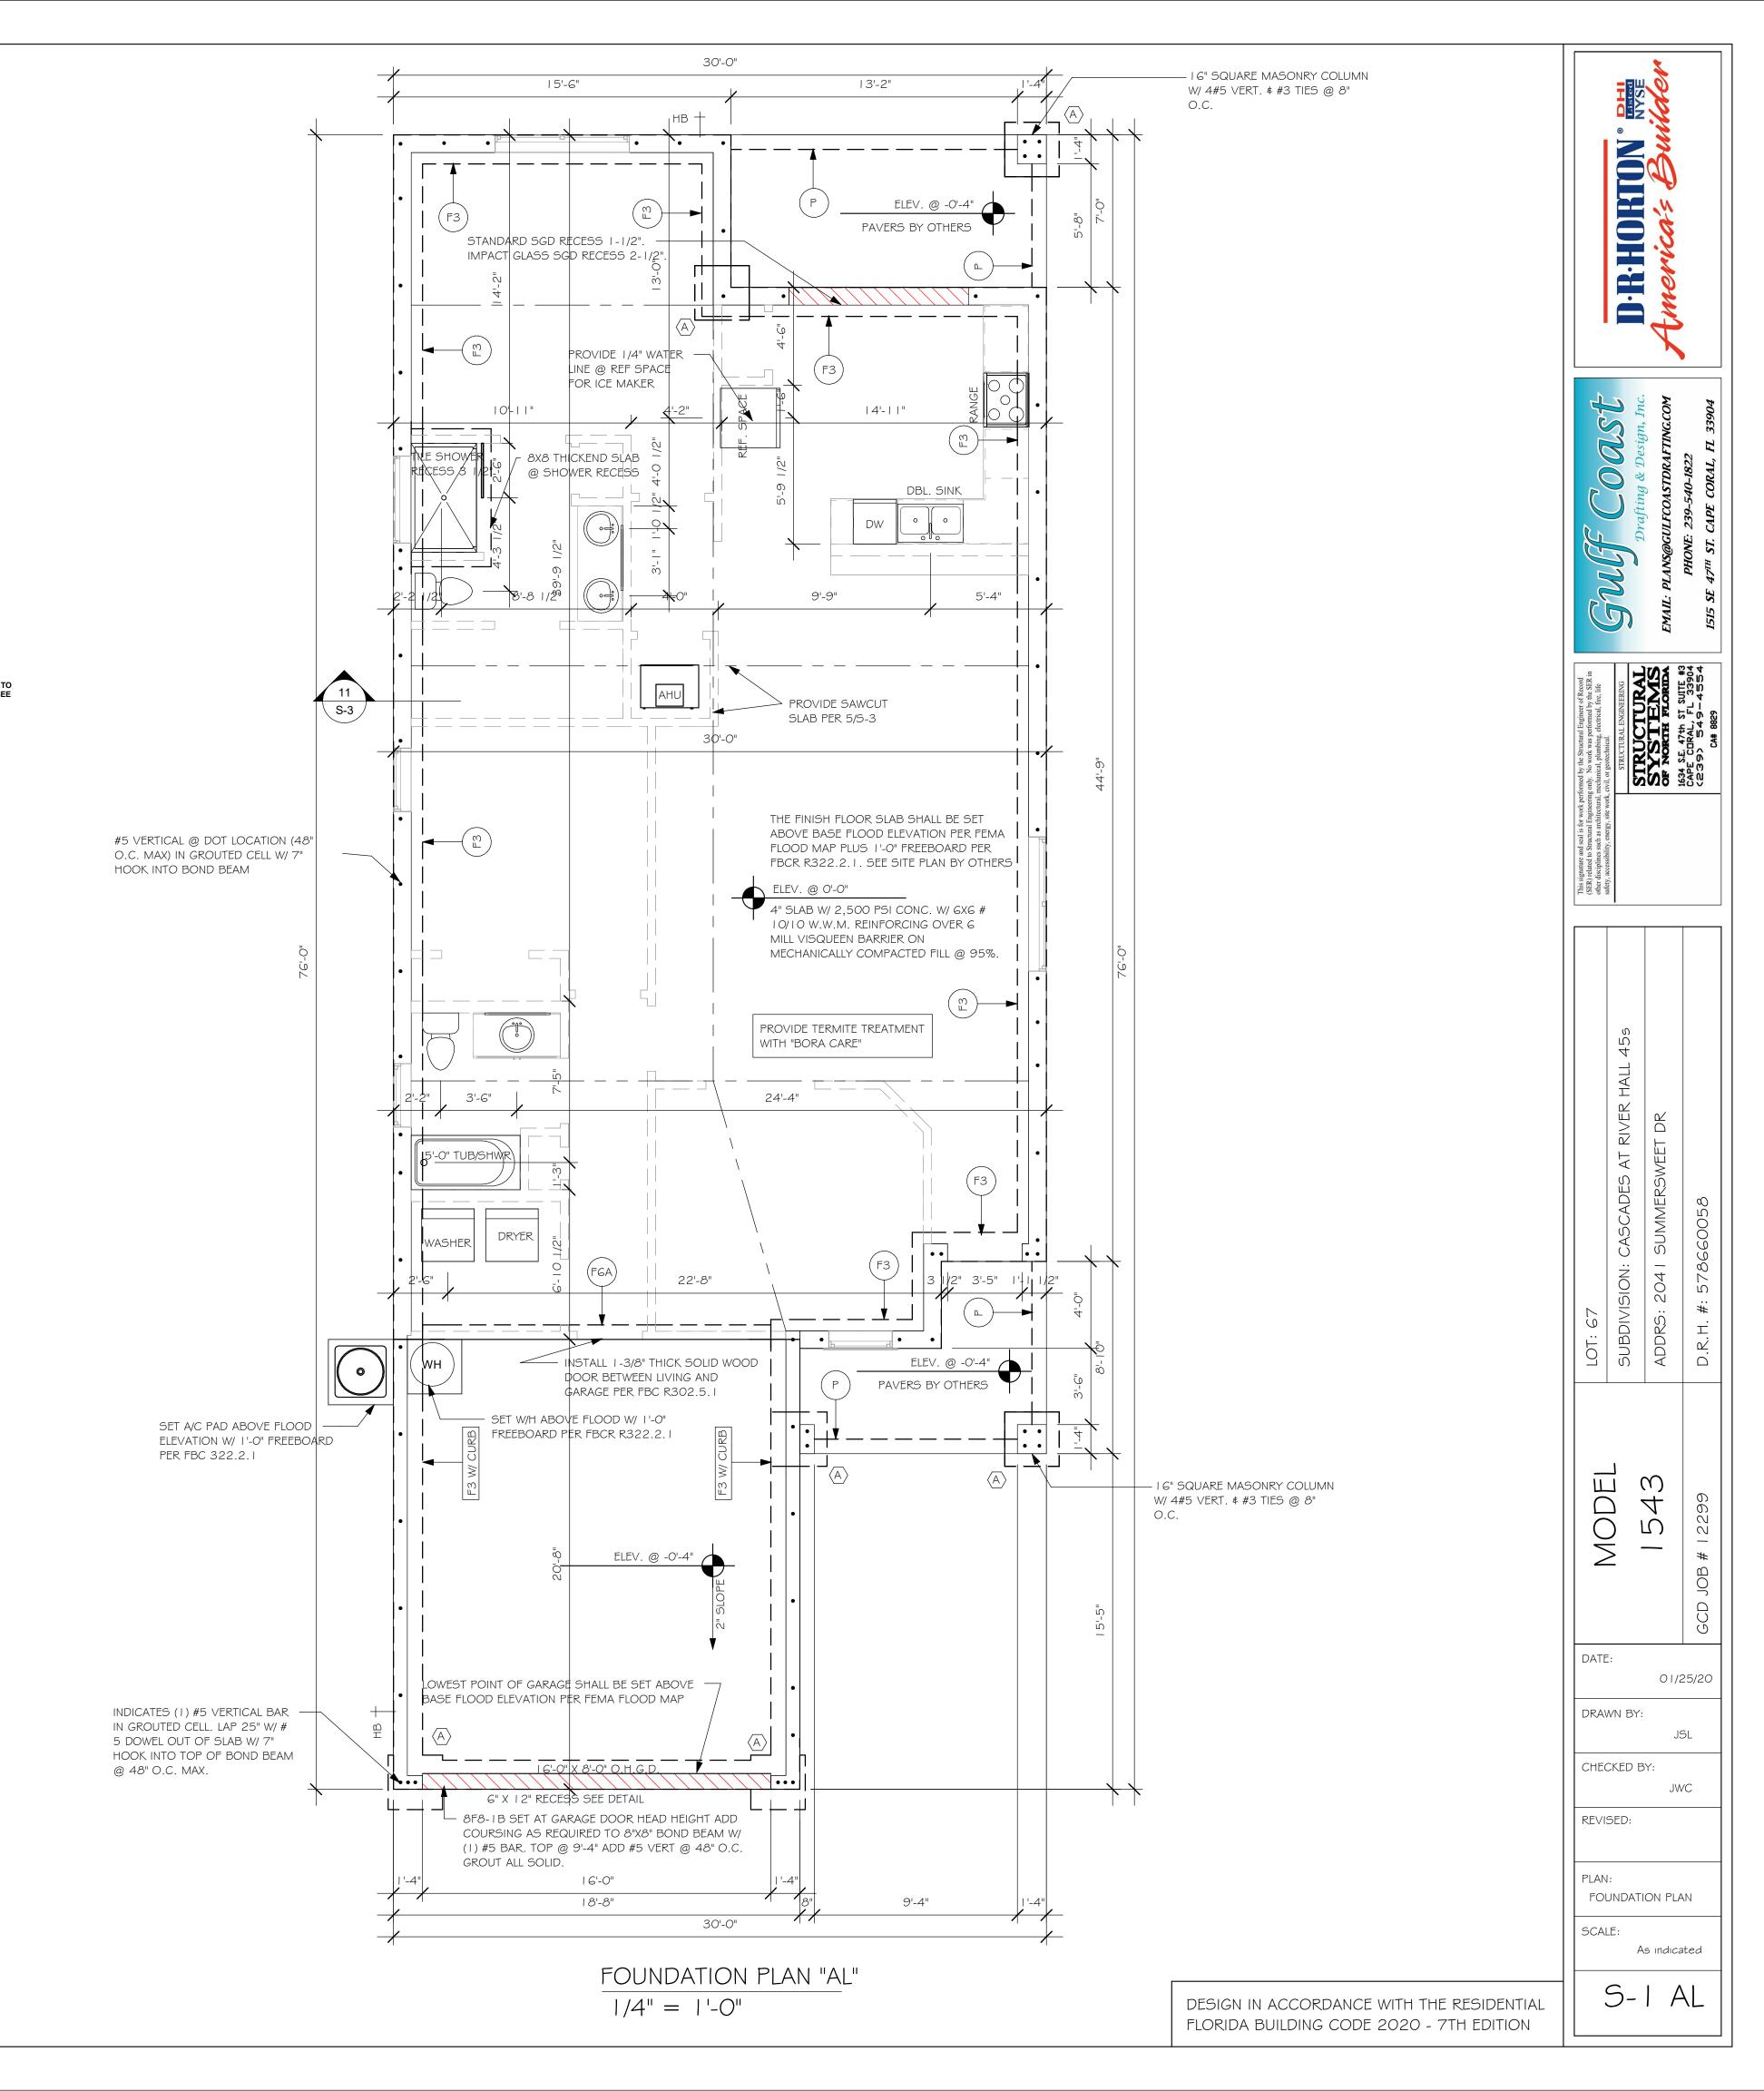

## NOTES:

- I. PROVIDE A STRAP FROM THE ABOVE LIST AT EACH ROOF TRUSS BEARING POINT, BASED ON THE TRUSS UPLIFT VALUES IN THE SIGNED AND SEALED TRUSS DESIGN PACKAGE AND SUITABLE FOR THE GEOMETRY. EMBED STRAP ON -C OF WALL.
- CONNECTORS ARE SIMPSON STRUCTURAL CONNECTORS. ALL CONNECTORS SHALL BE INSTALLED IN STRICT ACCORDANCE WITH SIMPSON PRINTED INSTUCTIONS.
  SUBSTITUTIONS MUST BE APPROVED IN WRITING BY THE ENGINEER OF RECORD.
- WHERE EMBEDDED STRAPS ARE MISSING, OR MIS-LOCATED, INSTALL RETROFIT STRAP PER


SIMPSON CATALOG C-C- 2019


INSTALL AT ALL TRUSSES TO 840 Ib UPLIFT. FOR HIGHER UPLIFTS, SEE NOTES ON PLAN.	TRUSS STRAPPING TO STUDWALL/ WOOD BEAM		
	MAX TRUSS UPLIFT @ 24" OC (LBS)	CONNECTOR	FASTENER
	850 1700 2550 1125 2250 3375 4500	(1)MTS 16 TO 20 (2) MTS 16 TO 20 (3) MTS 16 TO 20 (1) HTS 20 TO 30 (2) HTS 20 TO 30 (3) HTS 20 TO 30 (4) HTS 20 TO 30	(14)   Odx - /2" (14)   Odx - /2" (14)   Odx - /2" (24)   Odx - /2" (24)   Odx - /2" (24)   Odx - /2" (24)   Odx - /2"

#### NOTES:

- 1. PROVIDE A STRAP FROM THE ABOVE LIST AT EACH ROOF TRUSS BEARING POINT, BASED ON THE TRUSS UPLIFT VALUES IN THE SIGNED AND SEALED TRUSS DESIGN PACKAGE.
- 2. CONNECTORS ARE SIMPSON SRTONG TIE. ALL CONNECTORS SHALL BE INSTALLED IN STRICT ACCORDANCE WITH SIMPSON PRINTED INSTUCTIONS.

SIMPSON CATALOG C-C- 2019

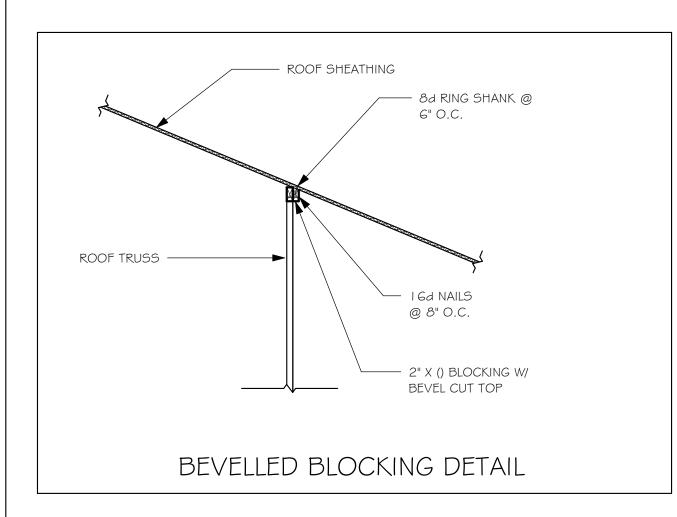

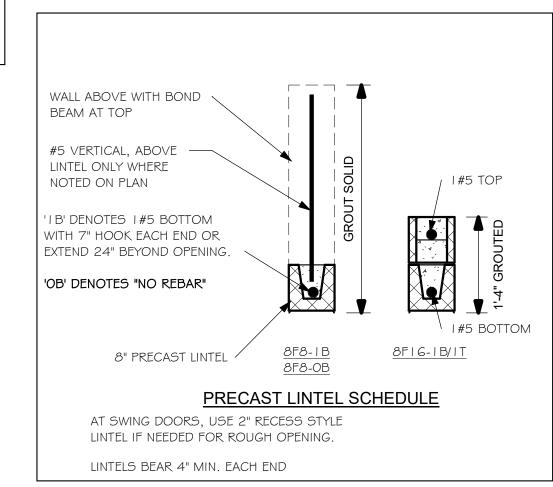

## PLAN NOTES:

- I. ROOF TRUSS BEARING ELEVATION VARIES, SEE
- LEGEND.

  2. ROOF FRAMING SHALL BE WOOD TRUSSES DESIGNED BYA DELEGATED TRUSS ENGINEER PER DESIGN CRITERIA ON SHEET S-3.
- 3. PROVIDE STRAPPING AT TRUSSES PER NOTES ON THIS


BEAM W/ I #5 CONTINUOUS, SEE DETAIL I I/S-3.

- 4. FOR NAILING OF ROOF DECK, SEE I AND 2 ON S-3.

  5. BES. LB etc. DENOTES PRECAST LINTEL ABOVE
- 5. <u>8F8-IB</u> etc., DENOTES PRECAST LINTEL ABOVE DOORWINDOW OPENING PER SCHEDULE THIS SHEET.
   6. AT TRUSS BEARING, PROVIDE 8x8 MASONRY BOND



TRUSS BEARING CONDITIONS AND STRAPPING IS BASED ON TRUSS LAYOUT PREPARED BY SCOSTA JOB# DR | 543CANT DATED: | 2/09/20 REVISED: NONE

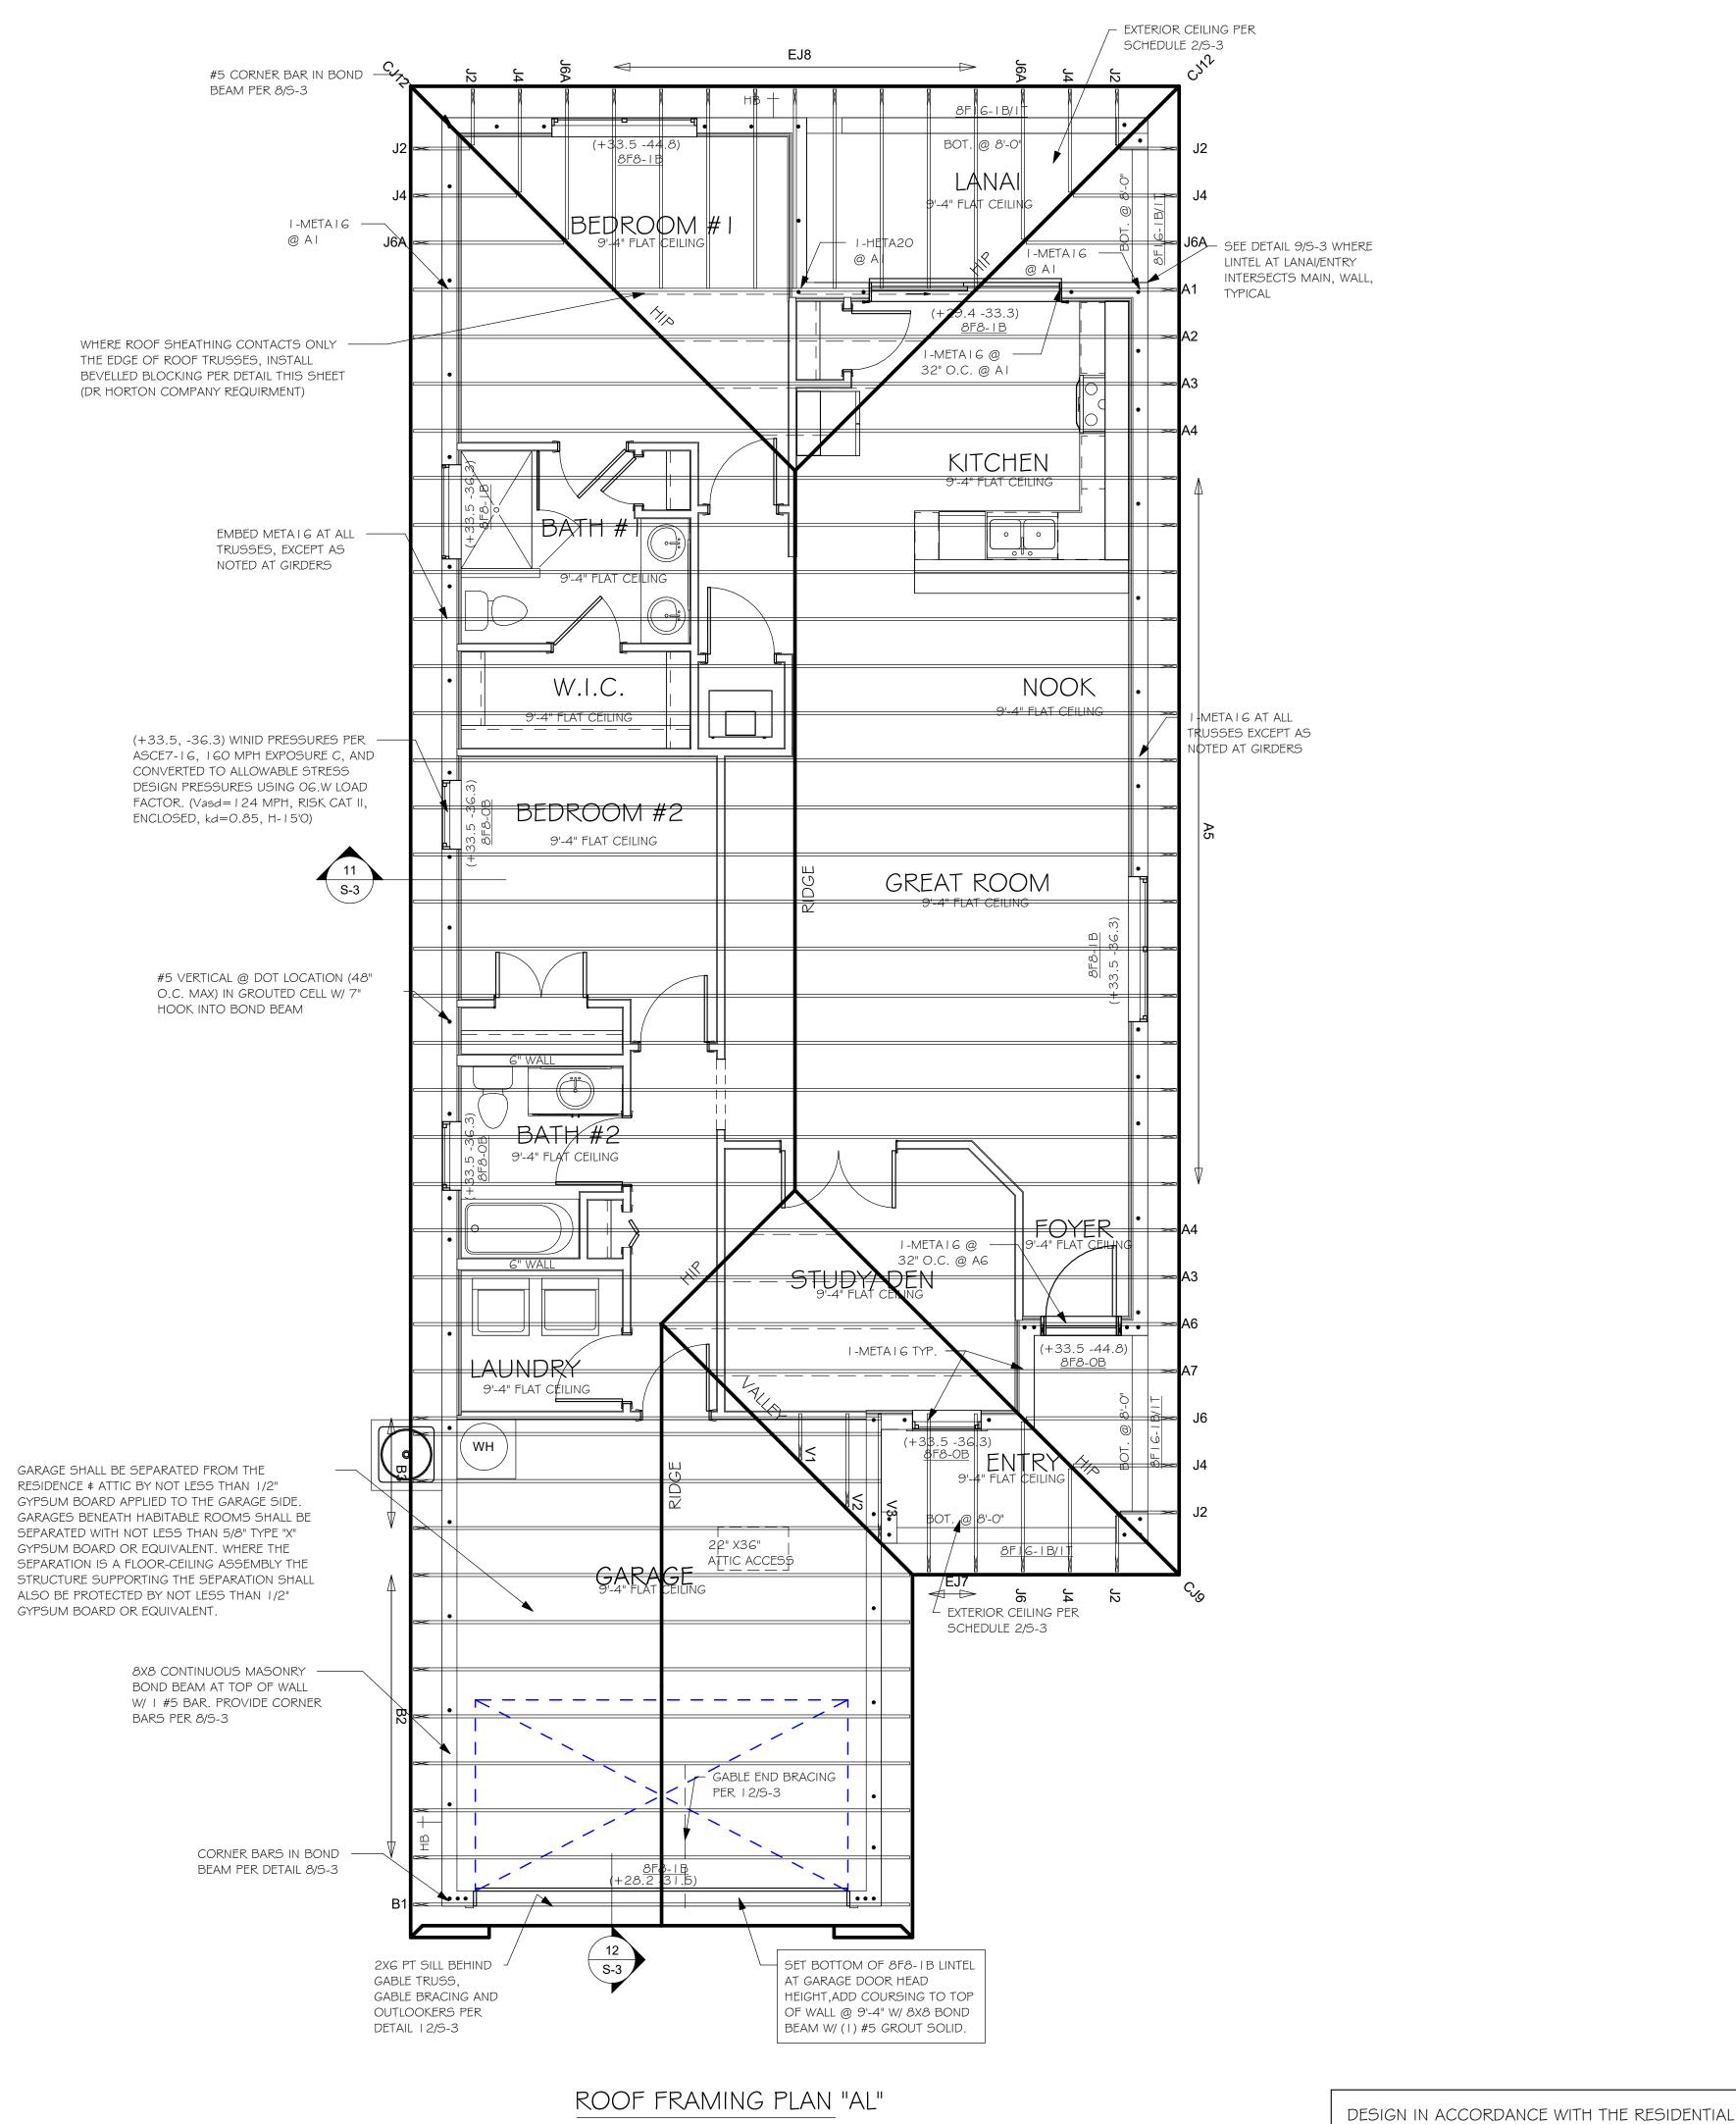

1/4" = 1'-0"

MODEL

DATE:

DRAWN BY:

CHECKED BY:

ROOF FRAMING PLAN

As indicated

S-2 AL

REVISED:

SCALE:

FLORIDA BUILDING CODE 2020 - 7TH EDITION

01/25/20

JWC