



# 18-002\_BP - CUSTOM DREAM HOME

#### **GENERAL NOTES:**

PACIFIC).

- . REFER TO TIMBER FRAME SHOP DRAWINGS FOR ALL SIZES, LOCATIONS AND CONNECTION DETAILS
- 2. PROVIDE SOLID BLOCKING UNDER ALL POINT LOADS ABOVE
- 3. LOCATION FOR UTILITY ROOM (FOR FURNACE, "B" VENT AND HOT WATER TANK) TO BE CONFIRMED UPON REVIEW WITH MECHANCICAL CONTRACTOR.
- 4. LOCATION FOR PLUMBING STACKS AND SERVICING TO BE CONFIRMED UPON REVIEW WITH PLUMBING TRADES.
- 5. LOCATION FOR ELECTRICAL PANEL TO BE CONFIRMED UPON REVIEW WITH ELECTRICAL CONTRACTOR.
- 6. EXTERIOR LOCATION FOR ELECTRICAL METER SERVICING TO BE CONFIRMED UPON REVIEW BY OWNER AND LOCAL UTILITIES
- 7. ALL DIMENSIONAL FRAMING LUMBER TO BE NO. 1 & 2 GRADE S-P-F.
- 8. ALL TIMBER FRAME MEMBERS TO BE EASTERN WHITE PINE NO. 2 GRADE U.N.O. 9. ALL LVL MEMBERS TO BE 2.0E, 2900 fB MANUFACTURED BY LP (LOUISIANA
- 10. ALL PSL MEMBERS TO BE 1.8E, 2900 fB MANUFACTURED BY LP (LOUISIANA
- 11. PRE-ENGINEERED TRUSS FABRICATOR TO SUPPLY TRUSS LAYOUT C/W
- SEALED DESIGNS FOR APPROVAL BY BUILDING INSPECTION DEPARTMENT. 12. PRE-ENGINEERED FLOOR JOIST SUPPLIER TO PROVIDE LAYOUT DRAWING
- 13. ALL HVAC SYSTEM REQUIREMENTS TO BE PROVIDED BY OTHERS.
- 14. ALL INTERIOR DOORS BY OTHERS 15. REFER TO TRUSS MANUFACTURERS SPECS FOR ENGINEERED TRUSSES
- 16. CLOTHES DRYER TO BE VENTED TO EXTERIOR
- 17. WATER RESISTANT FINISHED FLOORING (BY OTHERS) TO BE PROVIDED IN ALL BATHROOMS, KITCHENS, PUBLIC ENTRANCE HALLS, AND GENERAL STORAGE AREAS
- 18. ALL FINISHED FLOORING BY OTHERS
- 19. WOOD STOVE & FIREPLACES TO BE INSTALLED AS PER MANUFACTURES SPECS AND SECTIONS 9.21 & 9.22 NBC
- 20. ALL CHIMNEYS TO COMPLY w/ SECTION 9.21. OF THE NBC
- 21. ALL RAILINGS TO COMPLY w/ SECTION 9.8.8. OF THE NBC
- 22. ALL EXTERIOR STAIRS TO COMPLY w/ SECTION 9.8. OF THE NBC
- 23. ALL POSTS & PIERS @ FOUNDATION LEVEL ON CONC. FOOTINGS OR BEDROCK
- 24. FOUNDATION INSULATION DESIGNED B/O
- 25. FLASH AND SEAL ALL AREAS WHERE TIMBERS PENETRATE WALL ENVELOPE 26. TEST ALL CONTAINERS OF STAIN ON SAMPLE PIECE OF WHITE PINE PRIOR TO APPLYING TO TIMBERS
- 27. SEAL ALL TIMBER CONNECTIONS AT GREAT ROOM FENESTRATION
- 28. REPORT ANY MATERIAL SHORTAGE TO **DISCOVERY DREAM HOMES HEAD OFFICE**
- 29. REFER TO TIMBERFRAME SHOP DRAWINGS FOR SIZING, GRADING AND ASSEMBLY DETAILS

FLOOR AREAS (s	<u>q.ft.)</u>
<u>BASEMENT</u>	
. BASEMENT	1,89
. DECK @ HANGER	2
	1,915 sq 1
LIVING AREAS	
. MAIN FLOOR	2,10
	2,107 sq 1
<u>OTHER</u>	
. AIRPLANE HANGER	1,26
	1,266 sq
PORCHES & DECKS	
. COVERED T.F. PO	11
. DECK	96
. SCREEN PORCH	30
	1,377 sq
	6,665 sq

### **ABBREVIATIONS**

ADDN ADDITION OBC ONTARIO BUILDING CODE P.T. PRESSURE TREATED BUILT UP P.V.B. POLY VAPOUR BARRIER CENTRE LINE CONC. CONCRETE R.O. ROUGH OPENING COMPLETE WITH R.S.O. ROUGH STUD OPENING SF SQUARE FEET

D.O. DIDO DRAWING

FDN FOUNDATION INTERIOR

MANUF. MANUFACTURER NFC NOT FOR CONSTRUCTION NOT TO SCALE

T.O. TOP OF T.F. TIMBERFRAME U/S UNDERSIDE OF U.N.O. UNLESS NOTED OTHERWISE w/ WITH

STRUCTURAL INSULATED PANEL

T&G TONGUE AND GROOVE

T.B.D. TO BE DETERMINED

### **LEGEND**

O.C. ON CENTRE

- SD SMOKE DETECTOR (AS PER SECTION 9.10.19 OBC)
- © CARBON MONOXIDE DETECTOR (AS PER SECTION 9.10.19 OBC)
- POINT LOAD (PROVIDE SOLID BLOCKING BELOW)
- EXHAUST FAN (VENTED TO EXTERIOR)
- T TEMPERED GLASS

SHEET INDEX				
SHEET	CONTENTS			
A-1	GENERAL NOTES, POST, BEAM & HANGER SCHEDULE, DOOR & WINDOW SCHEDULE			
A-2	FRONT & RIGHT ELEVATIONS			
A-3	REAR & LEFT ELEVATIONS			
A-4	SITEPLAN, T.F@ MAIN FL. & DETAILS			
A-5	BASEMENT FLOOR PLAN			
A-6	MAIN FLOOR PLAN			
A-7	UPPER FLOOR PLAN			
A-8	ROOF PLAN & DETAILS			
A-9	MAIN FLOOR ELECTRICAL PLAN			
A-10	SECTIONS			
A-11	SECTIONS			
A-12	SECTIONS			
A-13	DETAILS			
A-14	DETAILS			
A-15	DETAILS			
A-16	FENESTRATION & DETAILS			

\*\* FOR ROUGH STUD OPENINGS (R.S.O.) ADD 1" TO WIDTH & HEIGHT OF DOOR & WINDOW FRAME SIZES

\*\* FOR ROUGH LOG OPENINGS (R.L.O.) ADD 4 1/4" TO WIDTH & 2 1/2" TO HEIGHT OF DOOR & WINDOW FRAME SIZES

	DOOR AND WINDOW SCHEDULE								DOOR AND WINDOW SCHEDULE					BEAM	SCHEDULE			
In.	Hama Stanz	РООМ			AME		VIEW FROM		Homo Stone	POOM		FRA			VIEW FROM		DESCRIPTION	
ID	Home Story	ROOM	QTY	W	HT	NOTES	EXTERIOR	ID	Home Story	ROOM	QTY	W	HT	NOTES	EXTERIOR			
Door		_			_				MAIN FLOOR							B1	8X14 PINE	
	DACEMENT							W9	PLAN	ENSUITE	1	60"	24"	FIXED		B2	3/2X10 P.T	
D1	BASEMENT PLAN	FAMILY ROOM	1 115 1/8" 81"	4-PANEL SLIDING DOOR										B3	3 PLY 16" LVL			
									MAIN FLOOR							B4	8X12 PINE	
	MAIN FLOOR							W10	MAIN FLOOR PLAN	ENSUITE	1	30"	24"	FIXED		B5	6X8 PINE	
D2	PLAN	ENTRY	1	82 5/8"	95 1/2"	DOUBLE DOOR	4		1							B7	W14X68	
								    W11	MAIN FLOOR	W.I.C	1	30"	42"	FIXED		B8	12X8 PINE	
	MAIN FLOOR	COVERED		0011	00.44/40	36" WIDE FIBERGLASS			PLAN	VV.I.C	'	30	42	FIXED		B9	8X14 PINE #1 GRADE	
D3	PLAN	BBQ AREA	1	38"	82 11/16	DOOR (TALL) W/ 22X80 LITE										B10 B11	2 PLY 11 7/8" LVL 3 PLY 11 7/8" LVL	
								W12	MAIN FLOOR PLAN	BEDROOM#	1	48"	60"	CASEMENT		B12	W24X335	
D4	MAIN FLOOR		1	115 1/8"	81"	4-PANEL SLIDING DOOR			PLAN	3						DIZ		
	PLAN	PORCH	'	113 1/6		4-F AINEL SEIDING DOOR										B13	8X14 D. FIR SELECT STRUCTUAL	
								W13	MAIN FLOOR PLAN	BEDROOM#	1	48"	24"	FIXED			STRUCTUAL	
D5	BASEMENT	AIRPLANE	1	38"	82 11/16	36" WIDE FIBERGLASS DOOR (TALL) W/ 22X80			PLAN	3								
	PLAN	HANGAR			02 11,10	LITE												
								W14	MAIN FLOOR PLAN	BATH	1	30"	48"	CASEMENT		POST	SCHEDULE	
D6	BASEMENT PLAN	AIRPLANE HANGAR	1	480"	144"	AIRPLANE HANGER DOOR			LAN							CODE	DESCRIPTION	
	PLAN	HANGAR														D.4	12X12 PINE W/ UPLIF	
			AIRPLANE 1		38" 79"	36" WIDE FIBERGLASS DOOR (TALL) W/ 22X80		W15	MAIN FLOOR PLAN	MUDROOM	1	24"	48"	FIXED		P1	SCREWJACK- SJ3	
D7	BASEMENT PLAN	AIRPLANE HANGAR		38"												P2	6X6 PINE	
	12/11					LITE			MAIN FLOOR	,						P3	8x8 WITH UPLIFT	
	MAIN EL COD	MASTER						W16	PLAN	KITCHEN	1	72"	42"	CASEMENT			SCREWJACK - SJ3	
D8	MAIN FLOOR PLAN	BEDROOM &	1	30"	80 3/4"	INTERIOR DOOR										P4	3/2X6 SPF	
		ENSUITE							UPPER	LIVING						P5	3/2X4 SPF	
Windo	w	_		_	_			W17	FLOOR PLAN		2	105"	78"	FIXED		P6	10x10 #1 GRADE	
	BASEMENT	AIRPLANE															4/2X6 SPF 8X8 #1 GRADE w/ HD	
W1	PLAN	HANGAR 2		2	60"	60"	60" CASEMENT		W18 UF	UPPER	CLERESTOR	,	60"	60" 30"	FIXED		P8	SCREWJACKS - SJ2
						FLOOR PLAN	AN EY		0   00   30	FIXED								
	BASEMENT	FAMILY																
W2	PLAN	ROOM	1	105"	66"	CASEMENT		W19	UPPER	CLERESTOR	4	65"	18 1/2"	FIXED		HANGE	R SCHEDULE	
	_								FLOOR PLAN	EY	'		10 1/2	I IXEB			1	
1	BASEMENT	FAMILY		05"	0.4"	EIVED											DESCRIPTION	
W3	PLAN	ROOM	1	95"	24"	FIXED		W20	UPPER	COVERED	1	47 1/4"	8 7/8"	ARCHITECHTURAL		H1	LUS28	
									FLOOR PLAN	BBQ AREA								
W4	BASEMENT	OFFICE	1	106 11/16"	24"	FIXED												
	PLAN	OTTIOL	'	100 11/10	24	I IALD		W21	UPPER FLOOR PLAN	SCREEN	1	117 3/4"	24 9/16"	ARCHITECHTURAL		FOOTI	NG SCHEDULE	
									LOOKFLAN	FORCH							DESCRIPTION	
W5	MAIN FLOOR	LIVING	2	105"	78"	AWNING										CODE		
	PLAN	ROOM						W22	UPPER FLOOR PLAN	SCREEN PORCH	1	117 3/4"	40 1/4"	ARCHITECHTURAL			10" CONC. PIER ON	
									. 2001(1.2/11)	1 011011						   F1	30"x30"x10" CONC. F	
W6a	MAIN FLOOR PLAN	BEDROOM #	BEDROOM# 2	36"	60"	CASEMENT			LIDDED	000551							INTO FTG & TO EXTE	
	PLAN	2						W23	UPPER FLOOR PLAN	SCREEN PORCH	1	153 1/16"	27 5/16"	ARCHITECHTURAL			WITHING 3" TOP OF	
																F2	55x55x25" CONC. FT	
W6b	MAIN FLOOR PLAN	MASTER BEDROOM	2	42"	60"	CASEMENT			MAIN EL OOR	SCREN				WEATHEDMARTED		F3	25x25x11 CONC. FTG	
	I LAIN	PLDVOON						W24	MAIN FLOOR PLAN	PORCH	1	45"	74 1/2"	WEATHERMASTER WINDOW		F4	70x70x33" CONC. FT	
																F5	50x50x20" CONC. FT	
W7	MAIN FLOOR PLAN	MASTER BEDROOM	2	36"	60"	CASEMENT			MAIN FLOOR	SCREEN				WEATHERMASTER				
	1 = 114	JEDI (OOW						W24	PLAN	PORCH	3	45"	74 1/2"	WINDOW				
	MAIN EL COD																	
W8	MAIN FLOOR PLAN	ENSUITE	1	30"	42"	CASEMENT			MAIN FLOOR	SCRFFN				WEATHERMASTER				
								W25	PLAN	PORCH	1	38"	74 1/2"	WINDOW				

LOG WALL AND TIMBERS BY DDH ONLY AS PER CONTRACT

 DO NOT SCALE DRAWINGS 2. These plans shall be considered "Not for Construction" unless they have been approved by the local building

3. All measurements to be checked & confirmed by contractor prior to construction. Any discrepancies should be reported. 4. All construction to comply with requirements of the Local Building Authorities.

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### **NOT FOR** CONSTRUCTION

BEAM	SCHEDULE
CODE	DESCRIPTION
B1	8X14 PINE
B2	3/2X10 P.T
B3	3 PLY 16" LVL
B4	8X12 PINE
B5	6X8 PINE
B7	W14X68
B8	12X8 PINE
B9	8X14 PINE #1 GRADE
B10	2 PLY 11 7/8" LVL
B11	3 PLY 11 7/8" LVL
B12	W24X335
B13	8X14 D. FIR SELECT STRUCTUAL

	POST SCHEDULE					
	CODE	DESCRIPTION				
	P1	12X12 PINE W/ UPLIFT SCREWJACK- SJ3				
	P2	6X6 PINE				
	P3	8x8 WITH UPLIFT SCREWJACK - SJ3				
	P4	3/2X6 SPF				
	P5	3/2X4 SPF				
	P6	10x10 #1 GRADE				
	P7	4/2X6 SPF				
	P8	8X8 #1 GRADE w/ HD SCREWJACKS - SJ2				
	•					

HANGE	R SCHEDULE
CODE	DESCRIPTION
H1	LUS28

#### FOOTING SCHEDULE CODE DESCRIPTION 10" CONC. PIER ON 30"x30"x10" CONC. FTGw/2-10M VERTICAL REBAR BENT INTO FTG & TO EXTEND WITHING 3" TOP OF PIER 55x55x25" CONC. FTG 25x25x11 CONC. FTG

70x70x33" CONC. FTG

50x50x20" CONC. FTG

	design, and has t	has reviewed and takes respo he qualifications and meets th ario Building Code to design t	e requireme
	QU	ALIFICATION INFORMATION INFORMATION INFORMATION INFORMATION INFORMATION IN THE PROPERTY OF THE	
	NAME .	SIGNATURE	В

SCOPE OF WORK

REGISTRATION INFORMATION



4 McCloskey Rd. r-elerborough, Ontario, Canada K9J 0G6 (T) (705) 400-5647 (F)705-295-5648 www.discoverydreamhomes.com

4			
3	CLIENT REV.	05-16-2018	AA
2	ENG.REV.	05-15-2018	AA
1	FOR PERMIT	04-30-2018	AA
#	REVISION	MM/DD/YYYY	BY
Dra	wing Title:		

**GENERAL NOTES, POST, BEAM & HANGER SCHEDULE, DOOR & WINDOW SCHEDULE** 

**CUSTOM DREAM HOME** 

PERCY LAKE PHASE 4, FORT IRWIN, HALBURTON Design Roof Load: Ground Snow Load:

Sales Rep.: Scale: Drawn By: Sales AS NOTED Project No: 18-002\_BP A-1 of A-16/

DESCRIPTION

12X12 PINE W/ UPLIFT


25x25x11 CONC. FTG 70x70x33" CONC. FTG

50x50x20" CONC. FTG

30"x30"x10" CONC. FTGw/2-10M VERTICAL REBAR BENT INTO FTG & TO EXTEND WITHING 3" TOP OF PIER 55x55x25" CONC. FTG

18-002 BP INTERNAL REVIEW - 5/16/2018


A-1 of A-16

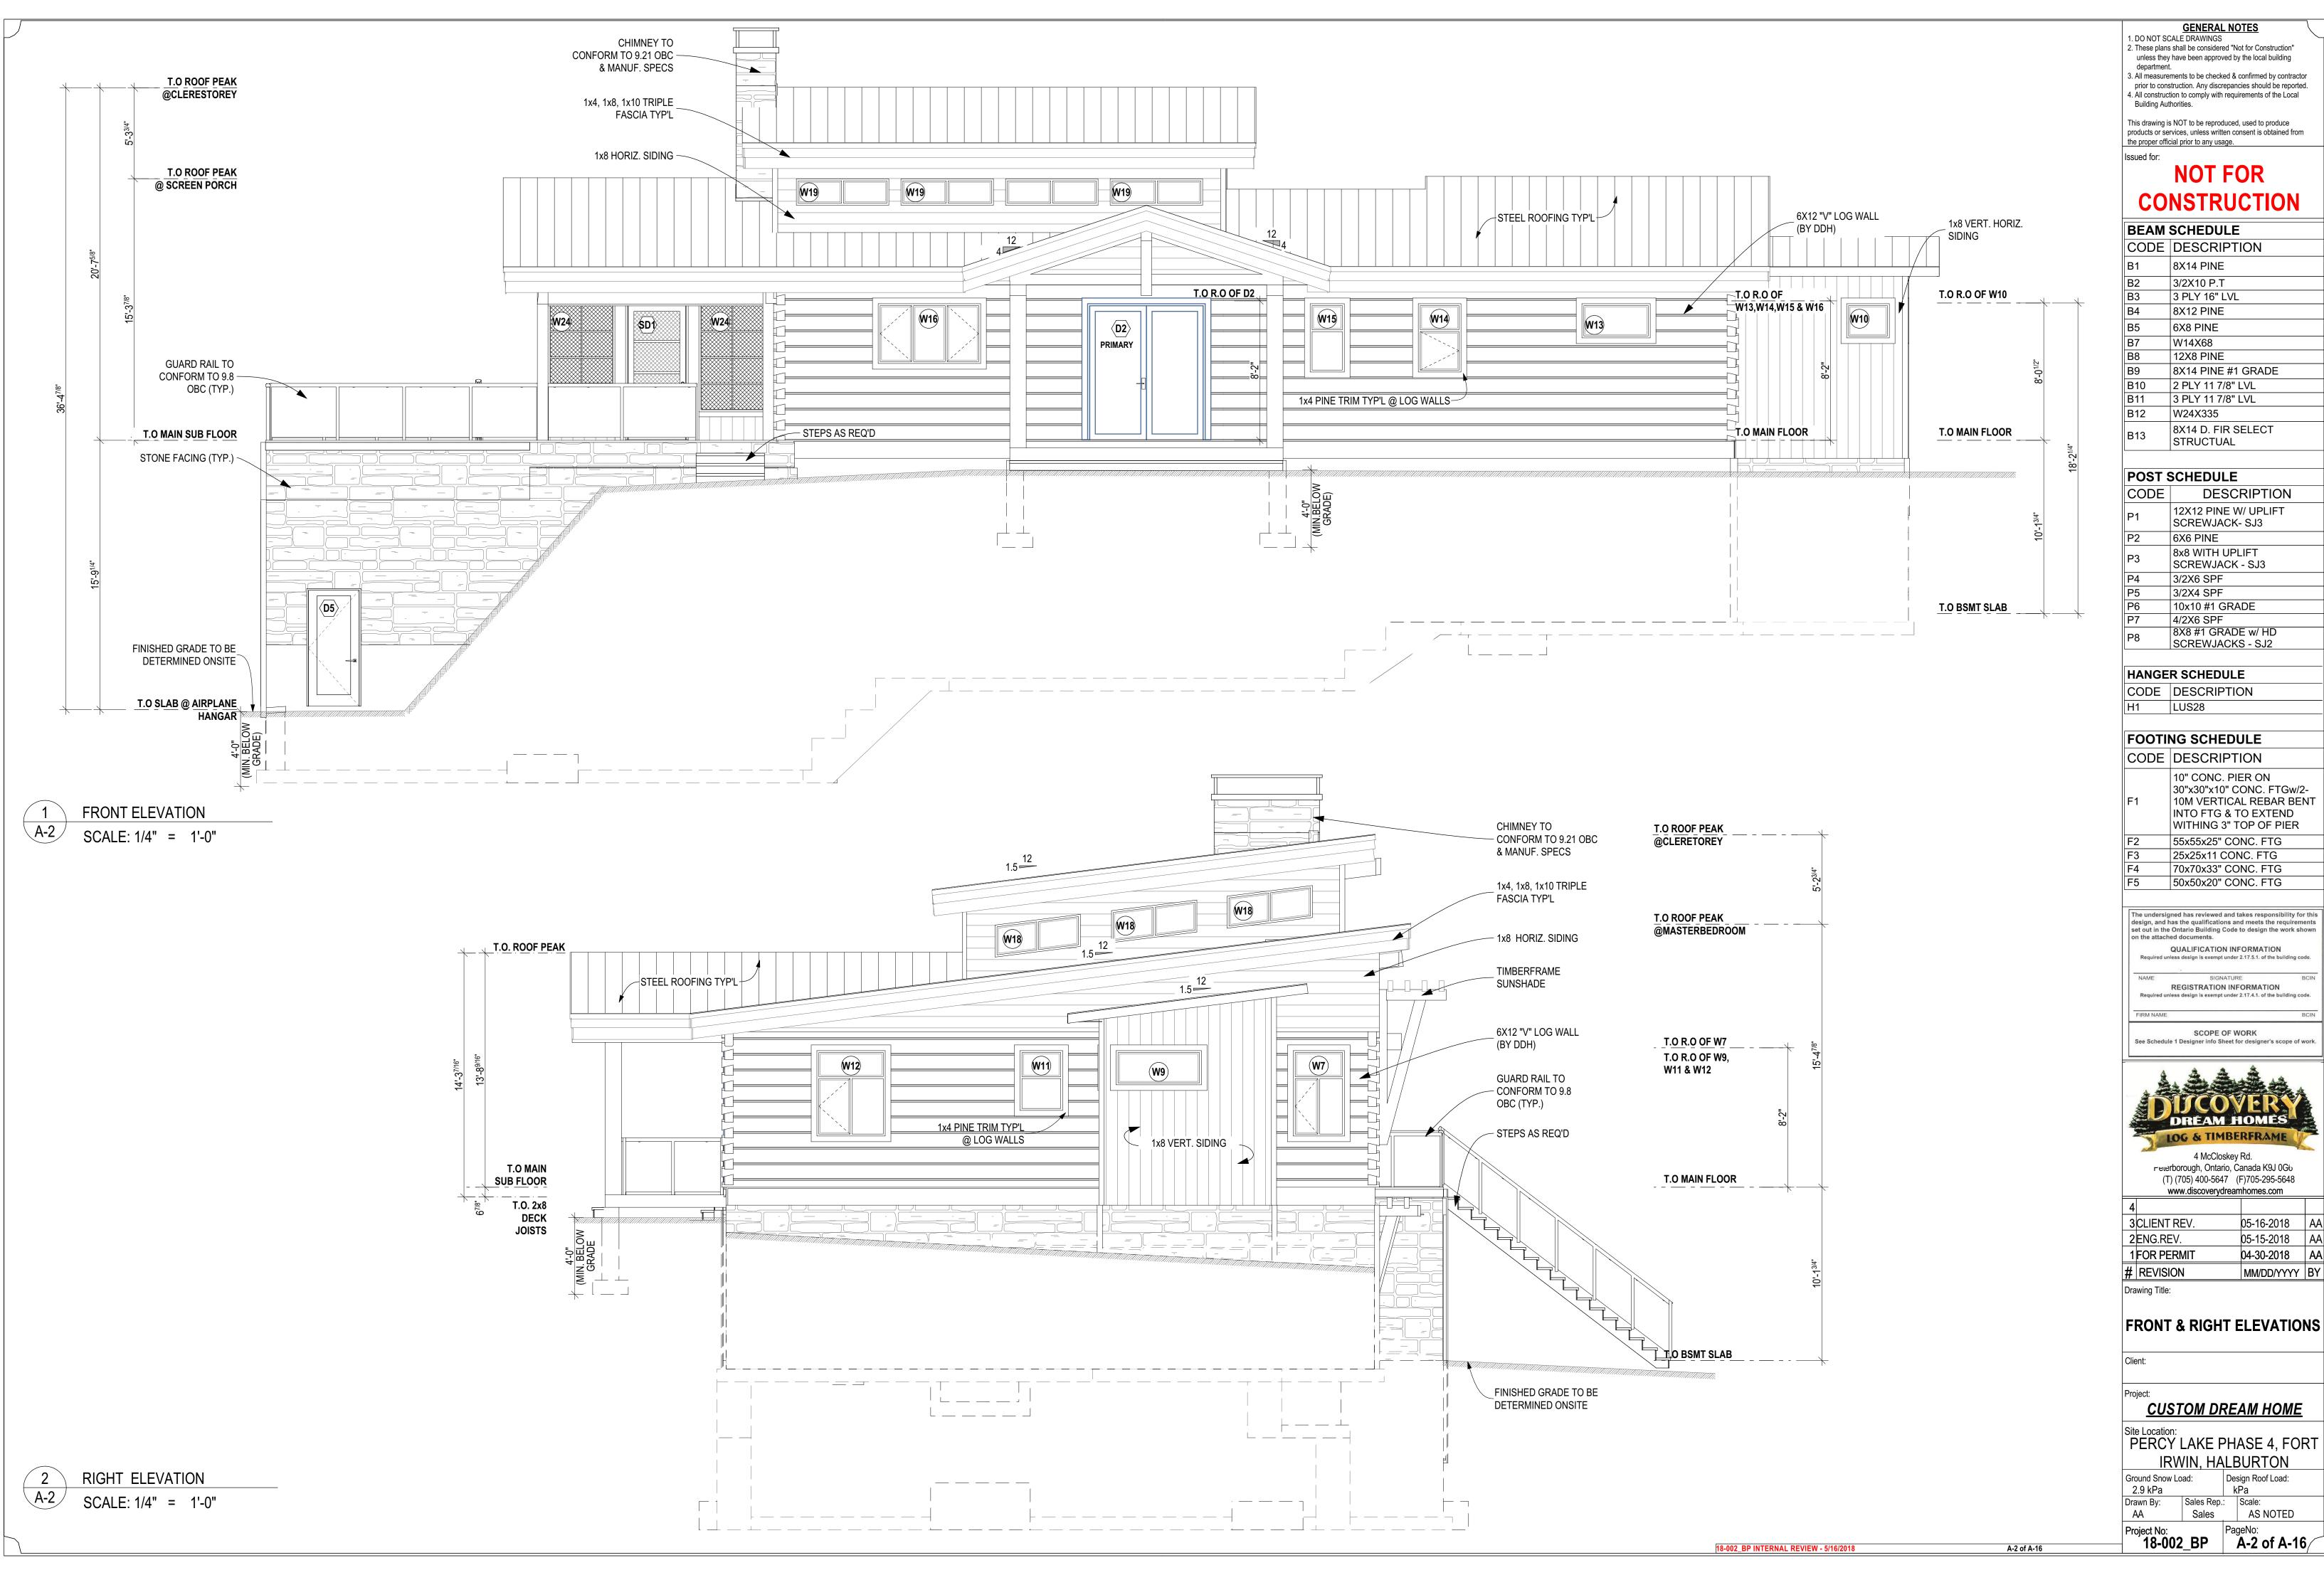


BEAM	SCHEDULE
CODE	DESCRIPTION
B1	8X14 PINE
B2	3/2X10 P.T
B3	3 PLY 16" LVL
B4	8X12 PINE
B5	6X8 PINE
B7	W14X68
B8	12X8 PINE
B9	8X14 PINE #1 GRADE
B10	2 PLY 11 7/8" LVL
B11	3 PLY 11 7/8" LVL
B12	W24X335
B13	8X14 D. FIR SELECT STRUCTUAL
	•

POST S	POST SCHEDULE						
CODE	DESCRIPTION						
P1	12X12 PINE W/ UPLIFT SCREWJACK- SJ3						
P2	6X6 PINE						
P3	8x8 WITH UPLIFT SCREWJACK - SJ3						
P4	3/2X6 SPF						
P5	3/2X4 SPF						
P6	10x10 #1 GRADE						
P7	4/2X6 SPF						
P8	8X8 #1 GRADE w/ HD						

4			
3	CLIENT REV.	05-16-2018	AA
2	ENG.REV.	05-15-2018	AA
1	FOR PERMIT	04-30-2018	AA
#	REVISION	MM/DD/YYYY	BY
Dro	wing Title:		

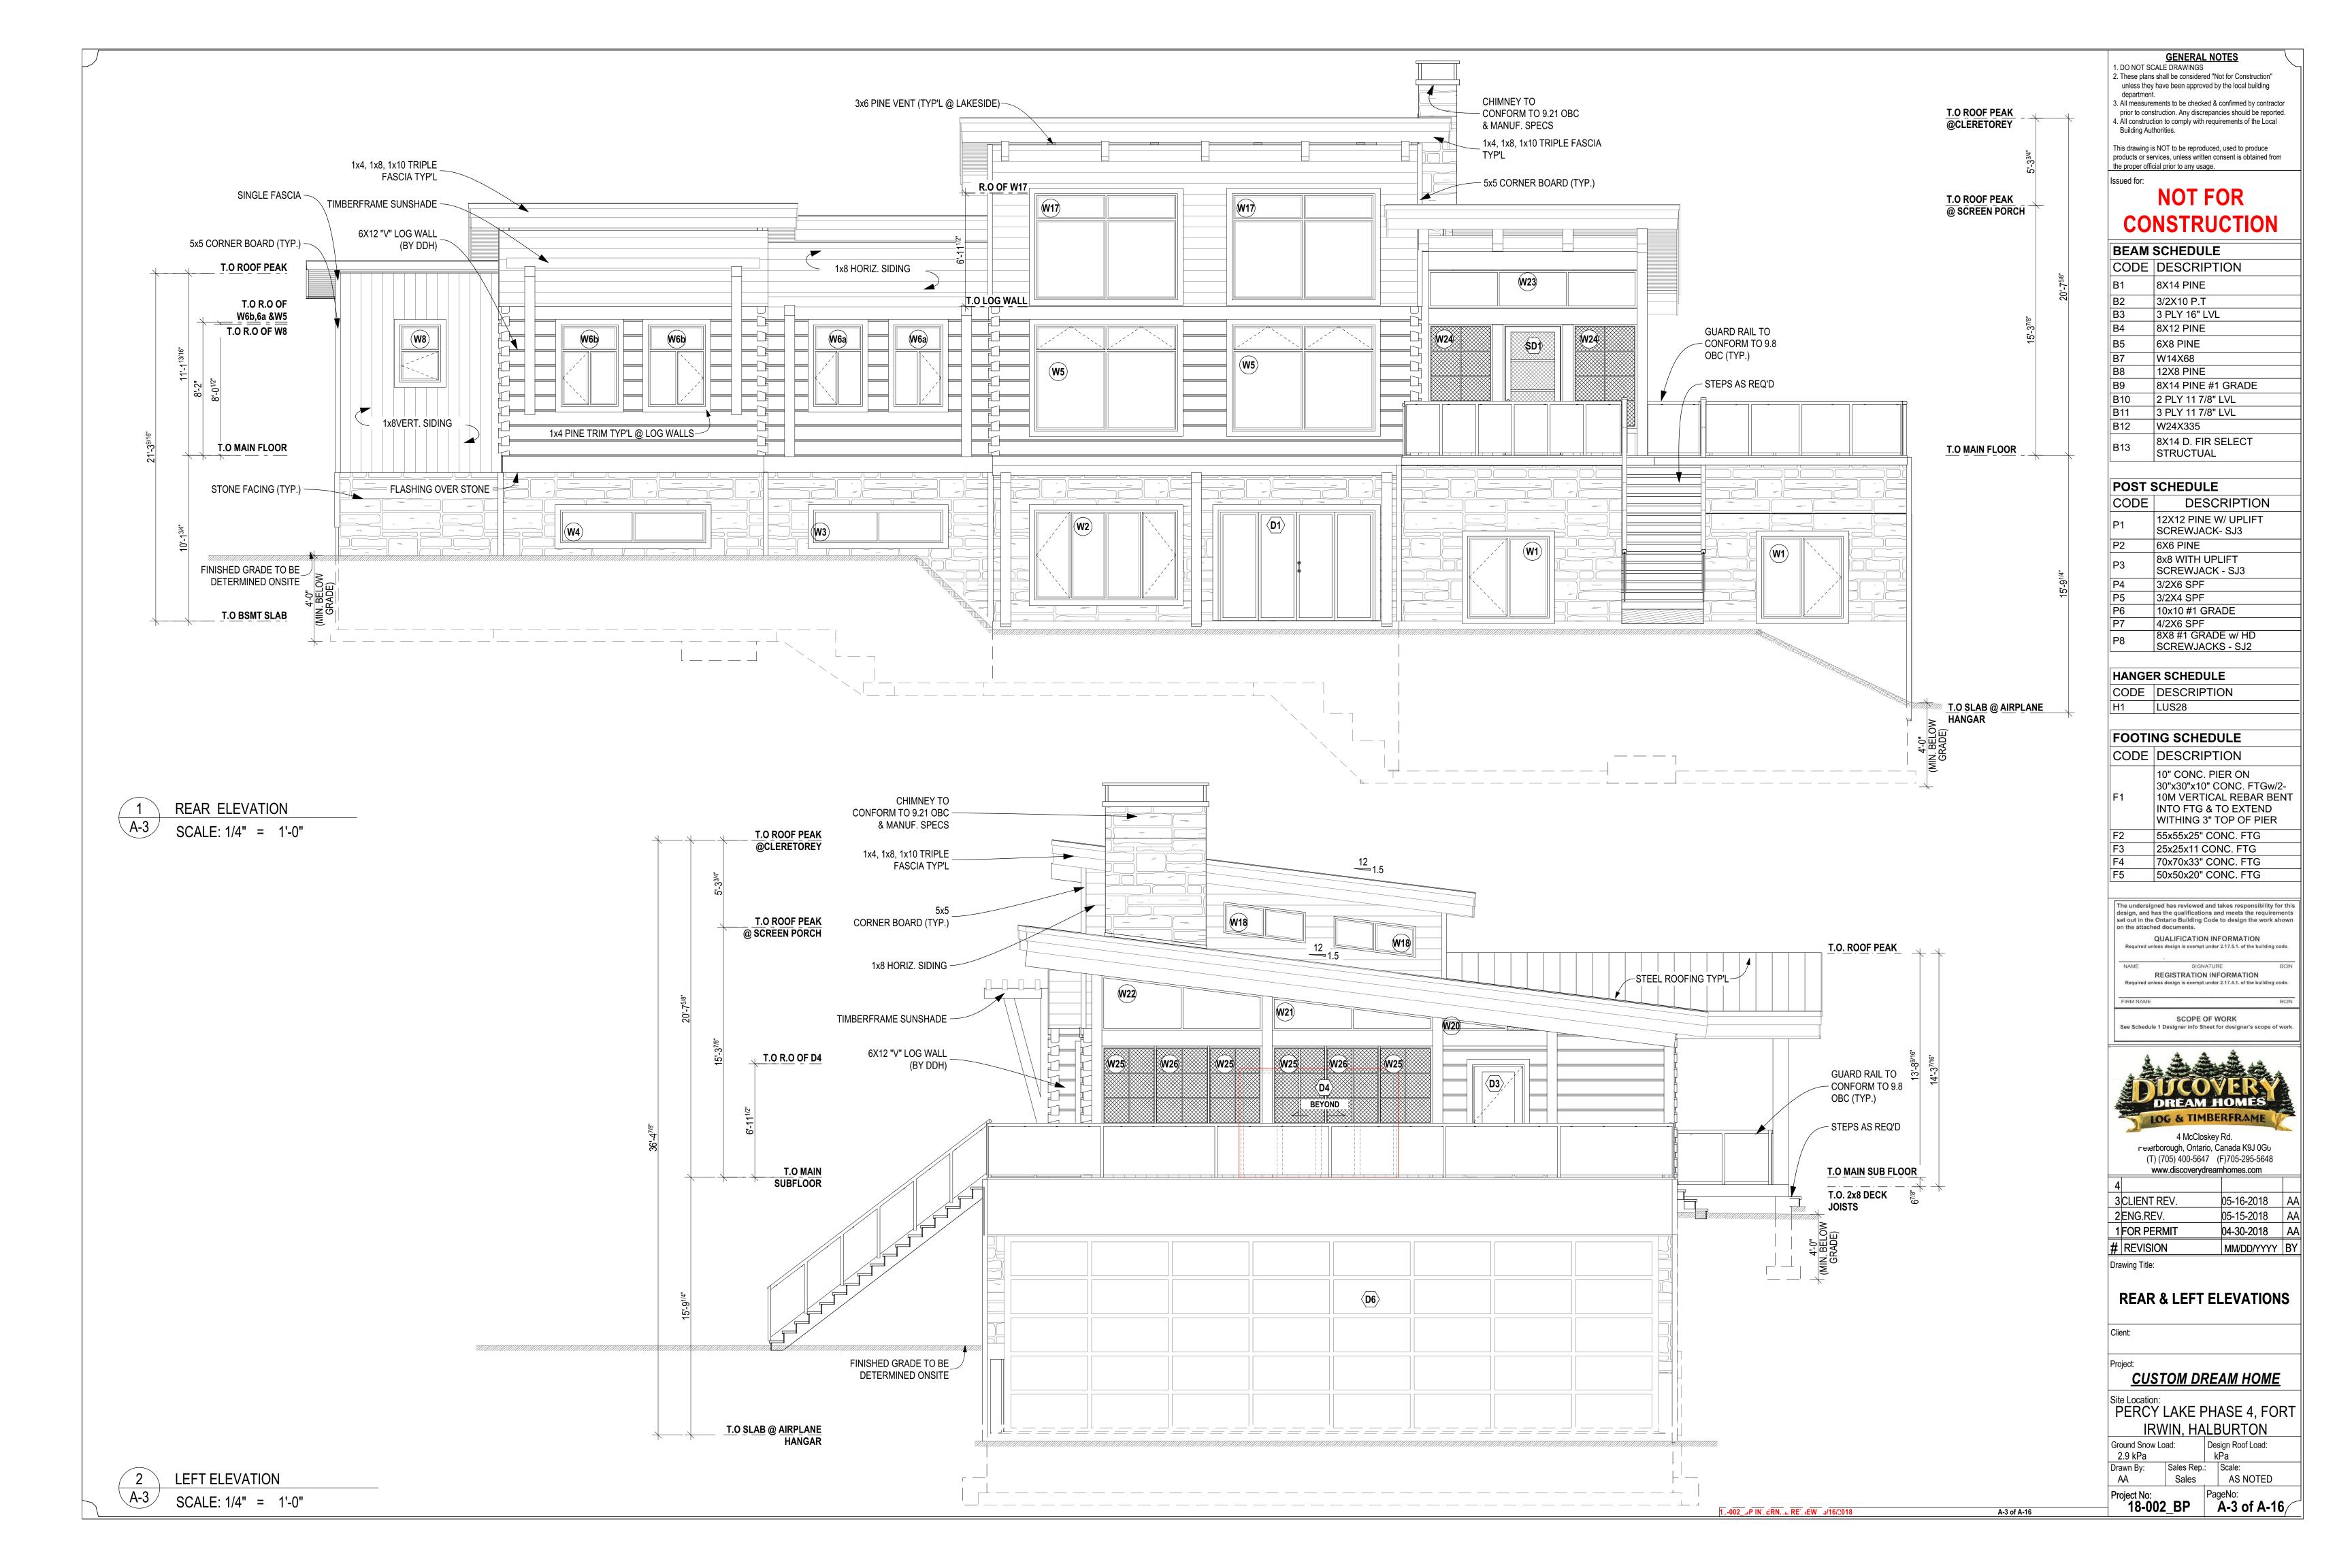

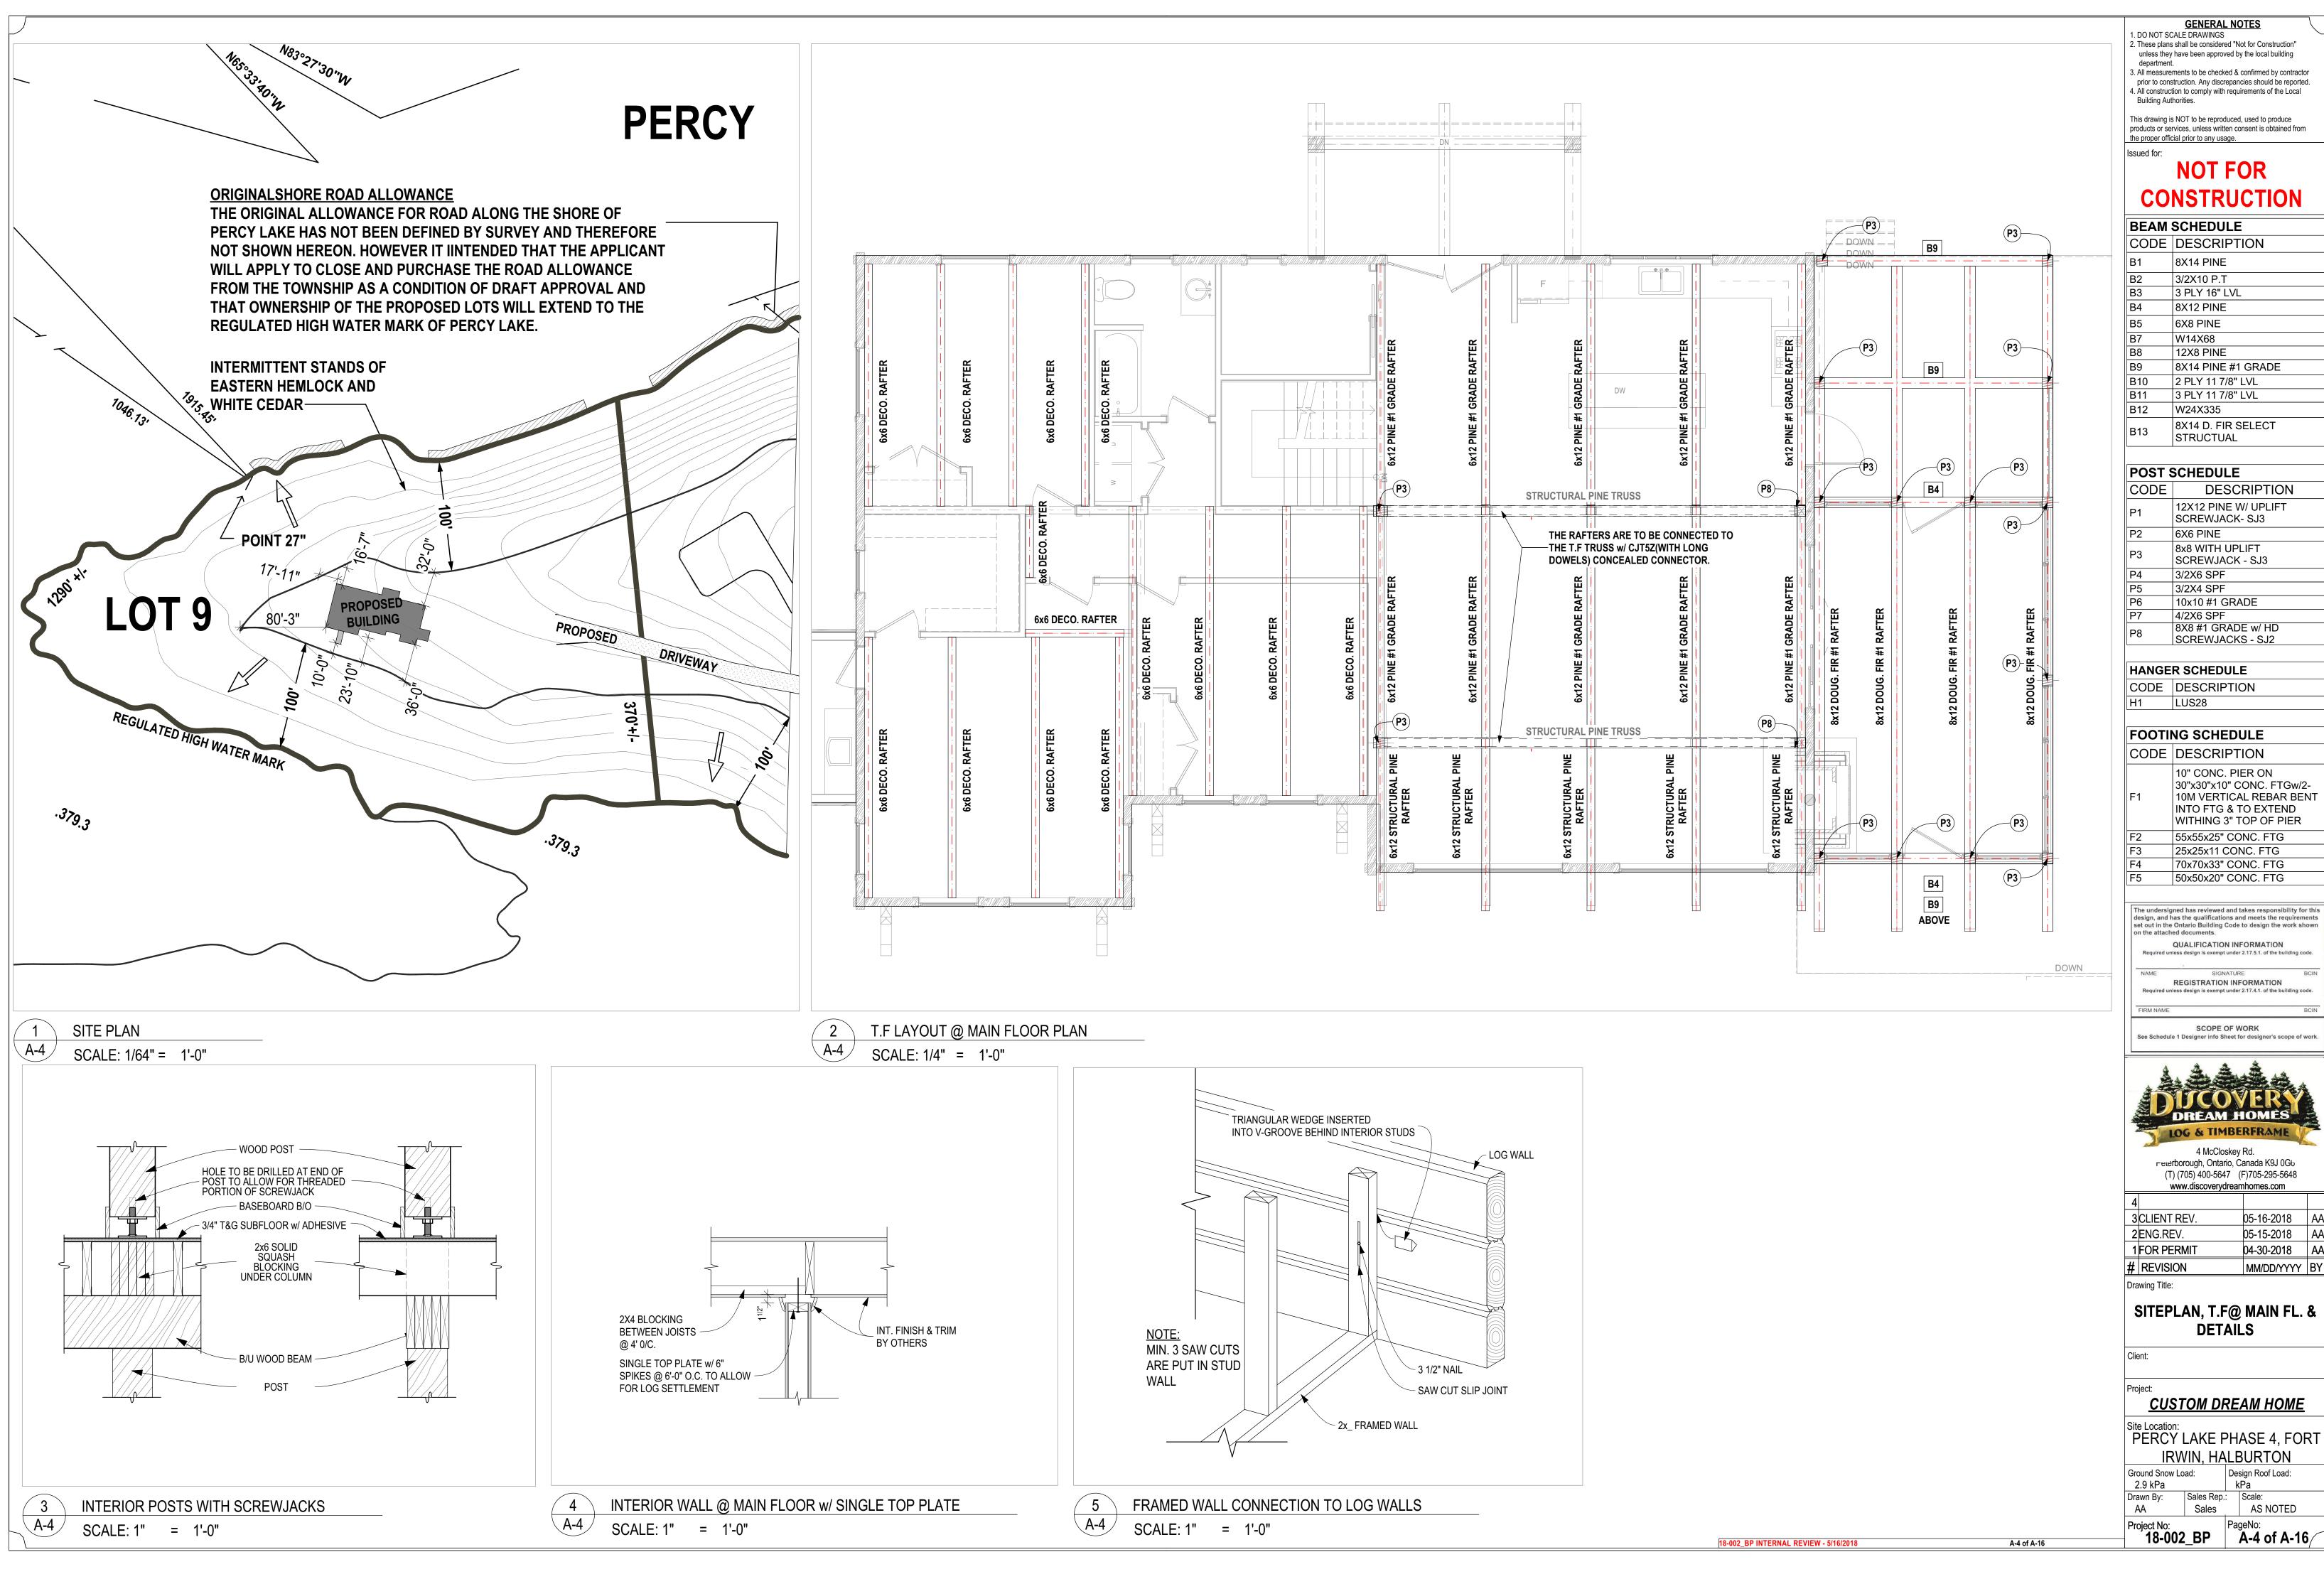

unless they have been approved by the local building

3. All measurements to be checked & confirmed by contractor prior to construction. Any discrepancies should be reported.

4. All construction to comply with requirements of the Local

BEAM	SCHEDULE
CODE	DESCRIPTION
B1	8X14 PINE
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B13	8X14 D. FIR SELECT

POST SCHEDULE		
CODE	DESCRIPTION	
P1	12X12 PINE W/ UPLIFT SCREWJACK- SJ3	
P2	6X6 PINE	
P3	8x8 WITH UPLIFT SCREWJACK - SJ3	
P4	3/2X6 SPF	
P5	3/2X4 SPF	
P6	10x10 #1 GRADE	
P7	4/2X6 SPF	
P8	8X8 #1 GRADE w/ HD	

HANGER SCHEDULE	
CODE	DESCRIPTION
H1	LUS28

F1	10" CONC. PIER ON 30"x30"x10" CONC. FTGw/2- 10M VERTICAL REBAR BEN INTO FTG & TO EXTEND WITHING 3" TOP OF PIER
F2	55x55x25" CONC. FTG
F3	25x25x11 CONC. FTG
F4	70x70x33" CONC. FTG
F5	50x50x20" CONC. FTG

The undersigned has reviewed and takes responsibility for this design, and has the qualifications and meets the requirements set out in the Ontario Building Code to design the work shown

QUALIFICATION INFORMATION equired unless design is exempt under 2.17.5.1. of the building coo

SCOPE OF WORK
See Schedule 1 Designer info Sheet for designer's scope of wor




recerborough, Ontario, Canada K9J 0G6


3	CLIENT REV.	05-16-2018	AA
2	ENG.REV.	05-15-2018	AA
1	FOR PERMIT	04-30-2018	AA
#	REVISION	MM/DD/YYYY	BY
Drawing Title:			


# SITEPLAN, T.F@ MAIN FL. &


IRWIN, HALBURTON

Sales Rep.: Scale: AS NOTED

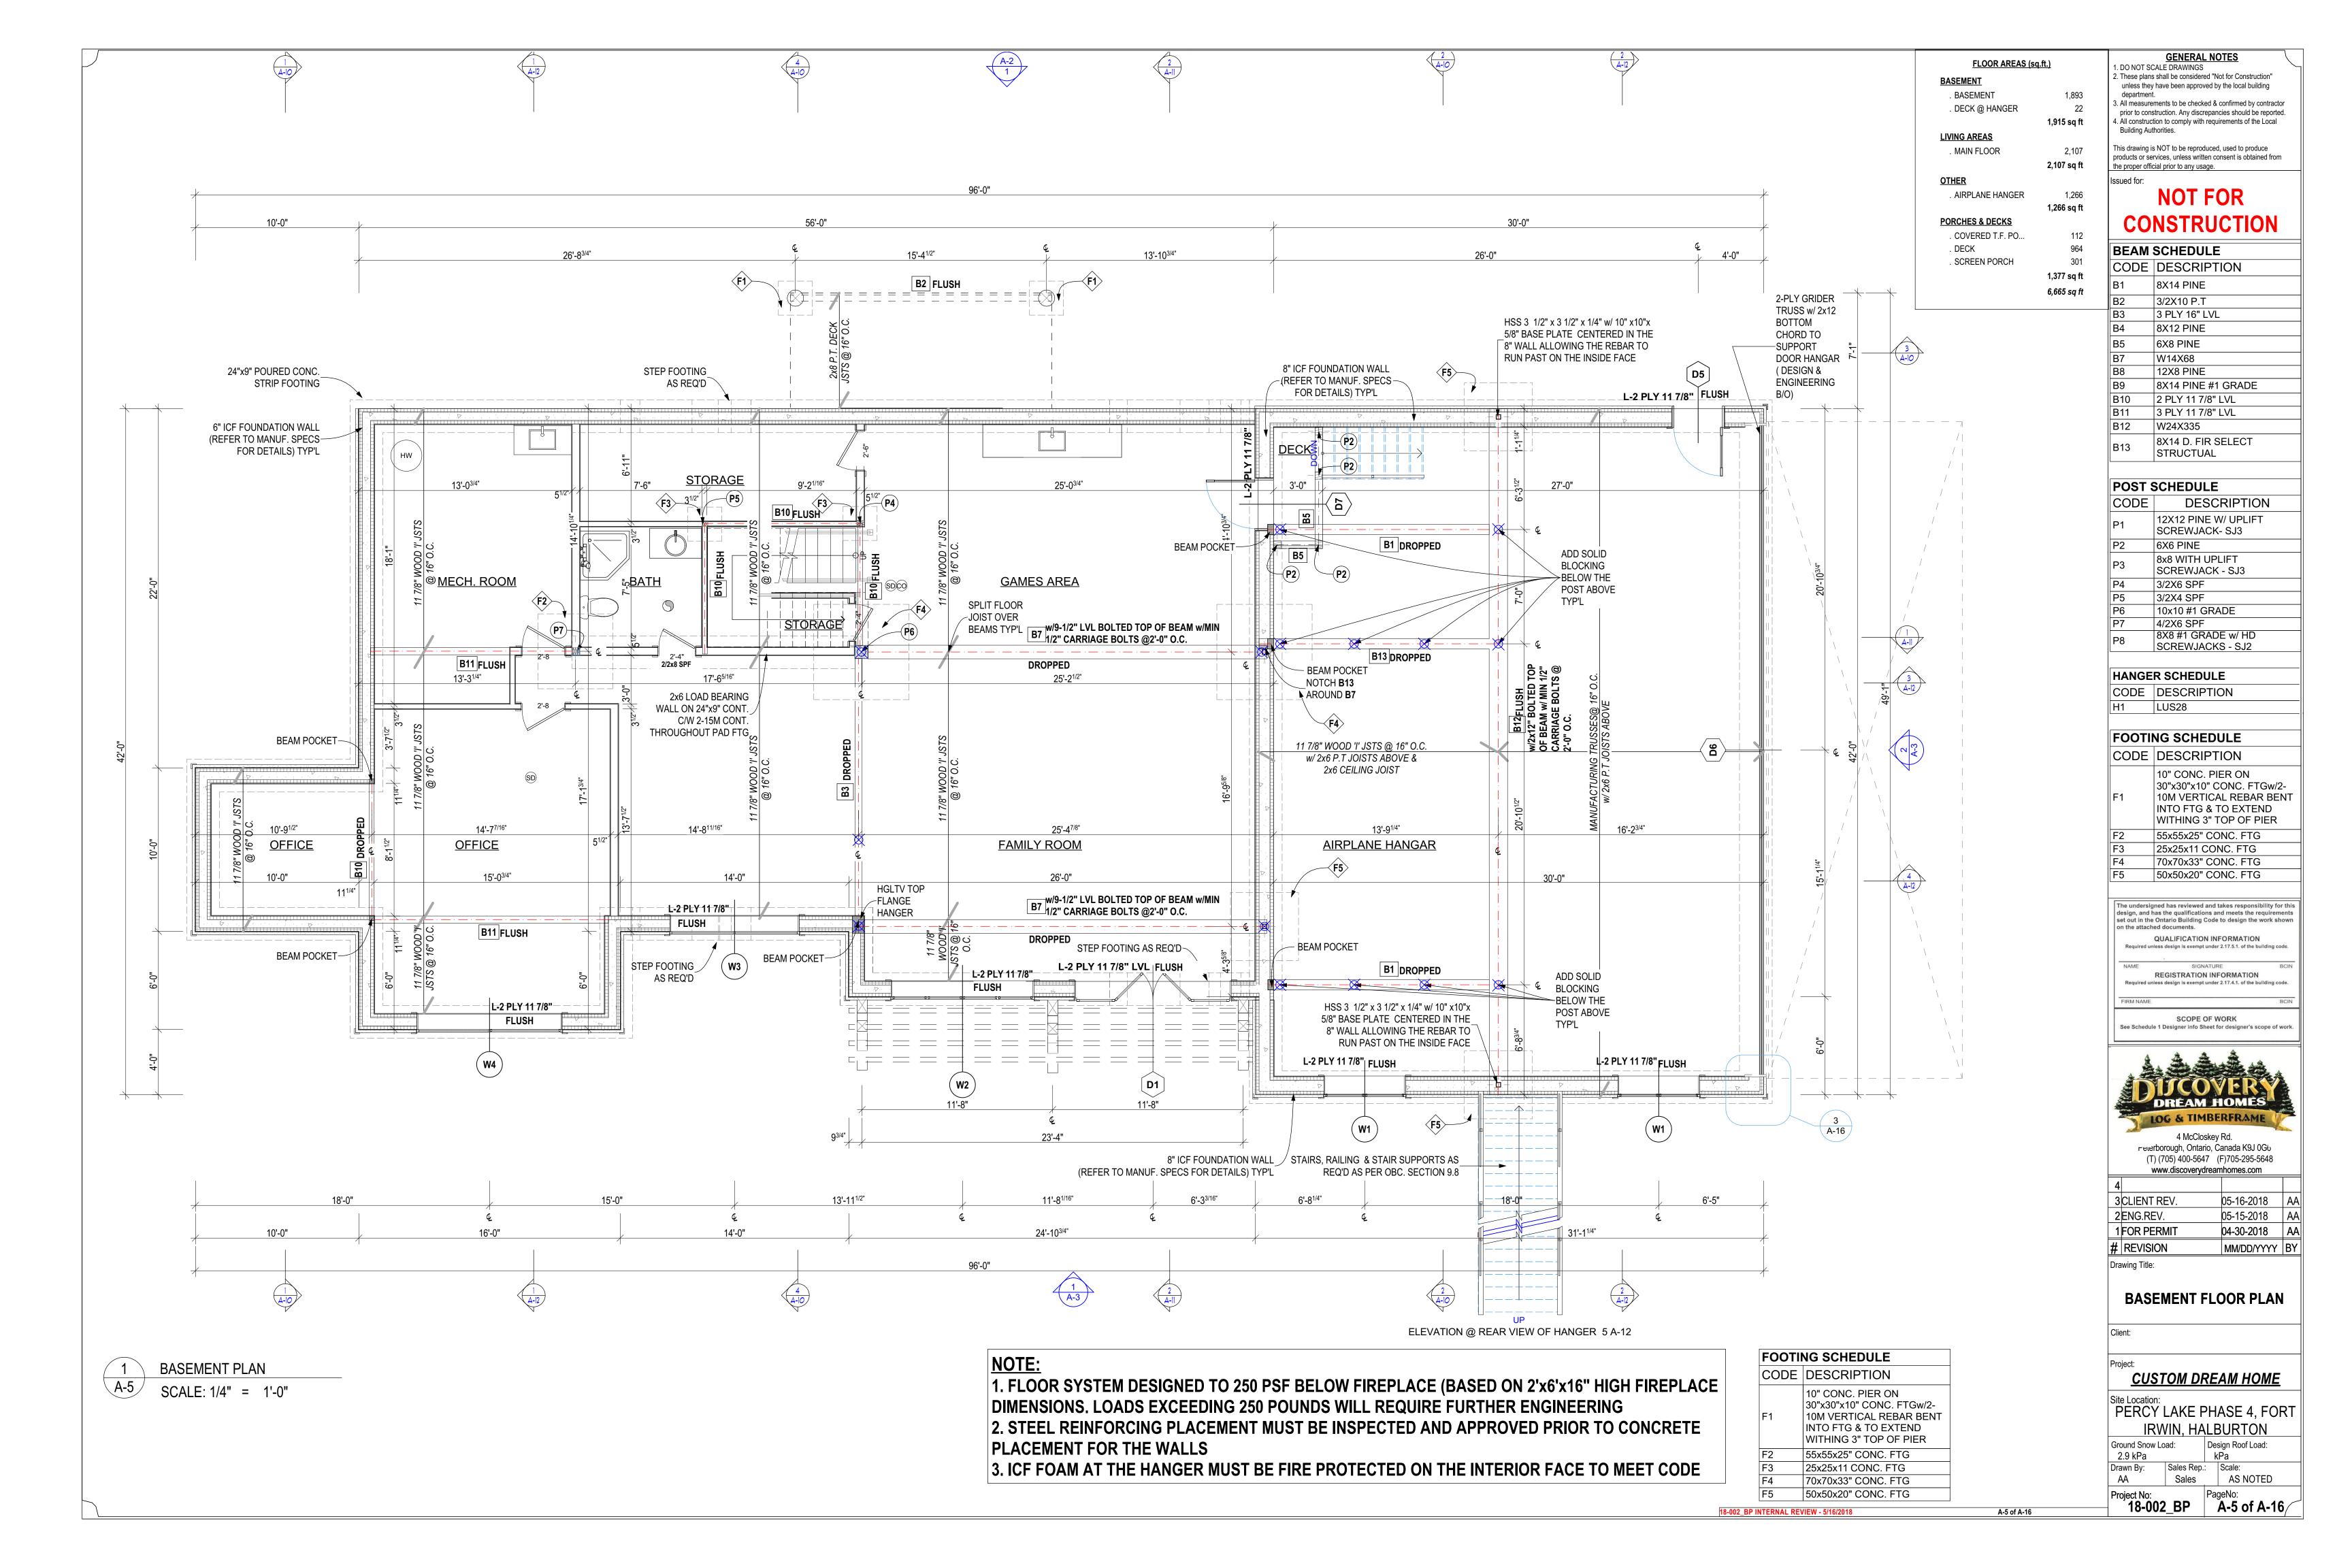

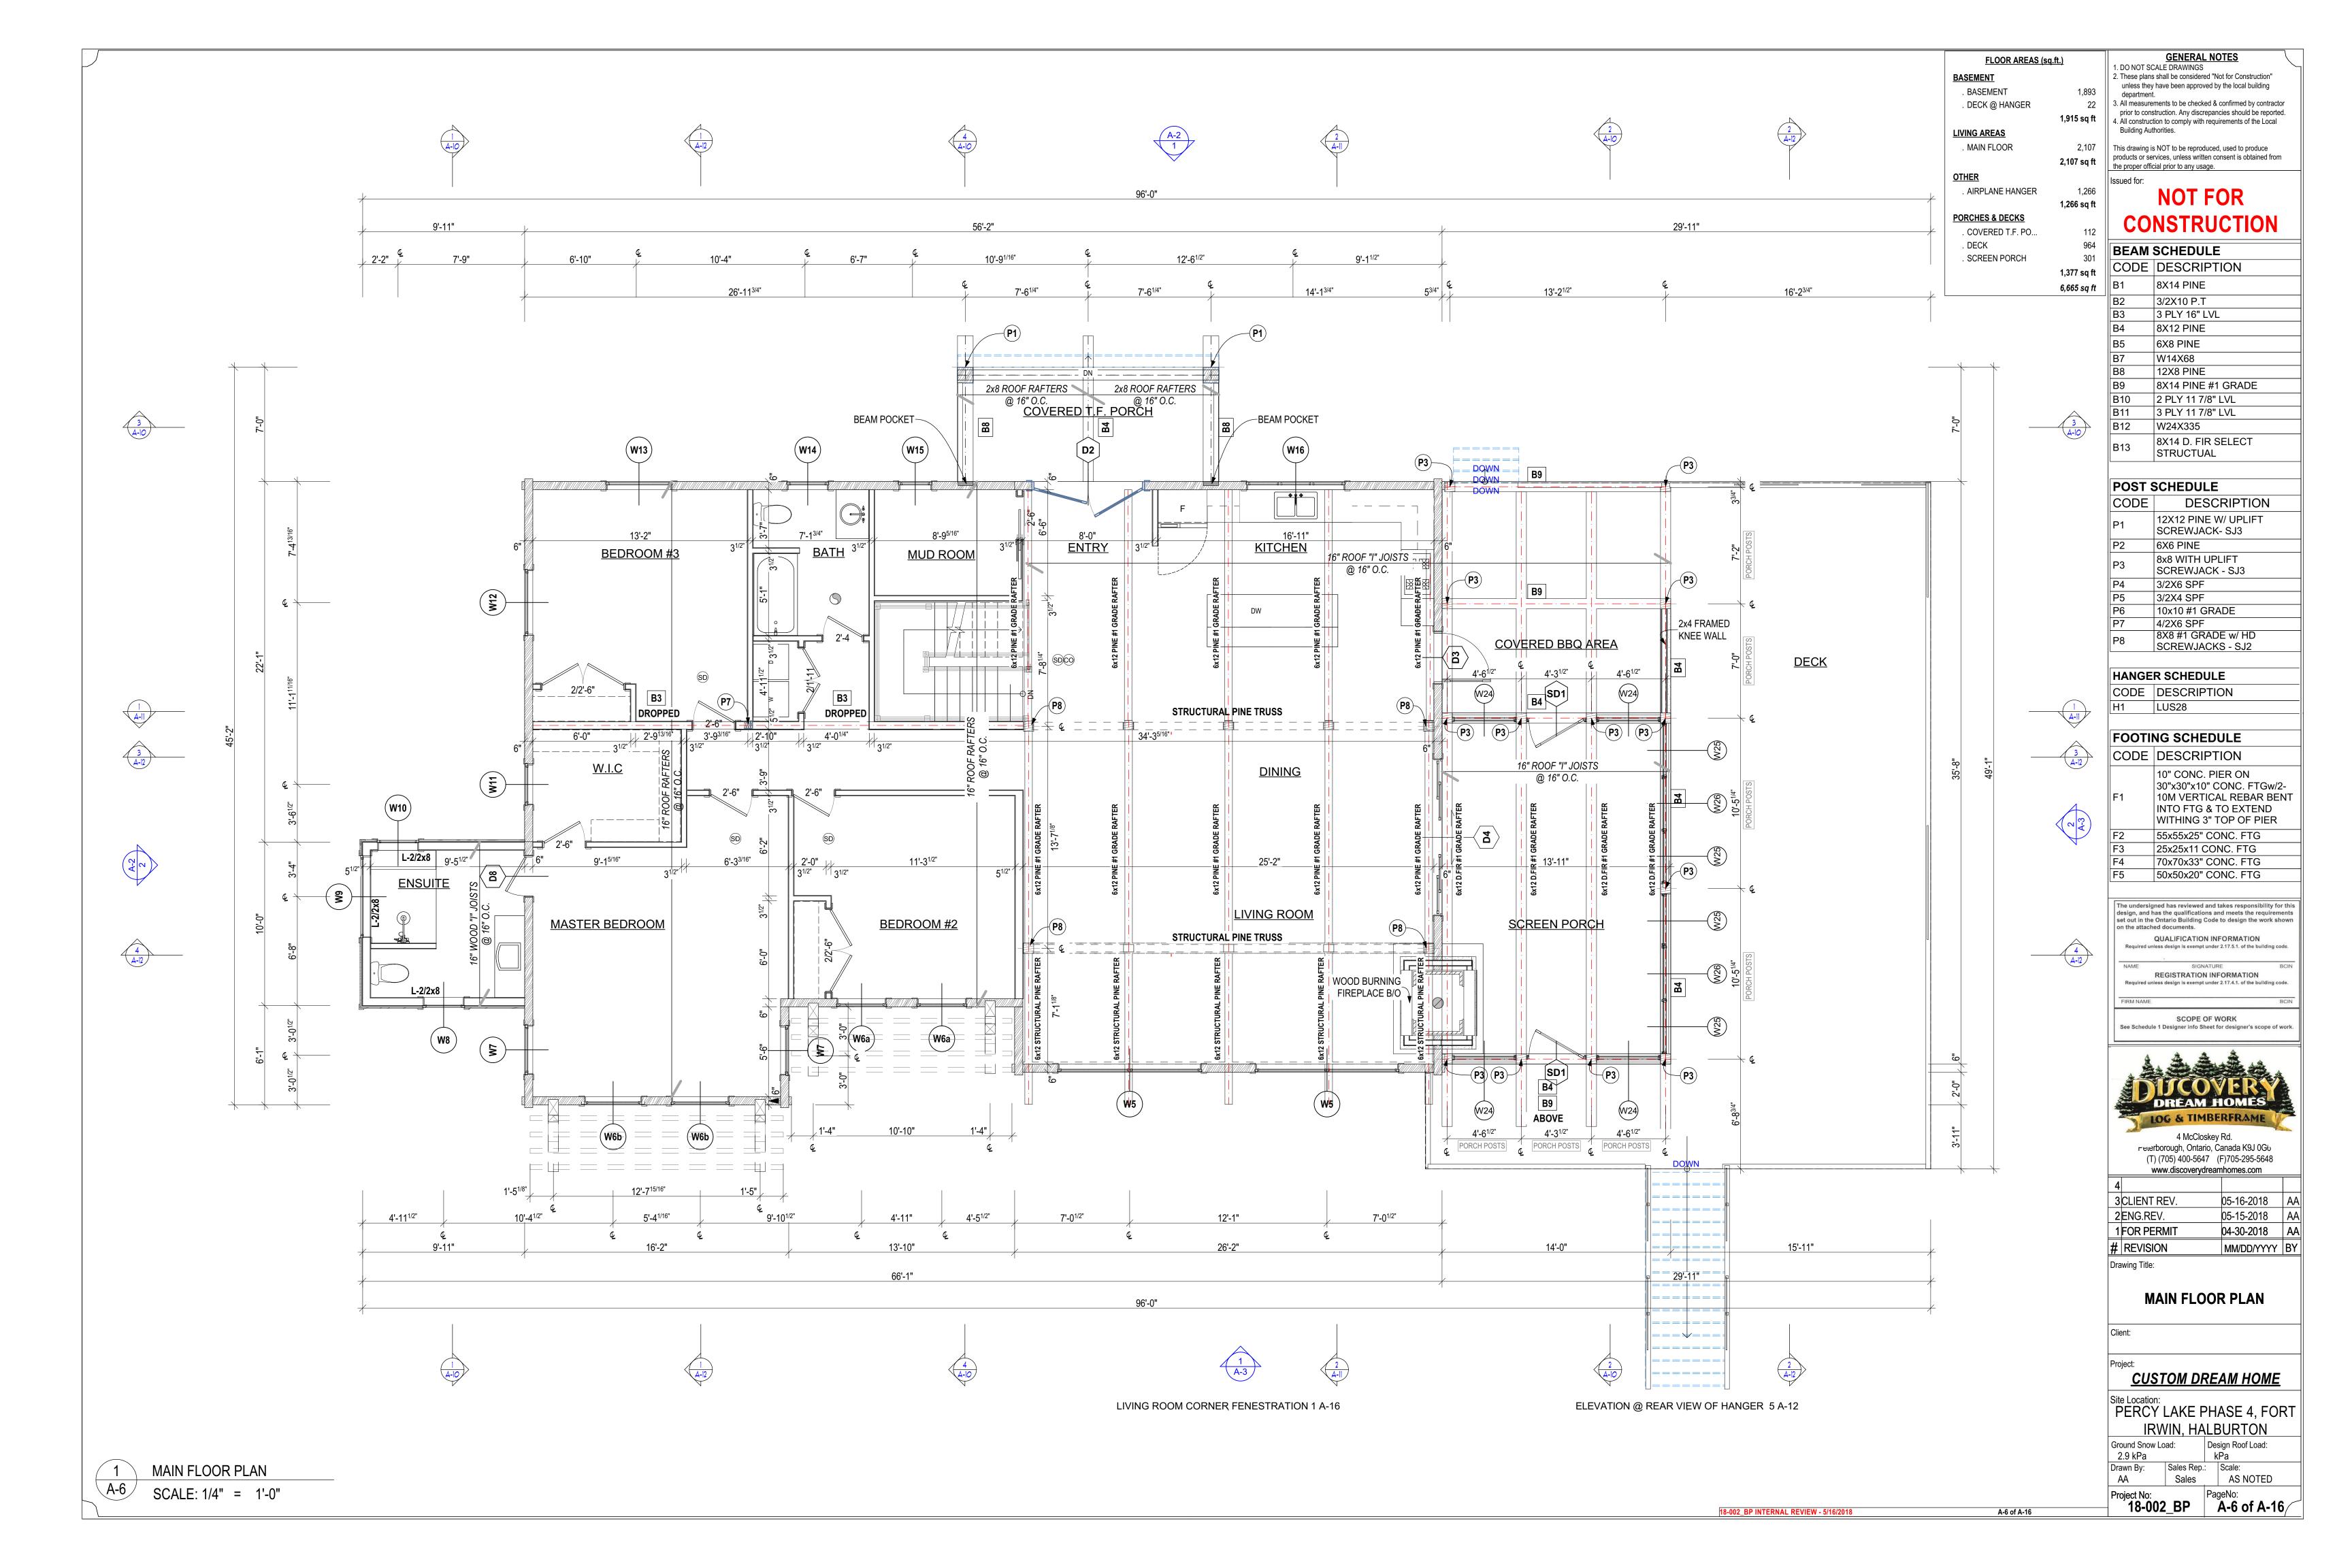

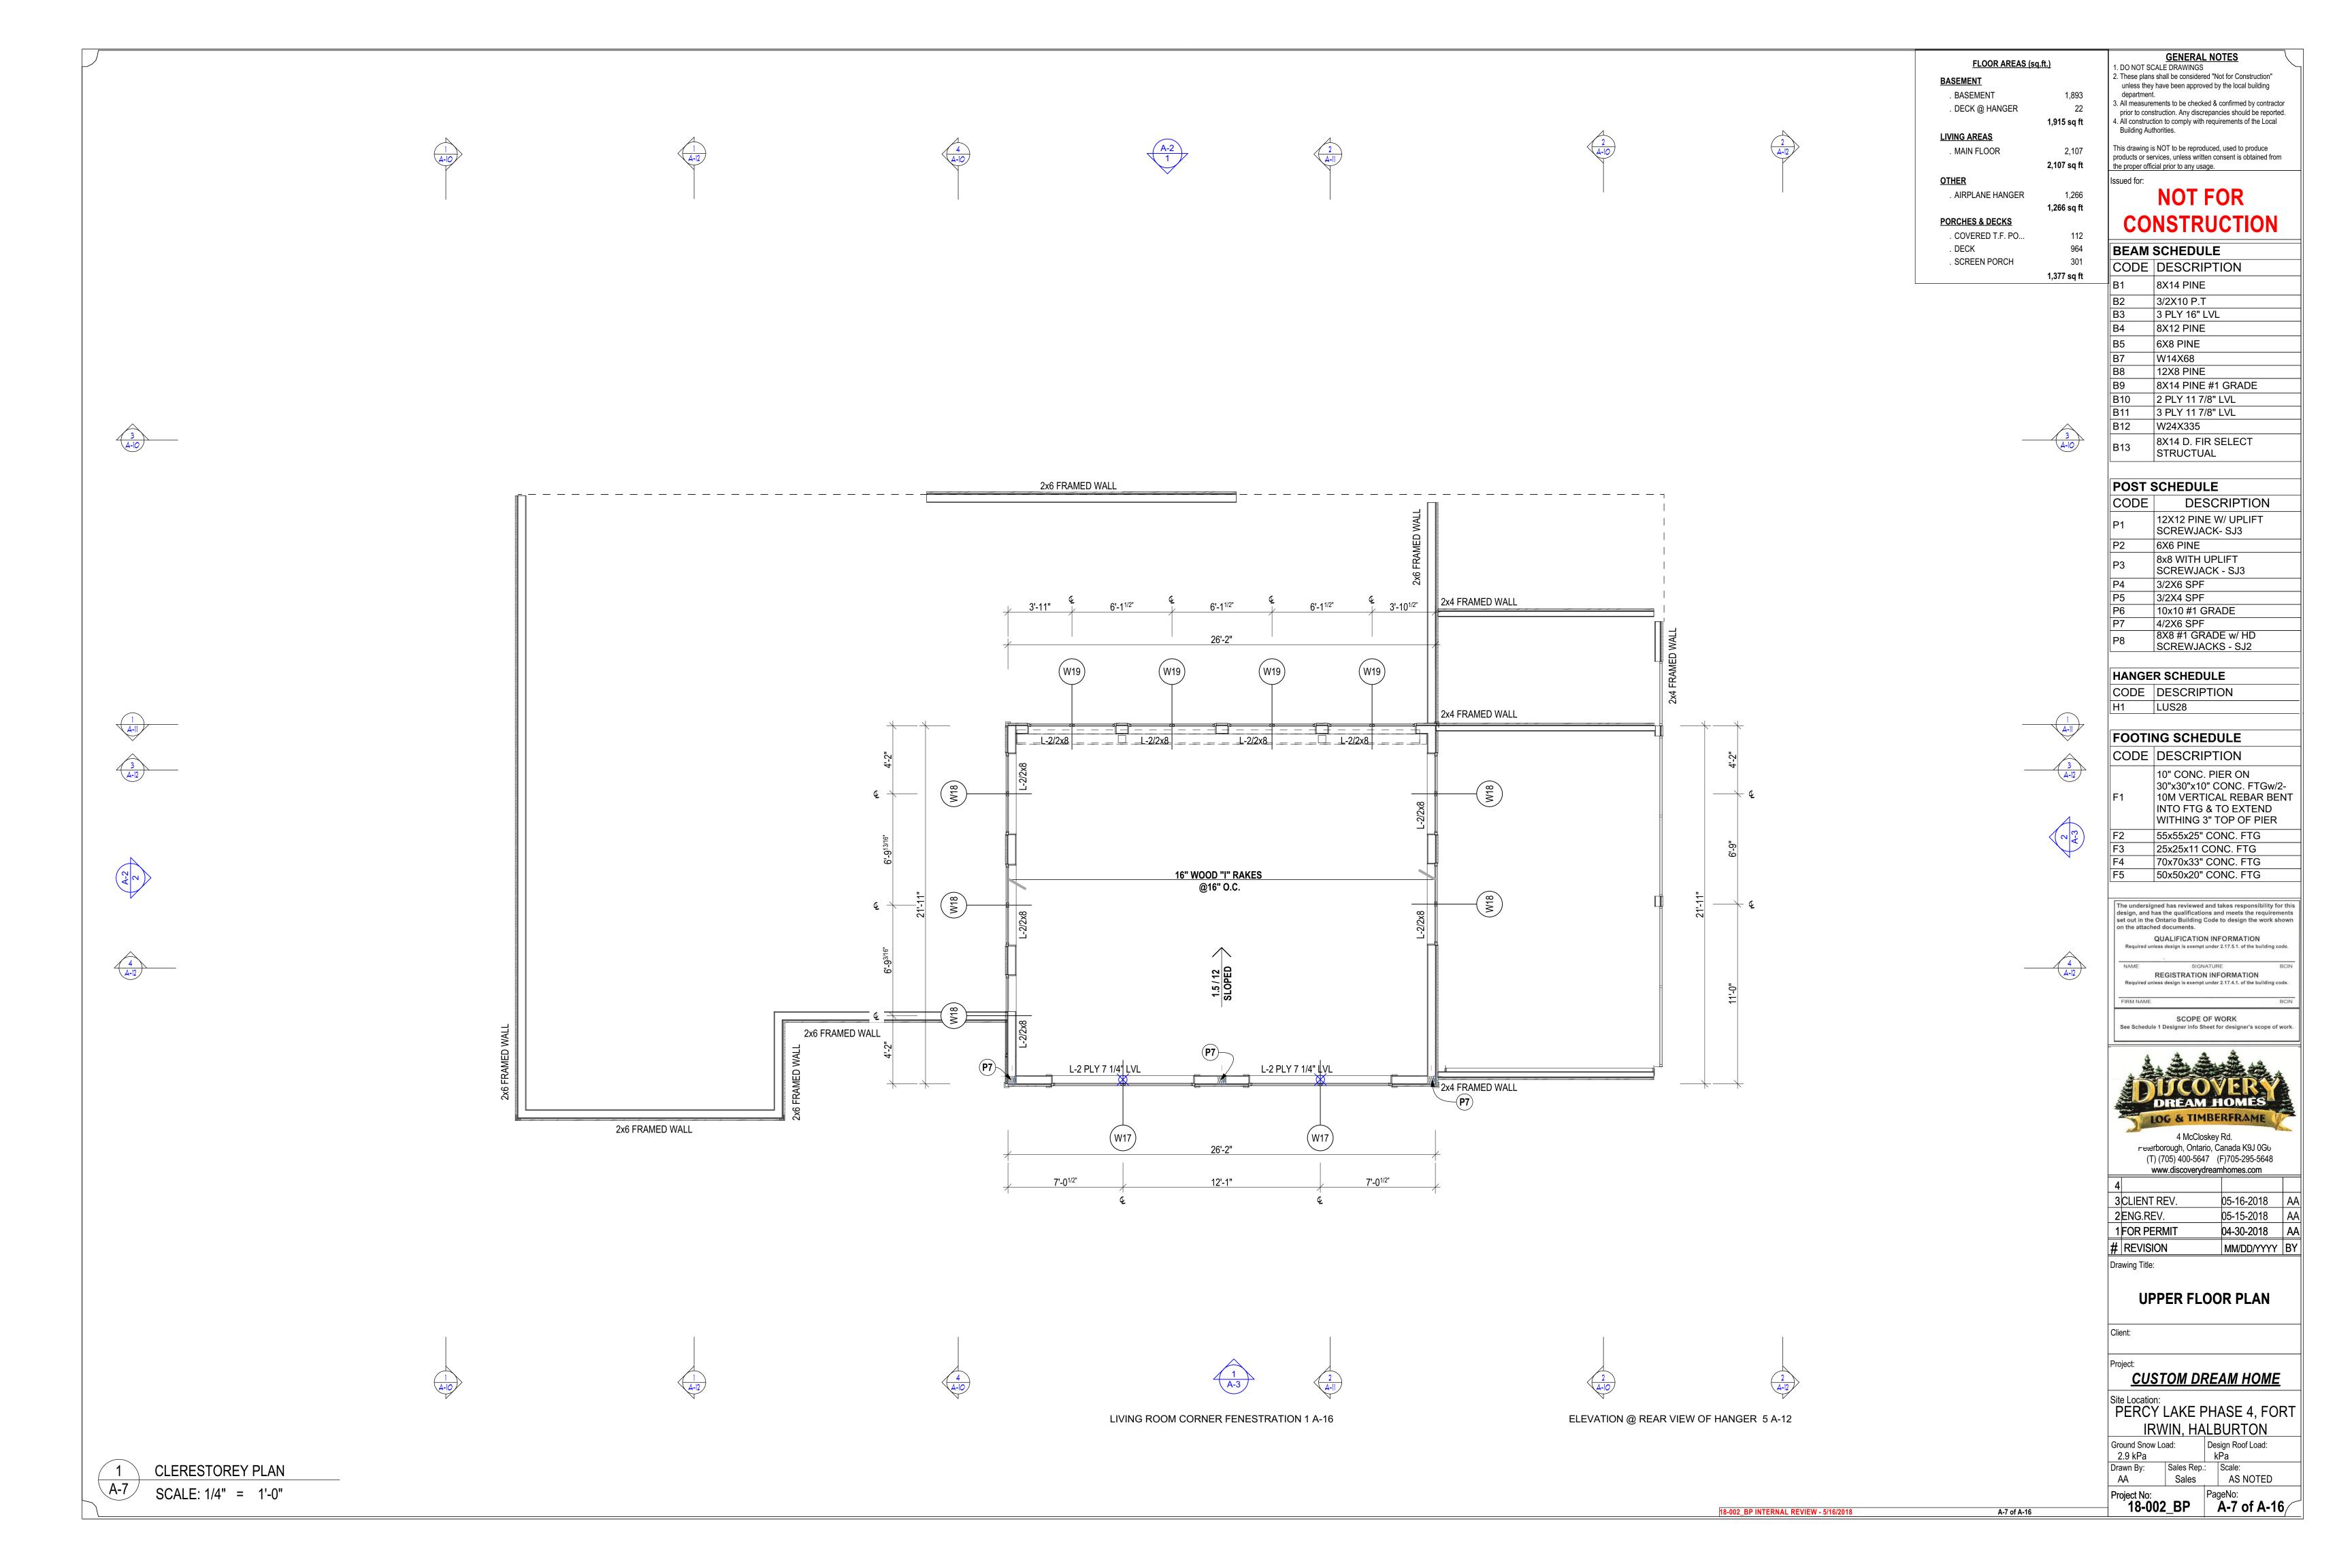

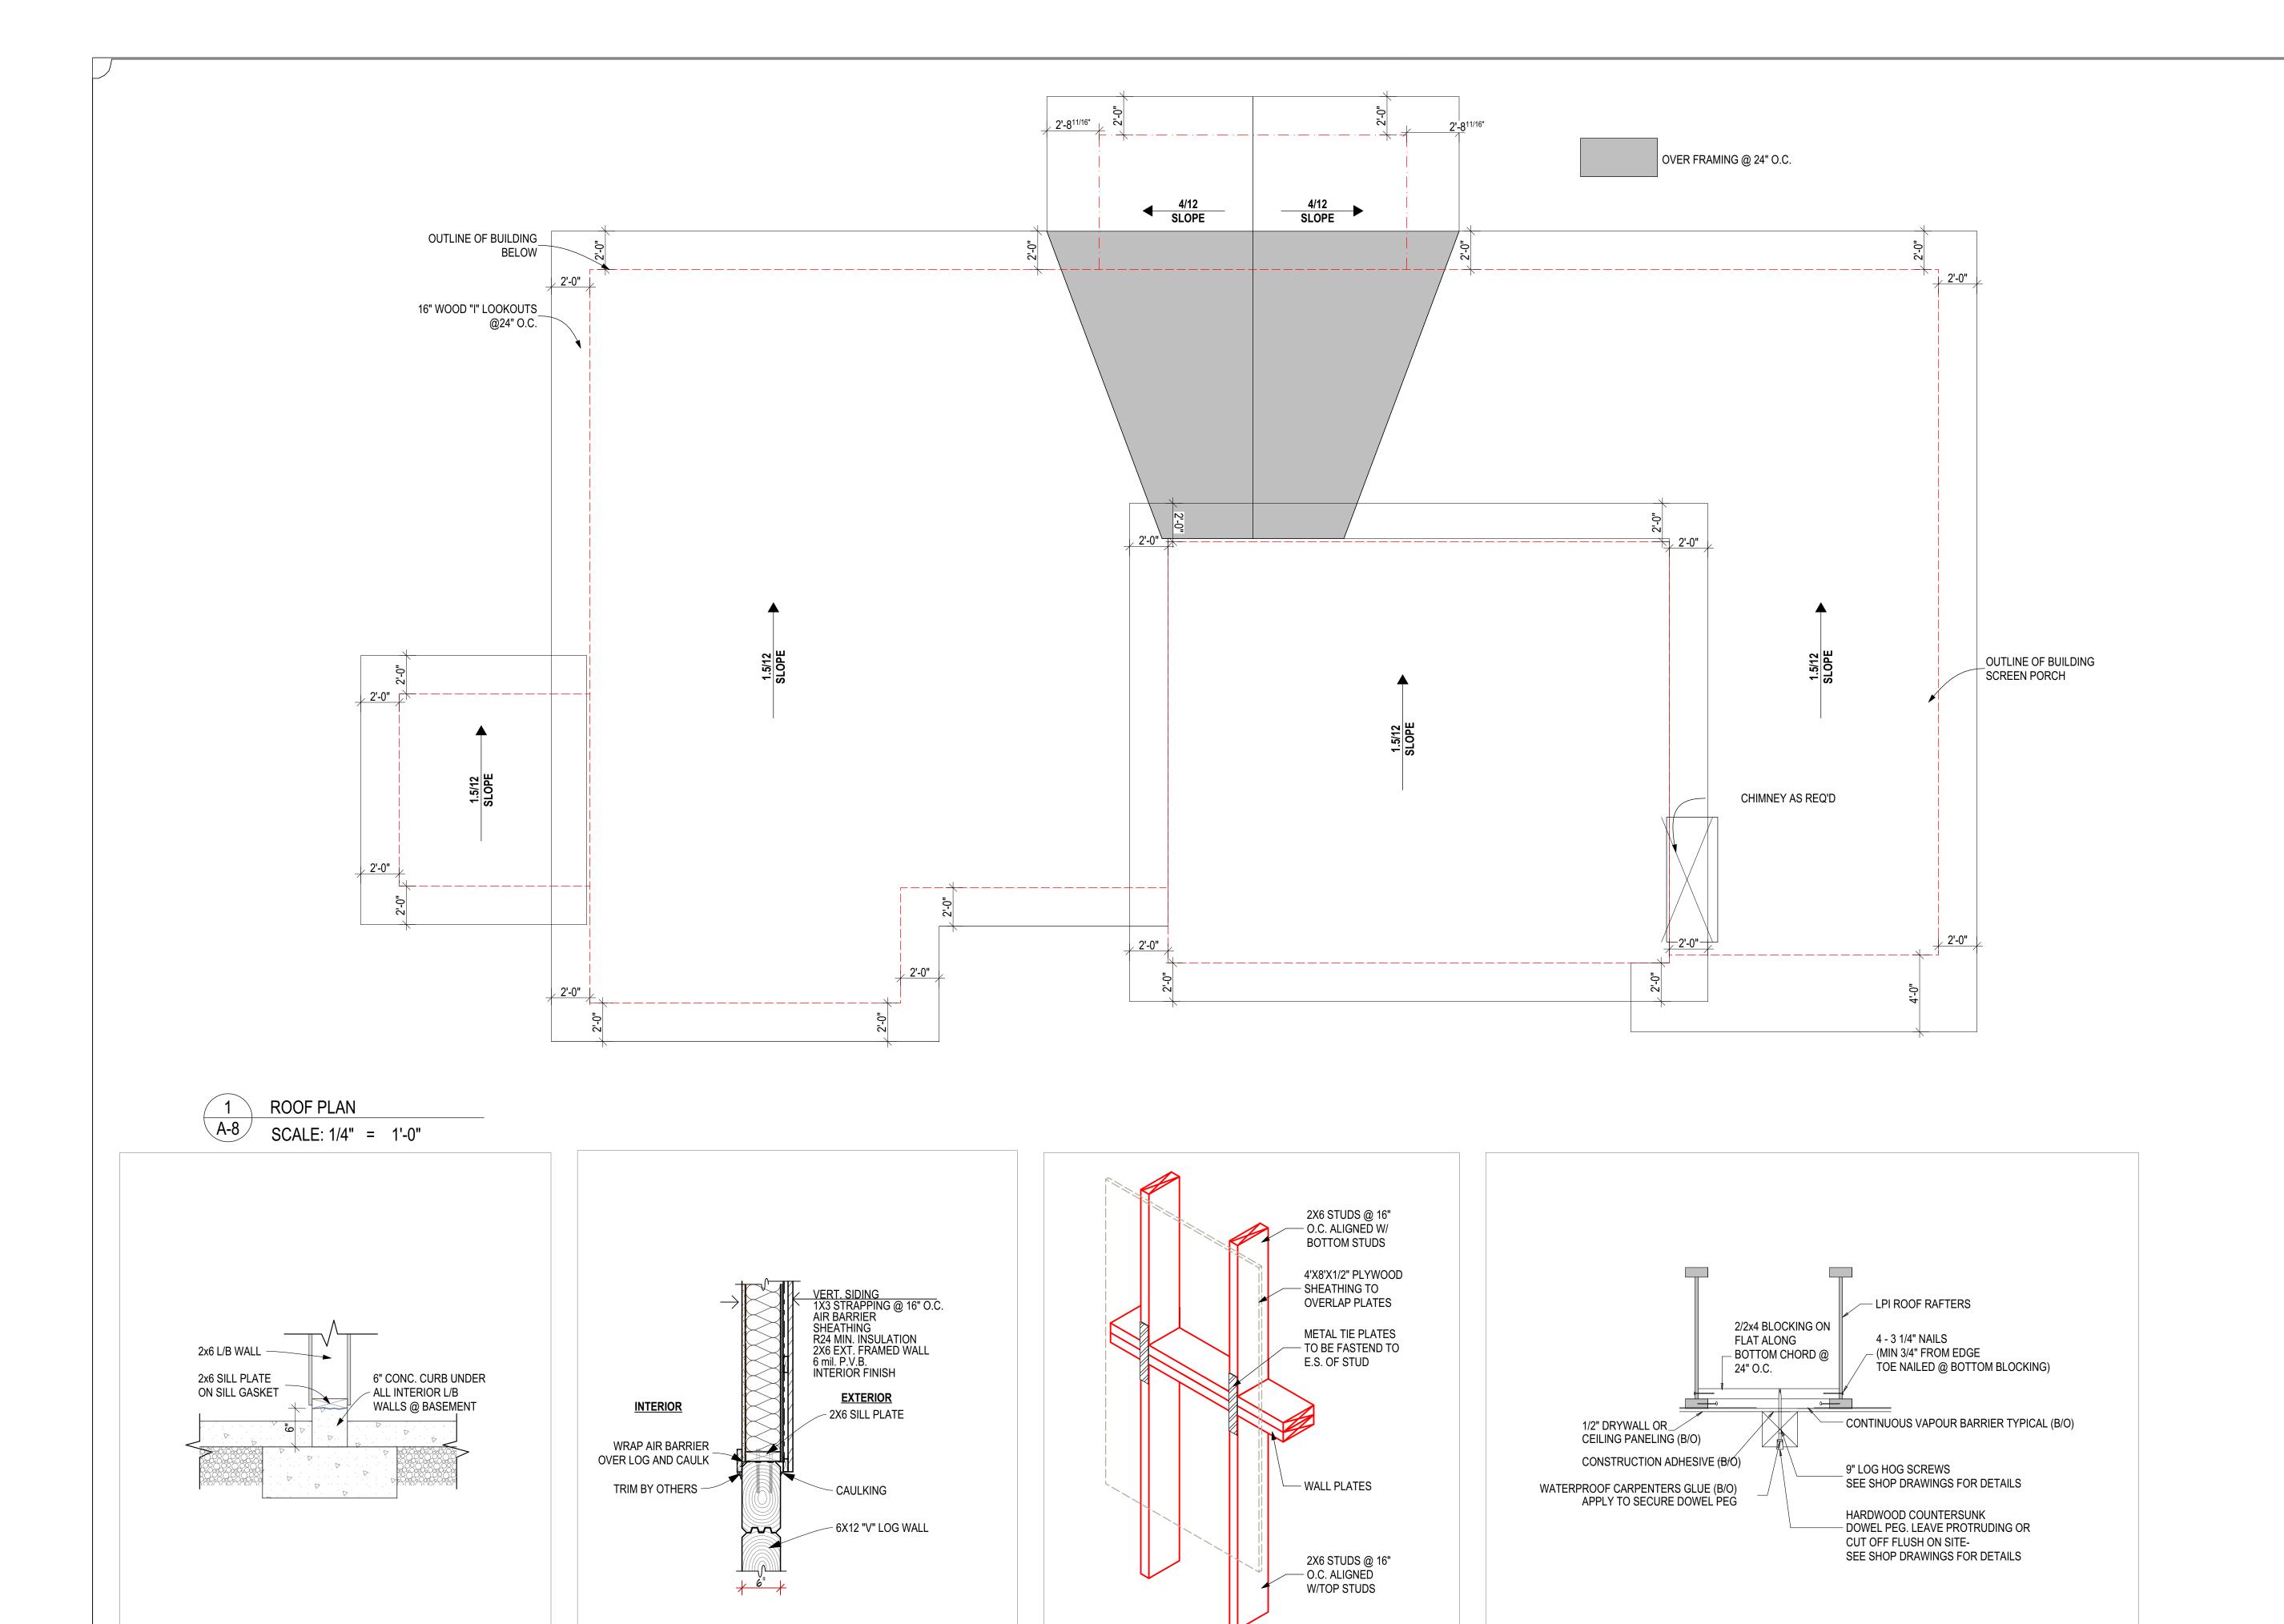

TALL WALL CONNECTION DETAIL

SCALE: 1" = 1'-0"

3 6x12 LOG w/1x8 VERT.PREFIN.SIDING GABLE WALL ABOVE

A-8 SCALE: 1" = 1'-0"

CONC. CURB DETAIL @ INT. L/B WALLS

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prior to construction. Any discrepancies should be reported. 4. All construction to comply with requirements of the Local Building Authorities.

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### **NOT FOR**

BEAM	SCHEDULE
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B2	3/2X10 P.T
B3	3 PLY 16" LVL
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POST SCHEDULE	
CODE	DESCRIPTION
P1	12X12 PINE W/ UPLIFT SCREWJACK- SJ3
P2	6X6 PINE
P3	8x8 WITH UPLIFT SCREWJACK - SJ3
P4	3/2X6 SPF
P5	3/2X4 SPF
P6	10x10 #1 GRADE
P7	4/2X6 SPF
P8	8X8 #1 GRADE w/ HD SCREWJACKS - SJ2

HANGER SCHEDULE		
CODE	DESCRIPTION	
H1	LUS28	

#### FOOTING SCHEDULE CODE DESCRIPTION

F1	10" CONC. PIER ON 30"x30"x10" CONC. FTGw/; 10M VERTICAL REBAR BE INTO FTG & TO EXTEND WITHING 3" TOP OF PIER
F2	55x55x25" CONC. FTG
F3	25x25x11 CONC. FTG
F4	70x70x33" CONC. FTG
F5	50x50x20" CONC. FTG

The undersigned has reviewed and takes responsibility for this design, and has the qualifications and meets the requirements set out in the Ontario Building Code to design the work shown

on the attached documents. QUALIFICATION INFORMATION Required unless design is exempt under 2.17.5.1. of the building code

REGISTRATION INFORMATION

See Schedule 1 Designer info Sheet for designer's scope of work

SCOPE OF WORK



4 McCloskey Rd. recerborough, Ontario, Canada K9J 0G6 (T) (705) 400-5647 (F)705-295-5648 www.discoverydreamhomes.com

4			
3	CLIENT REV.	05-16-2018	AA
2	ENG.REV.	05-15-2018	AA
1	FOR PERMIT	04-30-2018	AA
#	REVISION	MM/DD/YYYY	BY

Drawing Title:

### **ROOF PLAN & DETAILS**

**CUSTOM DREAM HOME** 

Site Location:
PERCY LAKE PHASE 4, FORT IRWIN, HALBURTON

Ground Snow Load: Design Roof Load: 2.9 kPa Sales Rep.: Scale: Drawn By: Sales AS NOTED Project No:


18-002\_BP INTERNAL REVIEW - 5/16/2018

DECORATIVE TIMBER FRAME CONNECTION DETAIL TO BLOCKING

SCALE: 1' = 1'-0"

A-8 of A-16

18-002\_BP A-8 of A-16/

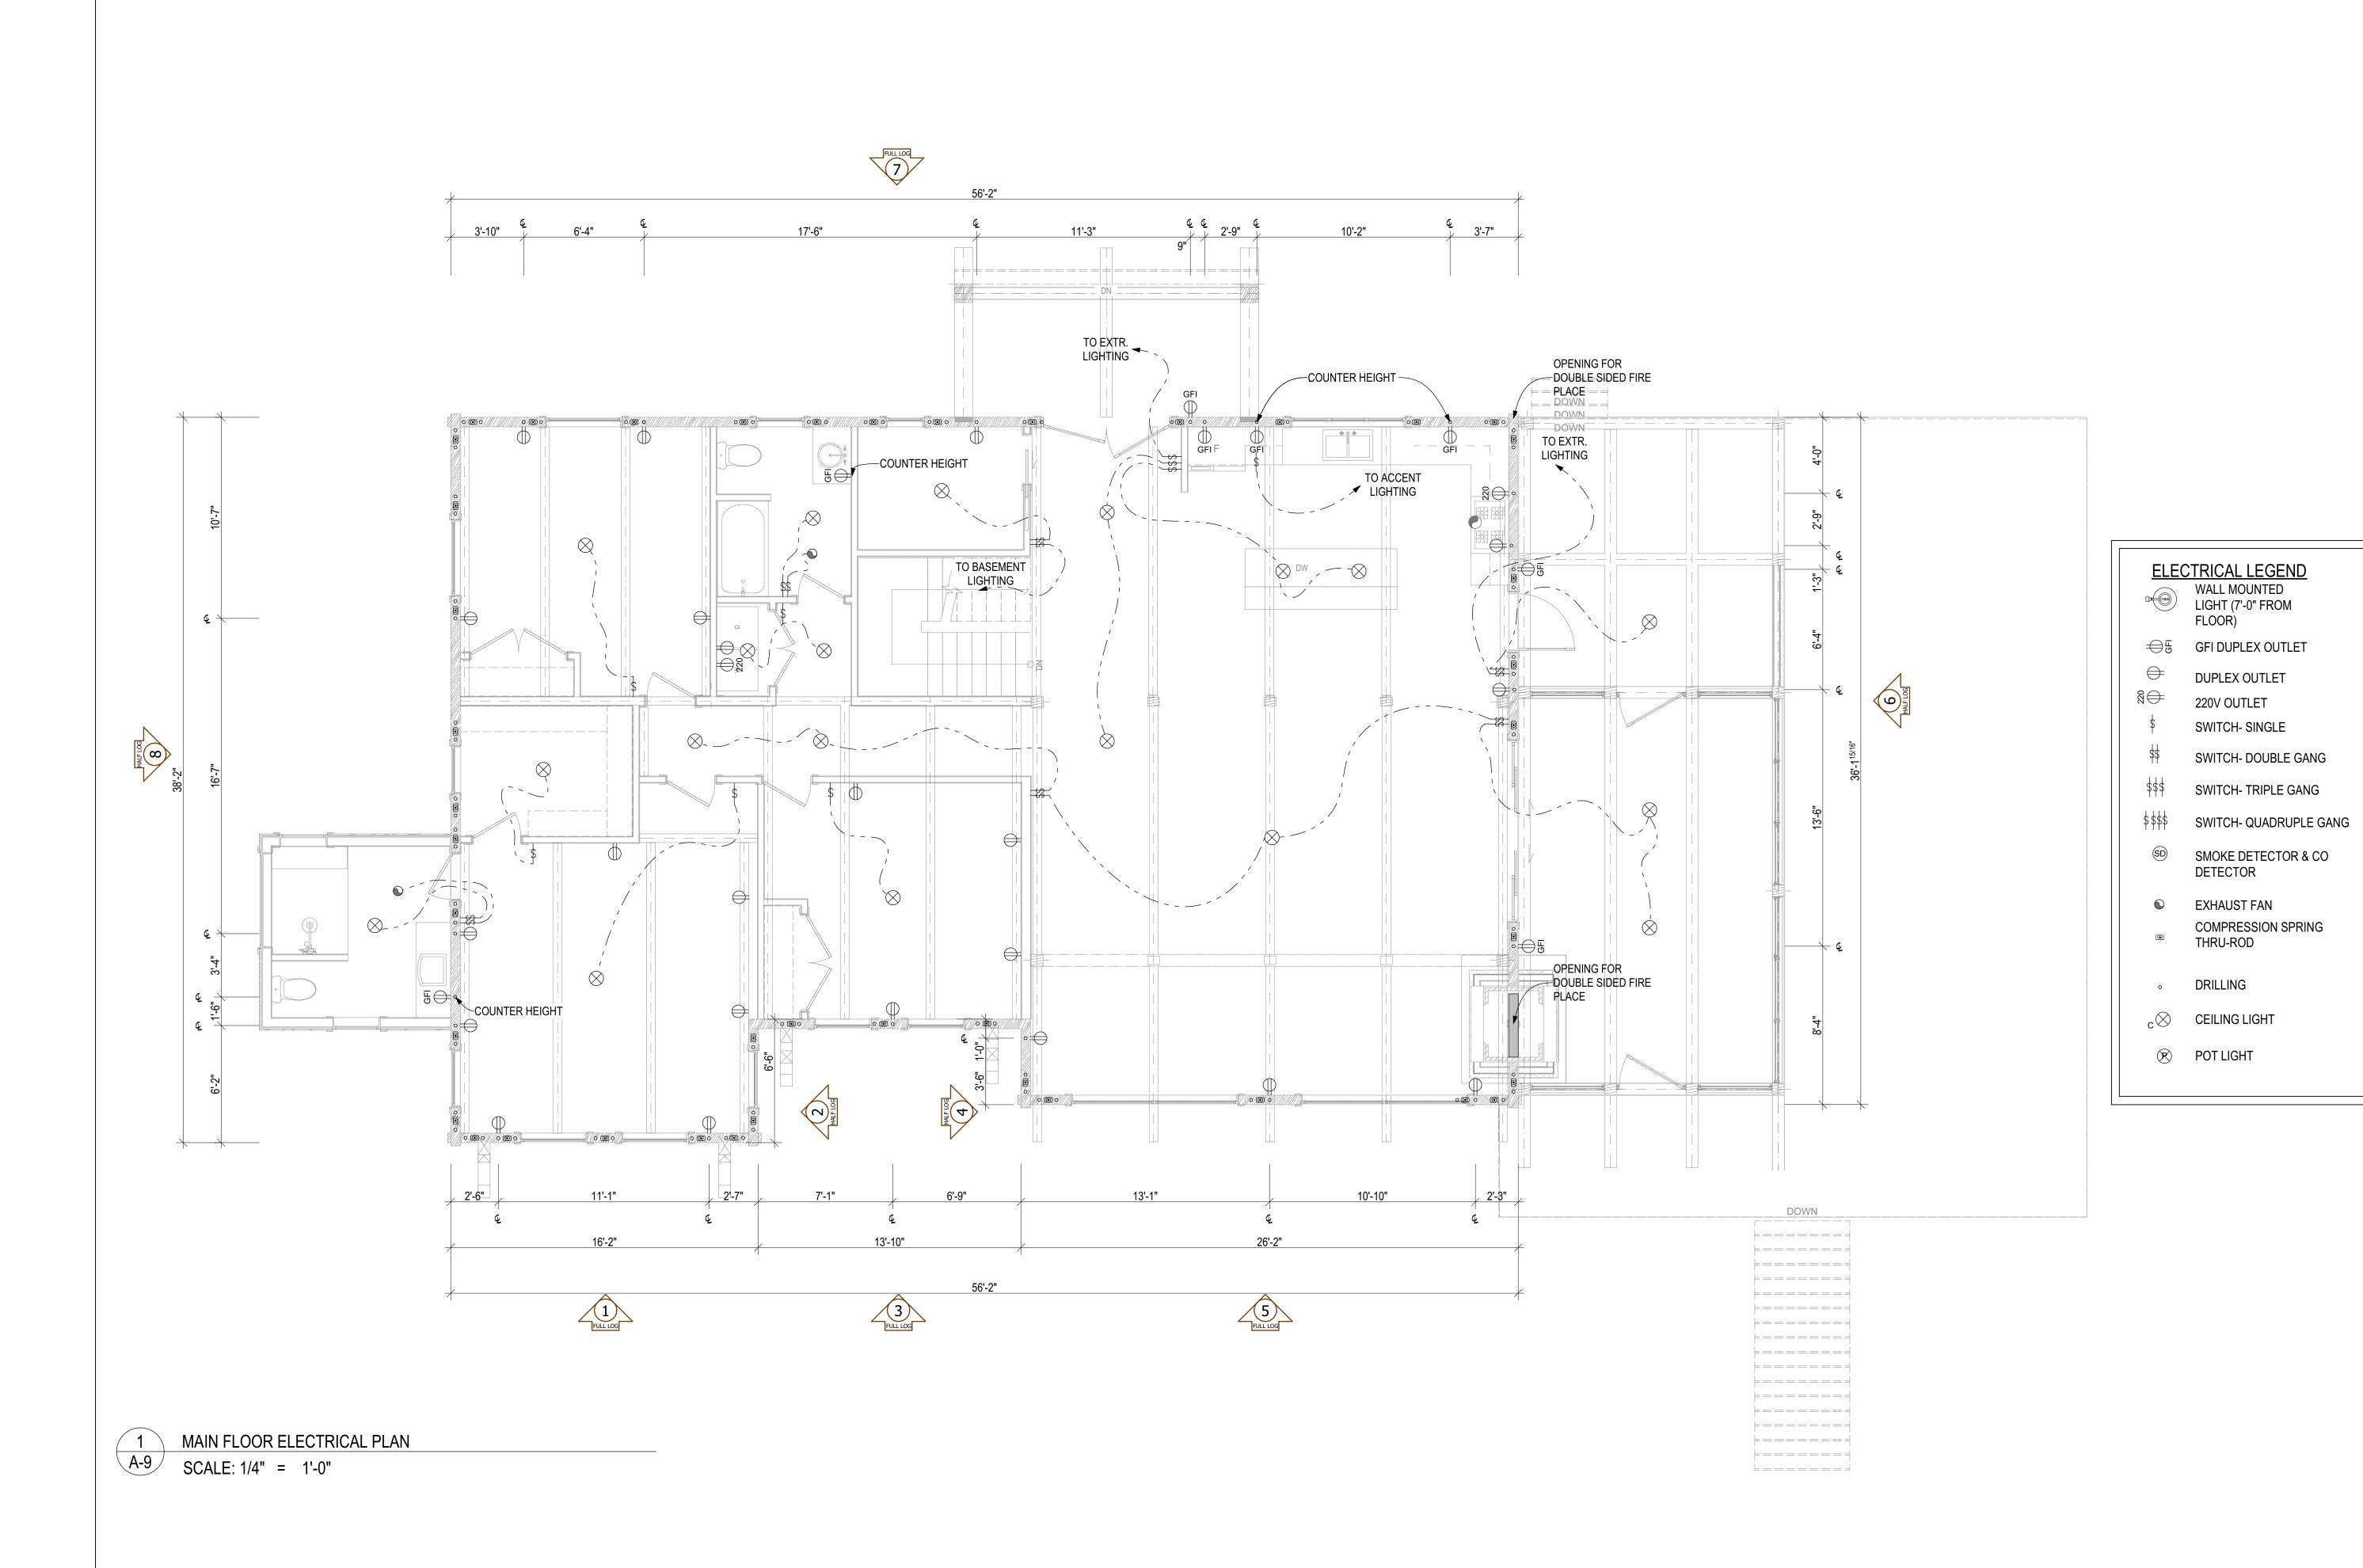

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### **NOT FOR**

### CONSTRUCTION

BEAM	SCHEDULE
CODE	DESCRIPTION
B1	8X14 PINE
B2	3/2X10 P.T
B3	3 PLY 16" LVL
B4	8X12 PINE
B5	6X8 PINE
B7	W14X68
B8	12X8 PINE
B9	8X14 PINE #1 GRADE
B10	2 PLY 11 7/8" LVL
B11	3 PLY 11 7/8" LVL
B12	W24X335
B13	8X14 D. FIR SELECT STRUCTUAL

POST SCHEDULE	
DESCRIPTION	
12X12 PINE W/ UPLIFT SCREWJACK- SJ3	
6X6 PINE	
8x8 WITH UPLIFT SCREWJACK - SJ3	
3/2X6 SPF	
3/2X4 SPF	
10x10 #1 GRADE	
4/2X6 SPF	
8X8 #1 GRADE w/ HD SCREWJACKS - SJ2	

HANGE	R SCHEDULE
	DESCRIPTION
H1	LUS28

### FOOTING SCHEDULE CODE DESCRIPTION

- 1		
	F1	10" CONC. PIER ON 30"x30"x10" CONC. FTGw/2- 10M VERTICAL REBAR BENT INTO FTG & TO EXTEND WITHING 3" TOP OF PIER
	F2	55x55x25" CONC. FTG
	F3	25x25x11 CONC. FTG
	F4	70x70x33" CONC. FTG
	F5	50x50x20" CONC. FTG

desig	dersigned has reviewed and takes responsibility for thi and has the qualifications and meets the requirements
	in the Ontario Building Code to design the work shows attached documents.

QUALIFICATION INFORMATION d unless design is exempt under 2.17.5.1. of the building code

REGISTRATION INFORMATION

SCOPE OF WORK
See Schedule 1 Designer info Sheet for designer's scope of work



4 McCloskey Rd. reterborough, Ontario, Canada K9J 0G6 (T) (705) 400-5647 (F)705-295-5648 www.discoverydreamhomes.com

4			
3	CLIENT REV.	05-16-2018	Α
2	ENG.REV.	05-15-2018	Α
1	FOR PERMIT	04-30-2018	Α
#	REVISION	MM/DD/YYYY	B
Dra	awina Title	·	

### MAIN FLOOR ELECTRICAL **PLAN**


## **CUSTOM DREAM HOME**


Site Location:
PERCY LAKE PHASE 4, FORT IRWIN, HALBURTON Ground Snow Load: Design Roof Load: 2.9 kPa

Sales Rep.: Scale: Drawn By: AA Sales AS NOTED Project No: 18-002\_BP A-9 of A-16/

18-002\_BP INTERNAL REVIEW - 5/16/2018

A-9 of A-16

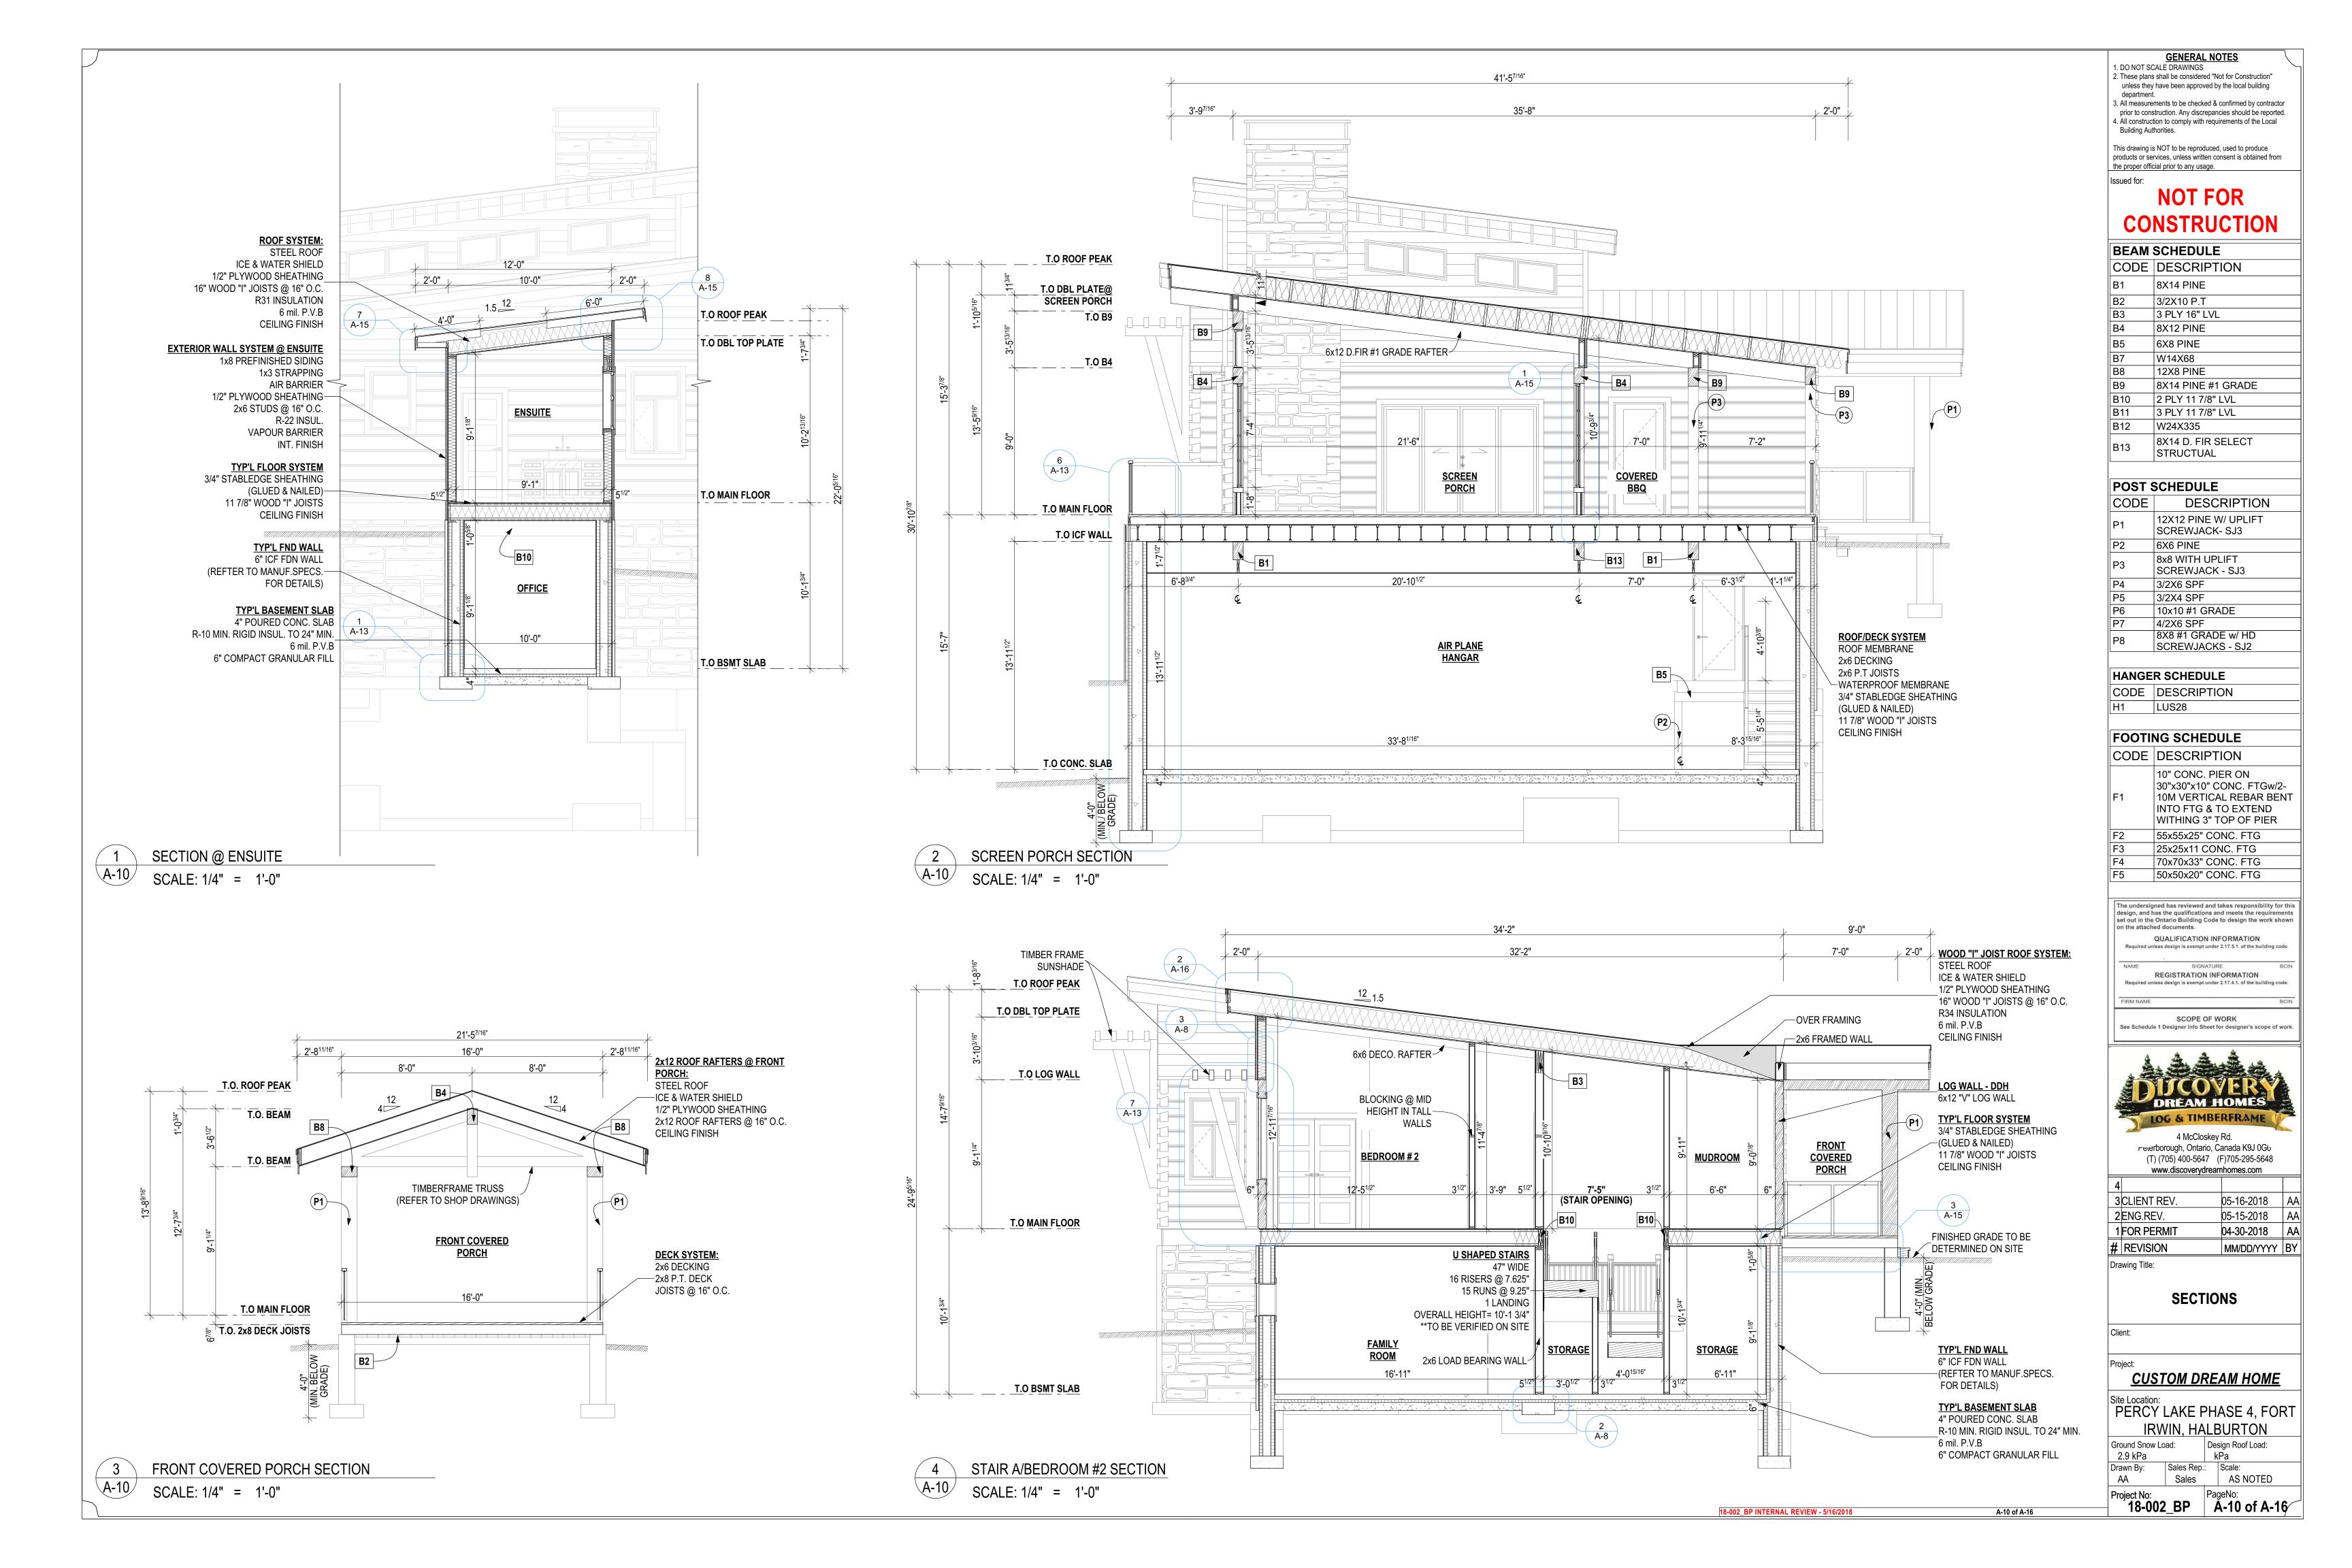

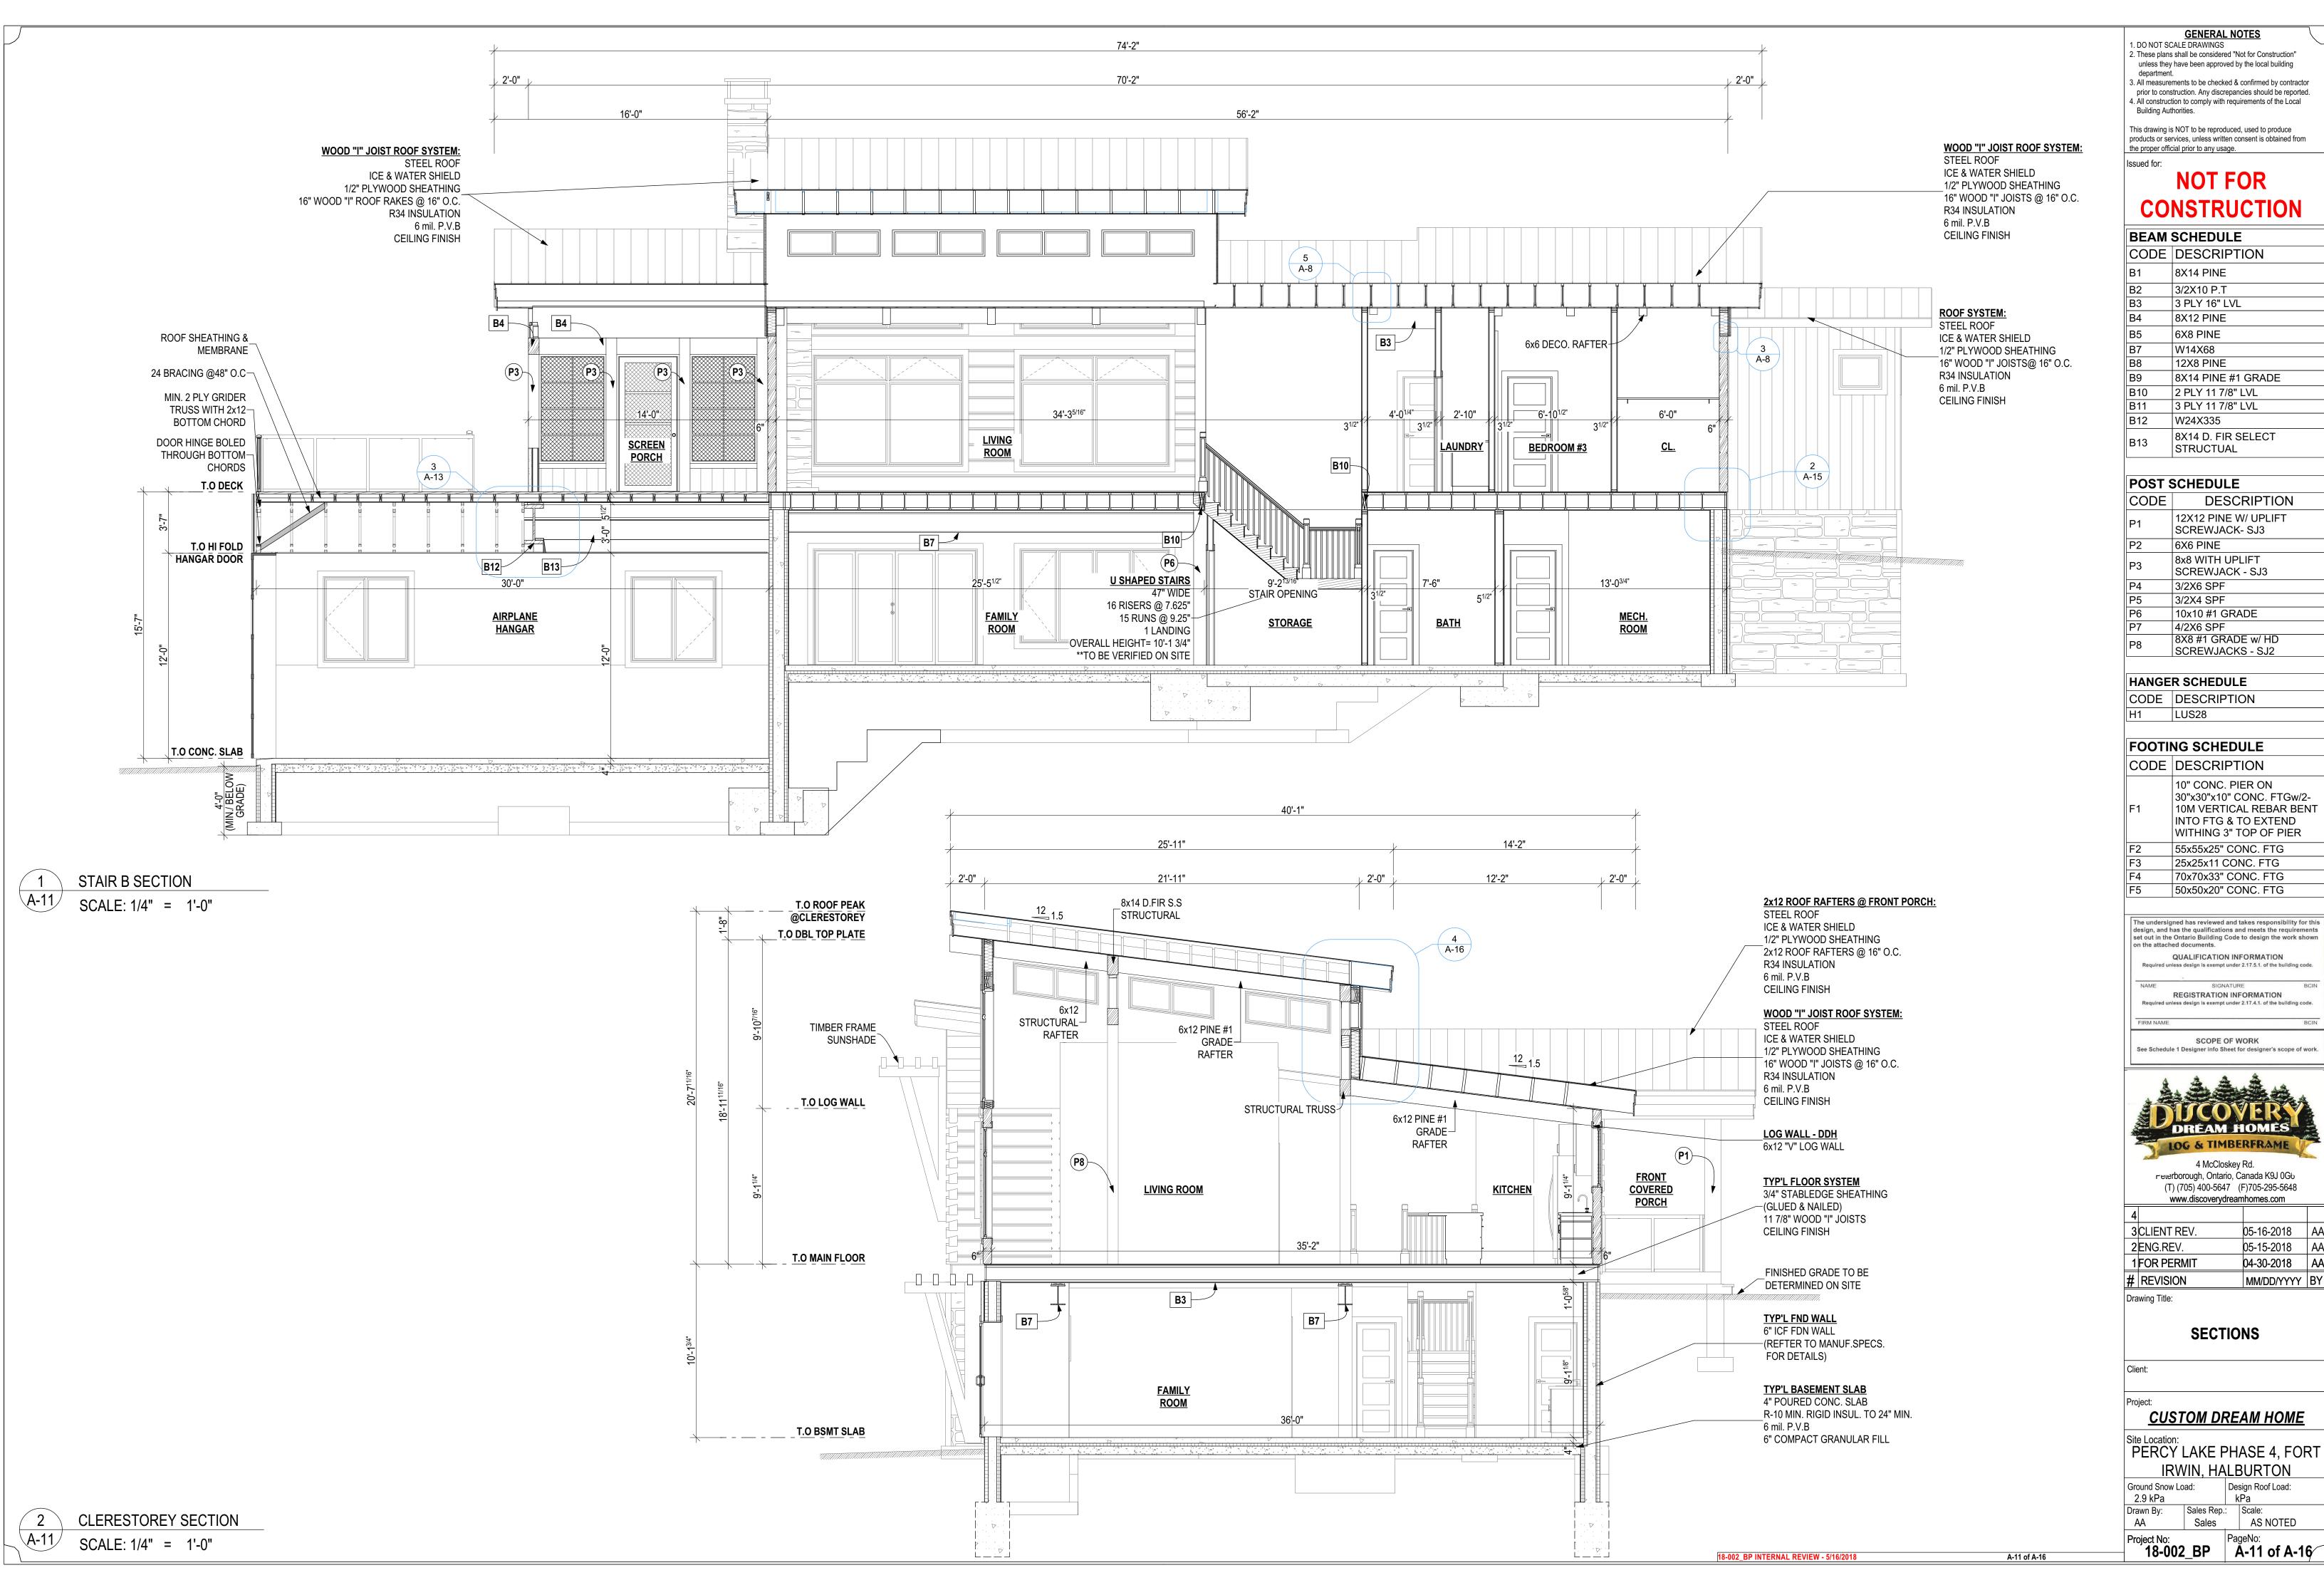


BEAM SCHEDULE			
CODE	DESCRIPTION		
B1	8X14 PINE		
B2	3/2X10 P.T		
B3	3 PLY 16" LVL		
B4	8X12 PINE		
B5	6X8 PINE		
B7	W14X68		
B8	12X8 PINE		
B9	8X14 PINE #1 GRADE		
B10	2 PLY 11 7/8" LVL		
B11	3 PLY 11 7/8" LVL		
B12	W24X335		
B13	8X14 D. FIR SELECT STRUCTUAL		
	-		


POST S	SCHEDULE
CODE	DESCRIPTION
P1	12X12 PINE W/ UPLIFT SCREWJACK- SJ3
P2	6X6 PINE
P3	8x8 WITH UPLIFT SCREWJACK - SJ3
P4	3/2X6 SPF
P5	3/2X4 SPF
P6	10x10 #1 GRADE
P7	4/2X6 SPF
DQ	8X8 #1 GRADE w/ HD


igned has reviewed and takes responsibility for this I has the qualifications and meets the requirements he Ontario Building Code to design the work shown





4				
3	CLIENT REV.	05-16-2018	ΑA	
2	ENG.REV.	05-15-2018	ΑA	
1	FOR PERMIT	04-30-2018	AA	
#	REVISION	MM/DD/YYYY	BY	
Drawing Title:				

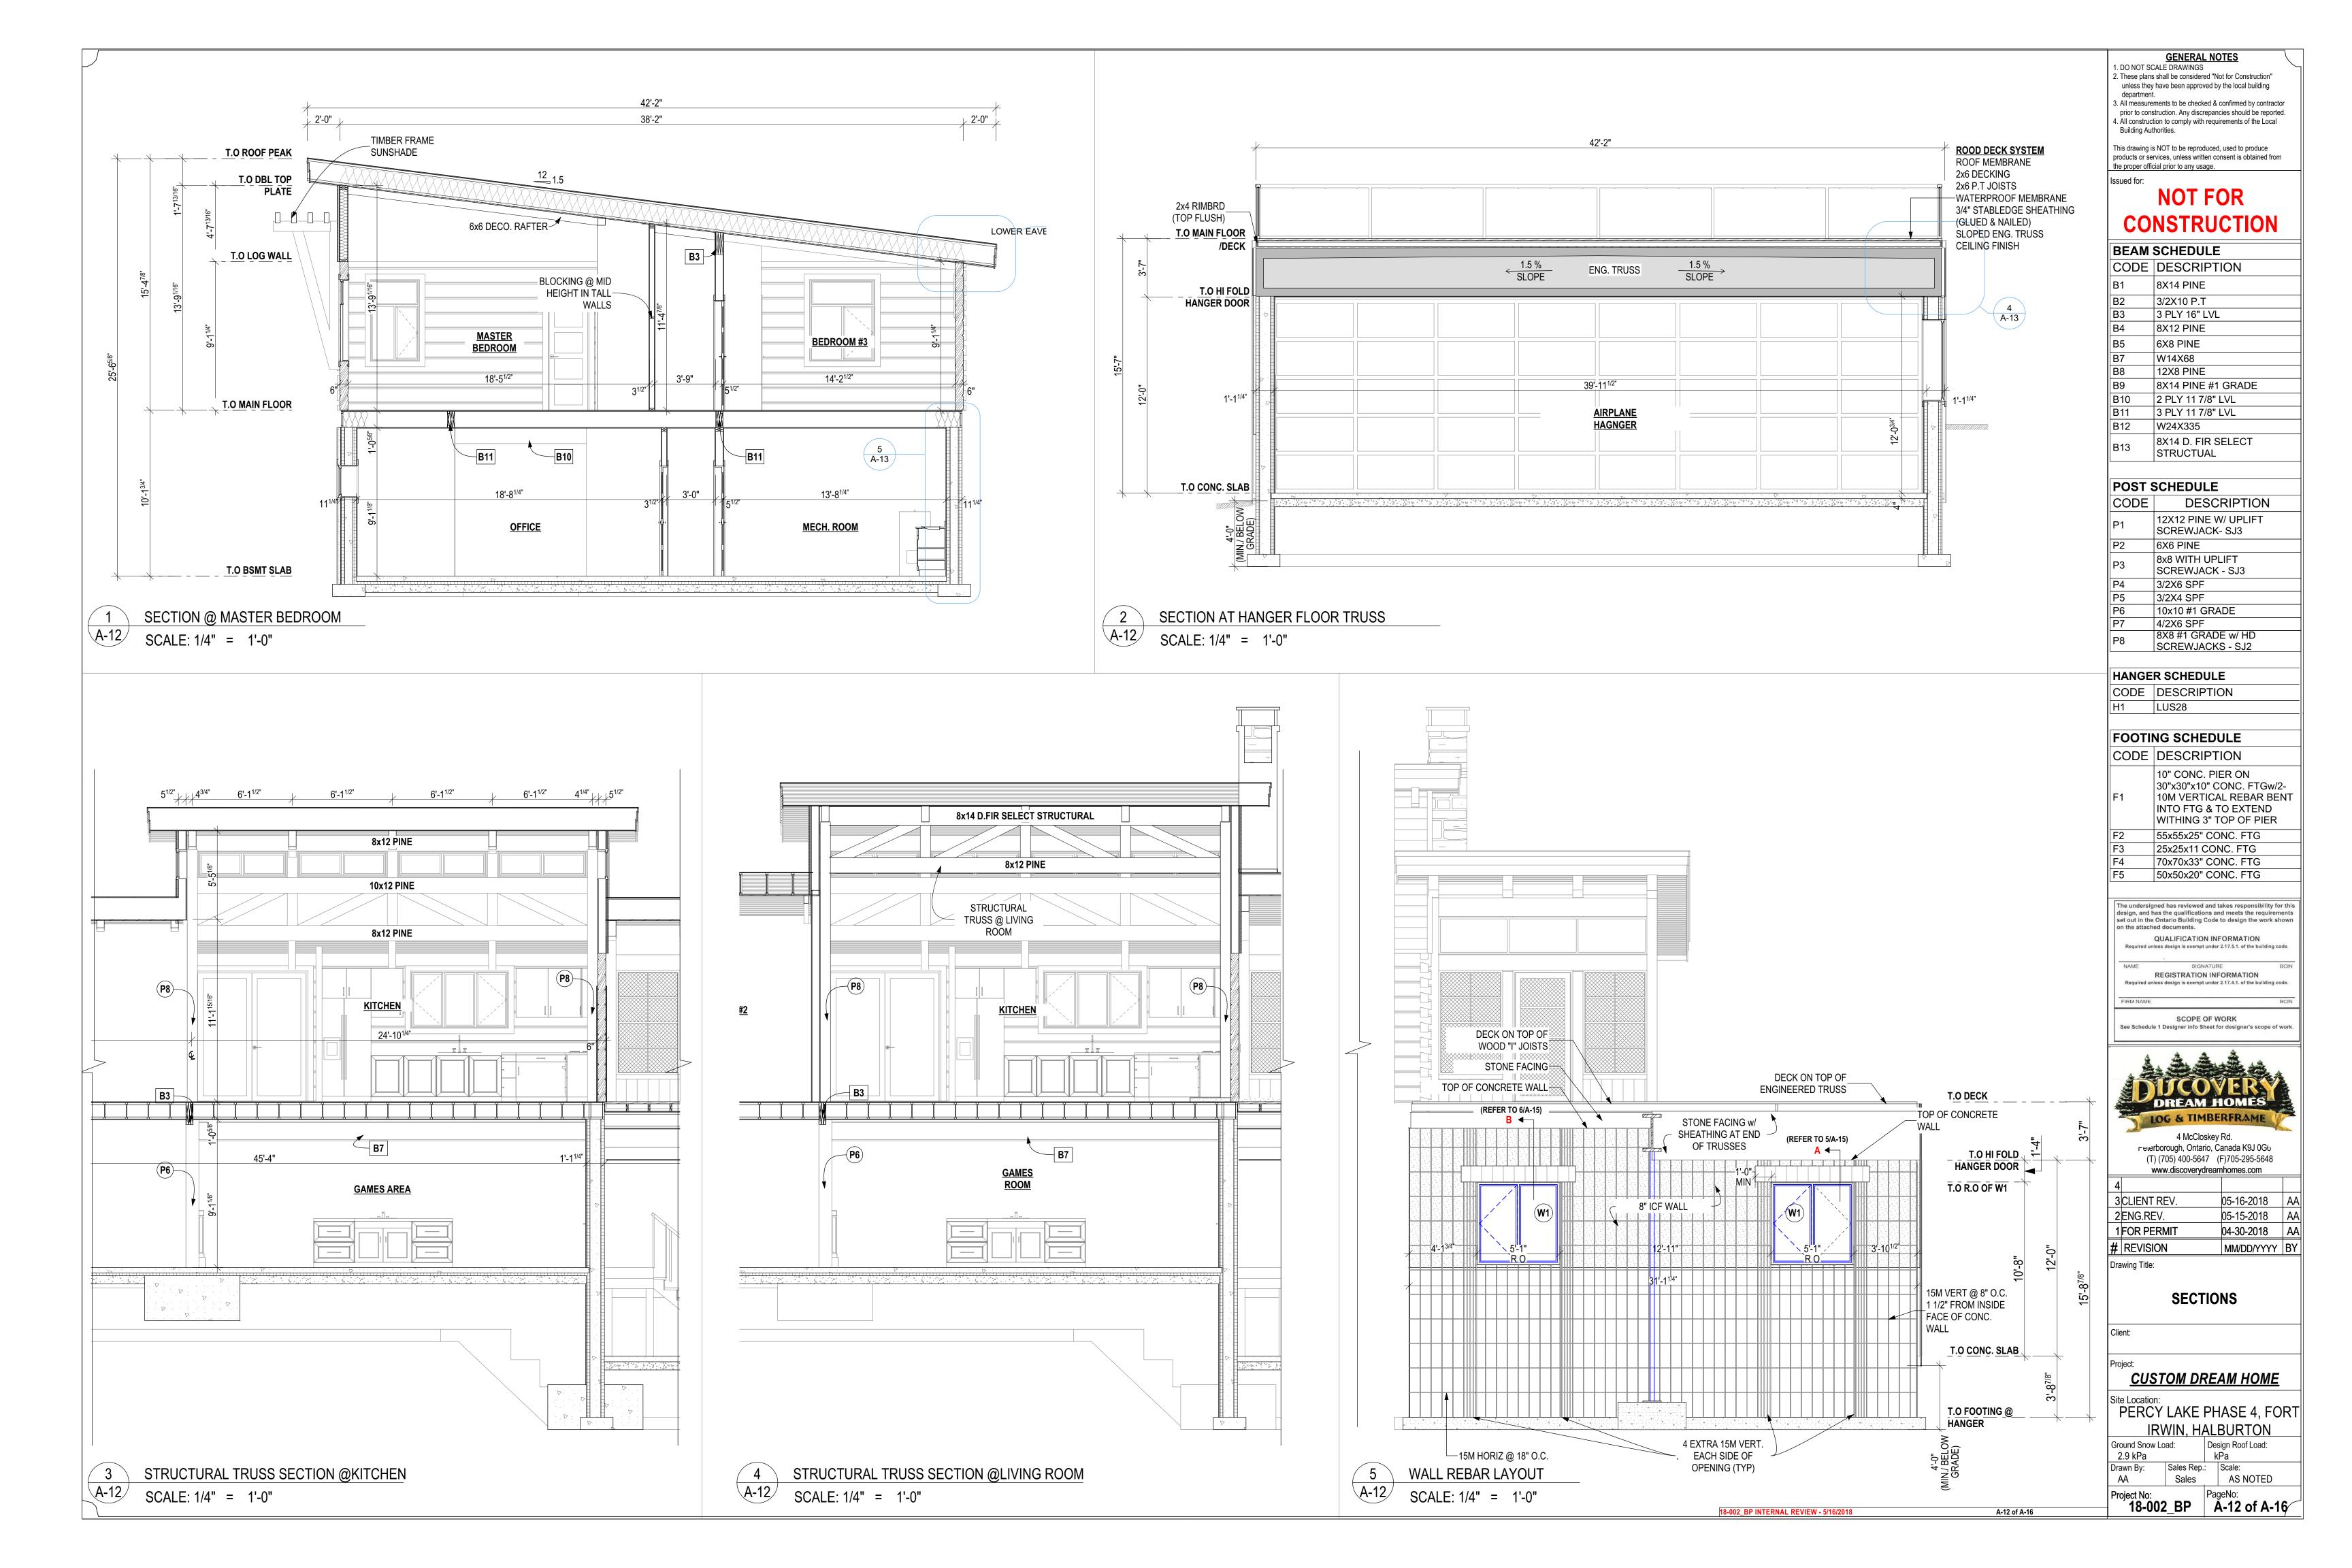


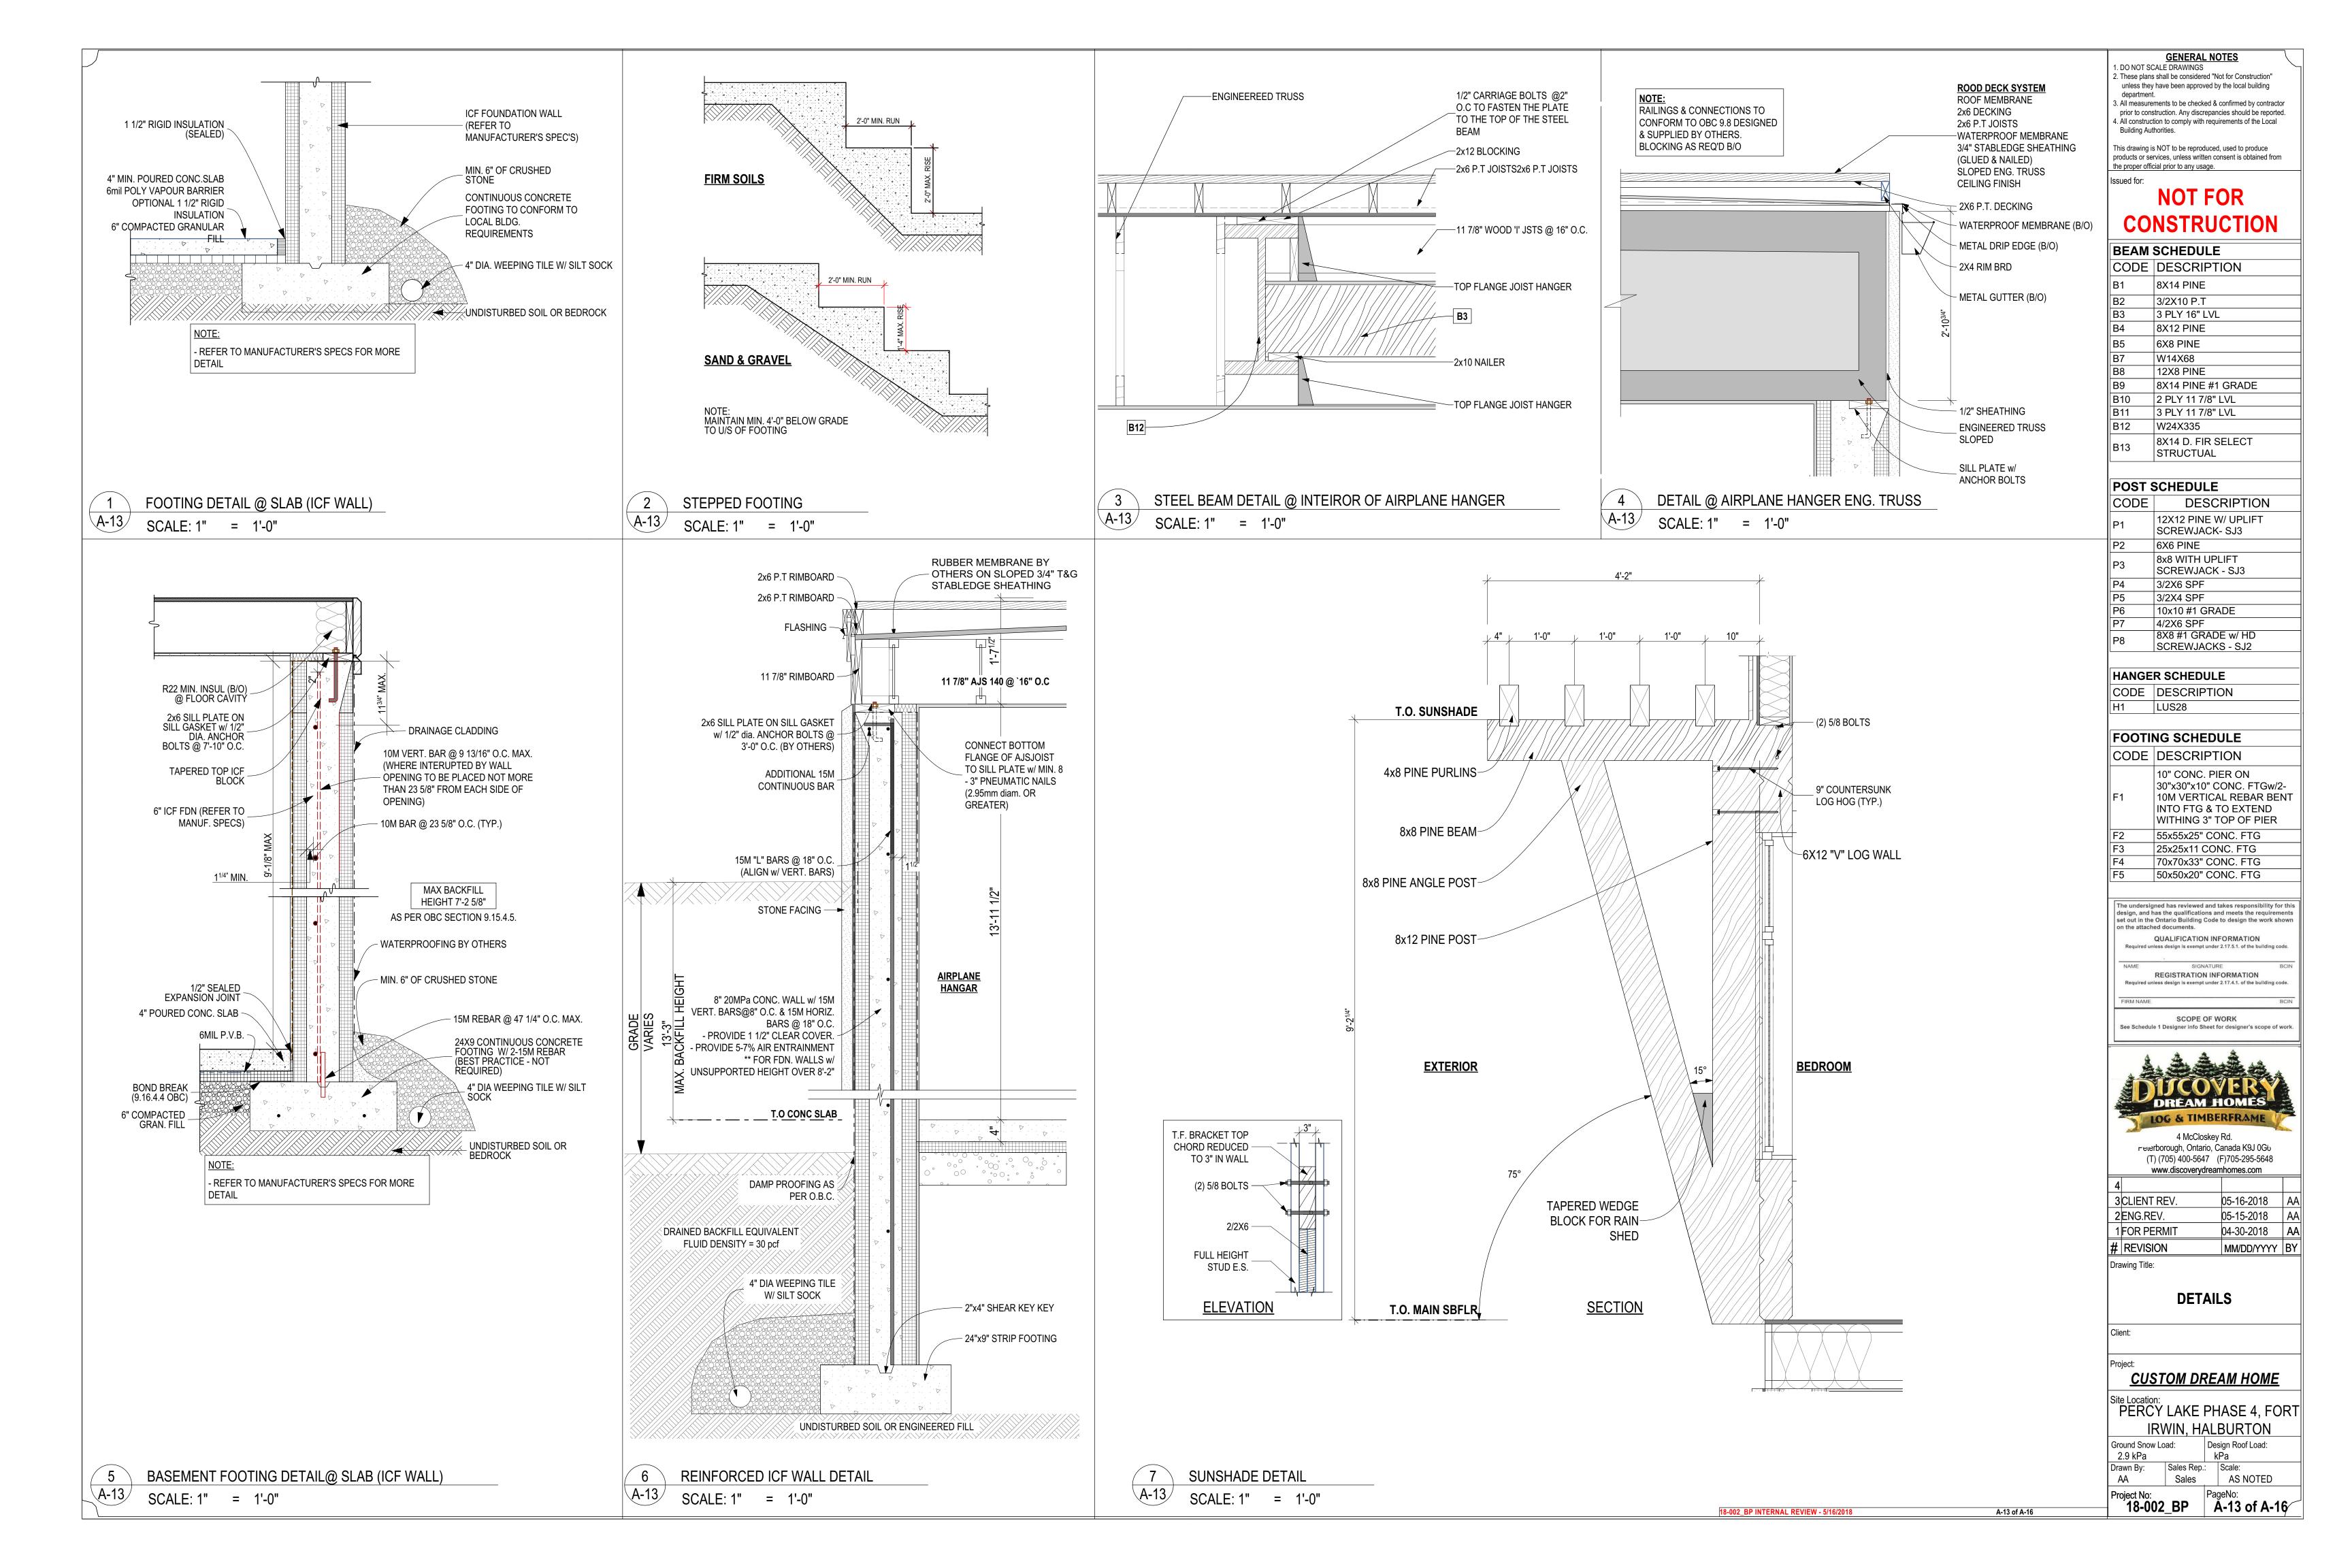


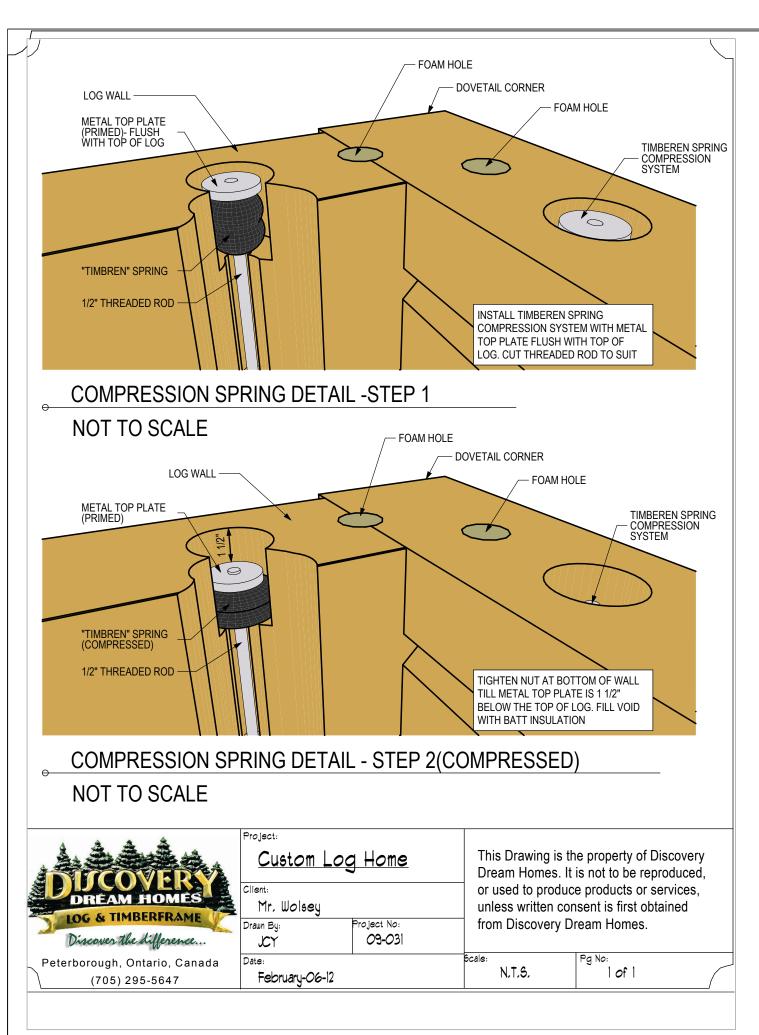


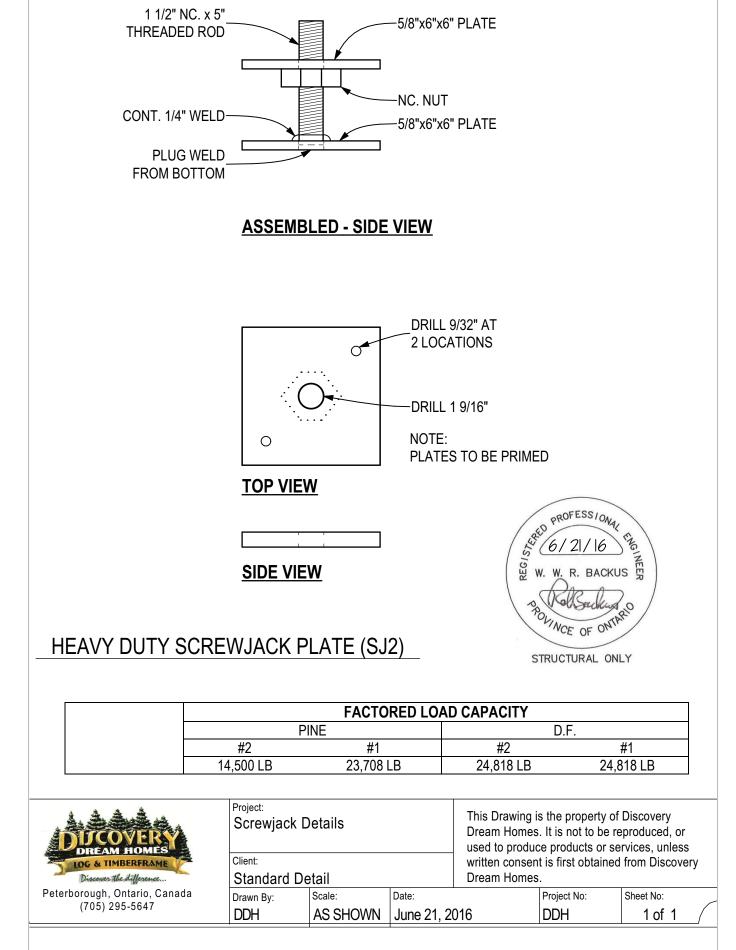


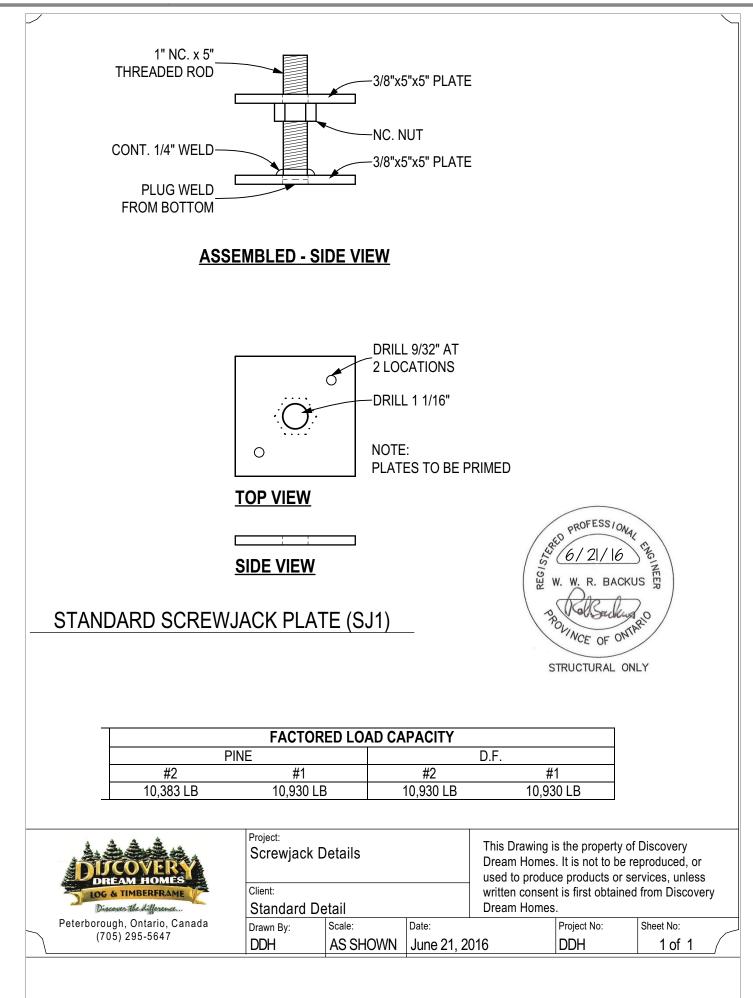

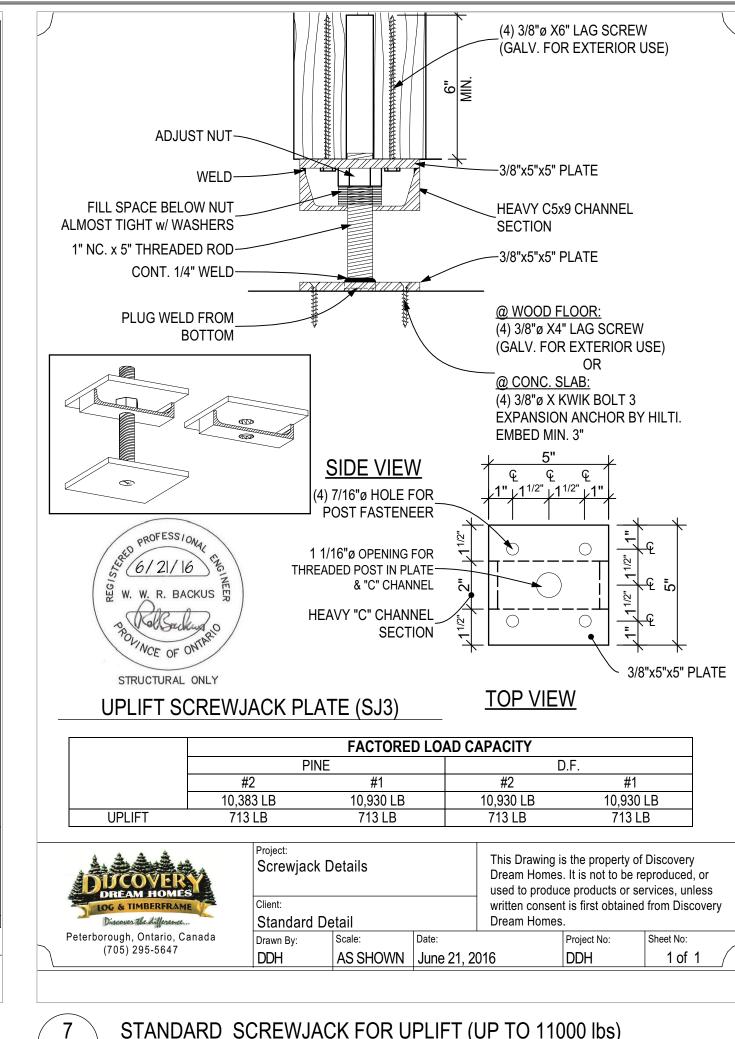

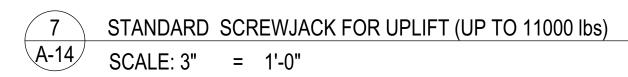


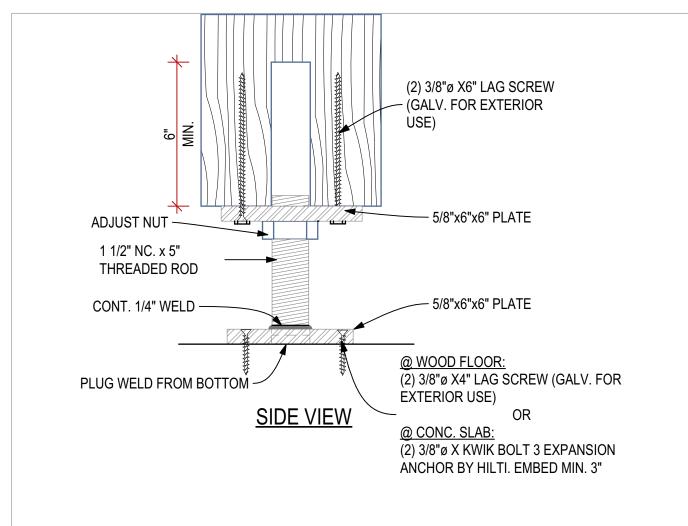


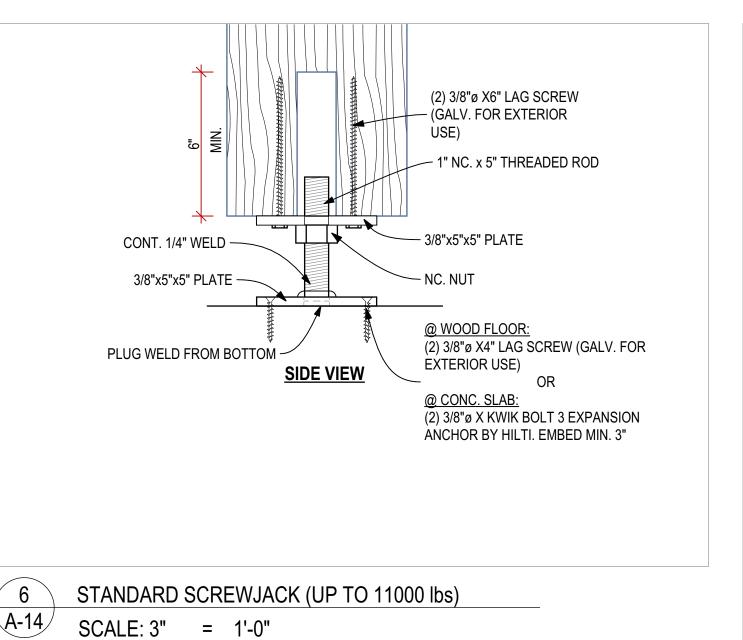


STANDARD SCREWJACK (UP TO 11000 lbs)

SCALE: 3" = 1'-0"

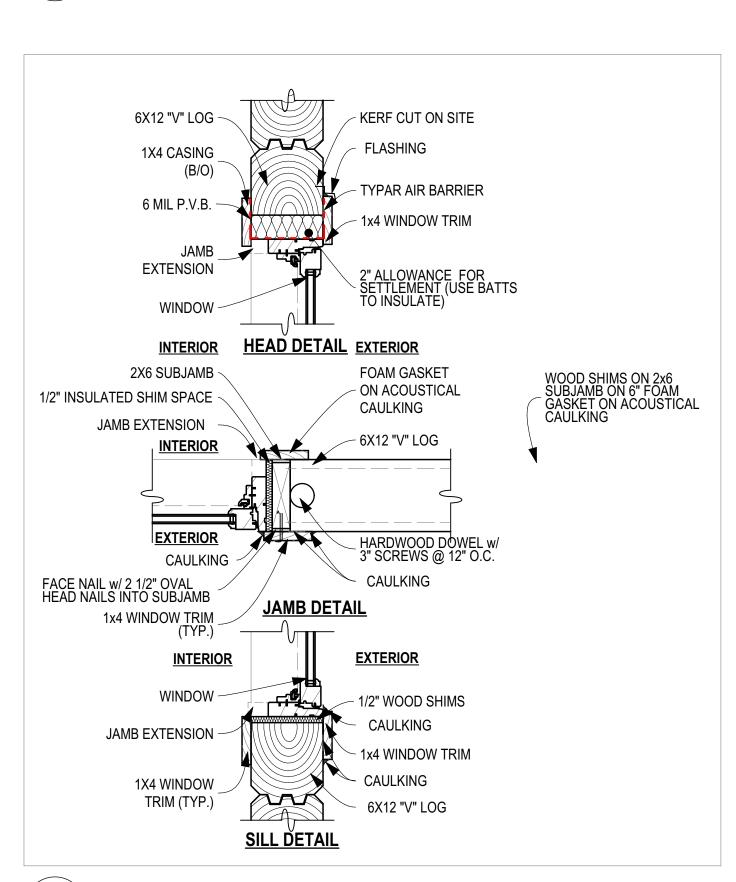

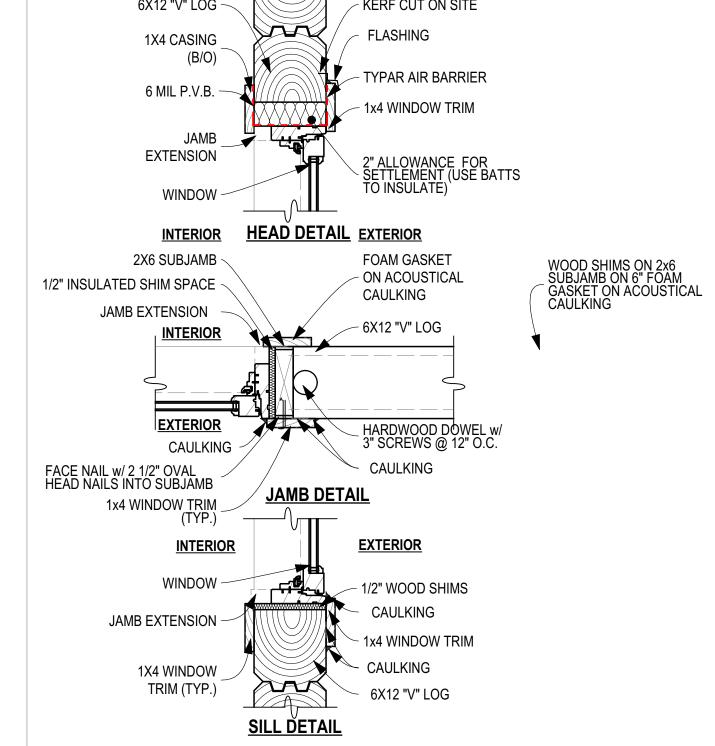

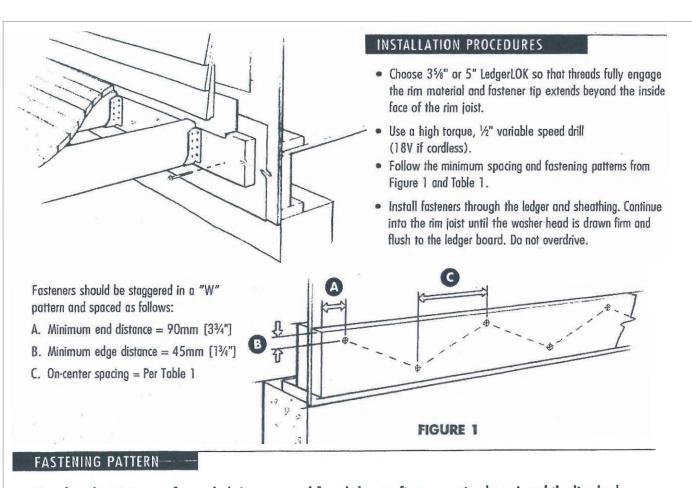

**COMPRESSION SPRING DETAIL** 

SCALE: 1/4" = 1'-0"

Based on the joist span of your deck (as measured from ledger to first supporting beam), and the live load required by your local code, determine the correct fastening pattern from Table 1 below.


On Centre Spacing (mm [in]) for attaching Deck Ledger to Rim Joist using LedgerLok

	Joist Span (m [ft])				
Live Load (kPA [psf])	2 [6]	2.5 [8]	3 [10]	3.5 [11.5]	4 [13]
1.9 [40]	225 [9]	175 [7]	150 [6]	125 [5]	100 [4]
2.4 [50]	175 [7]	150 [6]	125 [5]	100 [4]	100 [4]
4.8 [100]	100 [4]	75 [3]	75 [3]	50 [2]	50 [2]

- Fastening patterns outlined in the table above were determined based on CSA-086-09 from values provided by the report "Derivation of Canadian Design Properties for HeadLOK, LedgerLOK, TimberLOK, TrussLOK, and TrussLOK-Z Screws" by Wood Science and Technology Centre, University of New Brunswick dated November 30, 2009.
- Spacing requirements were calculated based on CSA-086-09. A service condition factor (KsF) of 0.67 has been applied.
- Values are calculated based on full penetration of fastener into the sheathing and rim joist.
- Spacing is based on non-incised pressure treated lumber. If incised pressure treated lumber is used, reduce on-centre spacing by 15%.
- A dead load of 0.5 kPa [10psf] has been assumed. The following materials were assumed:
- Ledger: 2x8 pressure-preservative-treated SPF #1/#2 or better lumber with minimum 0.42 specific gravity.
- Sheathing: 11mm [7/16"] or 12mm [15/32"] OSB sheathing.
- Rim Joist: 2x\_ SPF #1 /#2 lumber.

### DECK LEDGER BOARD CONNECTION DETAIL

SCALE: 1/4" = 1'-0"

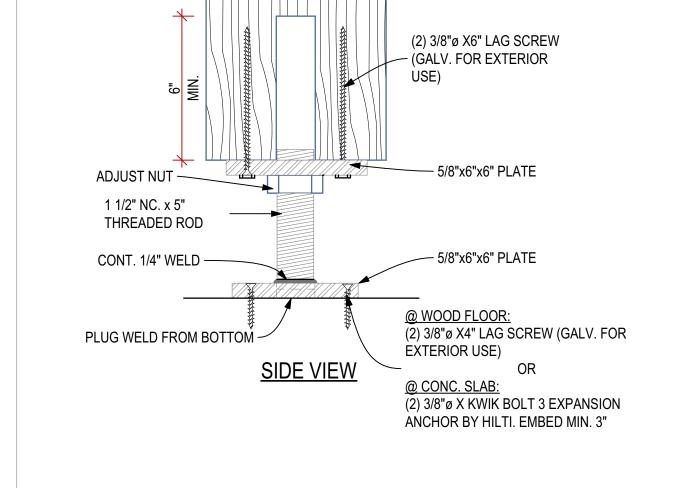

HEAVY DUTY SCREWJACK (UP TO 25000 lbs)

SCALE: 3" = 1'-0"

HEAVY DUTY SCREWJACK (UP TO 25000 lbs)

SCALE: 3" = 1'-0"

WINDOW DETAILS @ 6X12 LOG WALL SCALE: 1 1/2"= 1'-0"

18-002 BP INTERNAL REVIEW - 5/16/2018

Site Location:
PERCY LAKE PHASE 4, FORT IRWIN, HALBURTON Design Roof Load: Ground Snow Load: 2.9 kPa Sales Rep.: Scale: Drawn By: AA Sales AS NOTED Project No:

**GENERAL NOTES** 

. These plans shall be considered "Not for Construction"

unless they have been approved by the local building

3. All measurements to be checked & confirmed by contractor

prior to construction. Any discrepancies should be reported. 4. All construction to comply with requirements of the Local

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**NOT FOR** 

CONSTRUCTION

DO NOT SCALE DRAWINGS

Building Authorities.

the proper official prior to any usage.

BEAM SCHEDULE

CODE DESCRIPTION

8X14 PINE

3/2X10 P.T

8X12 PINE

6X8 PINE

W14X68

B9

B10

B12

CODE

12X8 PINE

W24X335

POST SCHEDULE

**STRUCTUAL** 

8X14 PINE #1 GRADE

8X14 D. FIR SELECT

DESCRIPTION

12X12 PINE W/ UPLIFT

SCREWJACK- SJ3

8x8 WITH UPLIFT

10x10 #1 GRADE

8X8 #1 GRADE w/ HD

SCREWJACKS - SJ2

10" CONC. PIER ON

55x55x25" CONC. FTG 25x25x11 CONC. FTG

70x70x33" CONC. FTG

50x50x20" CONC. FTG

The undersigned has reviewed and takes responsibility for this design, and has the qualifications and meets the requirements

set out in the Ontario Building Code to design the work show

QUALIFICATION INFORMATION

REGISTRATION INFORMATION

SCOPE OF WORK

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4 McCloskey Rd.

reterborough, Ontario, Canada K9J 0G6

**DETAILS** 

**CUSTOM DREAM HOME** 

(T) (705) 400-5647 (F)705-295-5648 www.discoverydreamhomes.com

05-16-2018 AA

05-15-2018 AA

04-30-2018 AA

MM/DD/YYYY BY

Required unless design is exempt under 2.17.5.1. of the building code

on the attached documents.

3 CLIENT REV.

1 FOR PERMIT

2 ENG.REV.

# REVISION

Drawing Title:

30"x30"x10" CONC. FTGw/2-10M VERTICAL REBAR BENT INTO FTG & TO EXTEND WITHING 3" TOP OF PIER

SCREWJACK - SJ3

6X6 PINE

3/2X6 SPF

3/2X4 SPF

4/2X6 SPF

HANGER SCHEDULE

CODE DESCRIPTION

FOOTING SCHEDULE

CODE DESCRIPTION

LUS28


2 PLY 11 7/8" LVL


3 PLY 11 7/8" LVL


3 PLY 16" LVL


A-14 of A-16

18-002\_BP A-14 of A-16

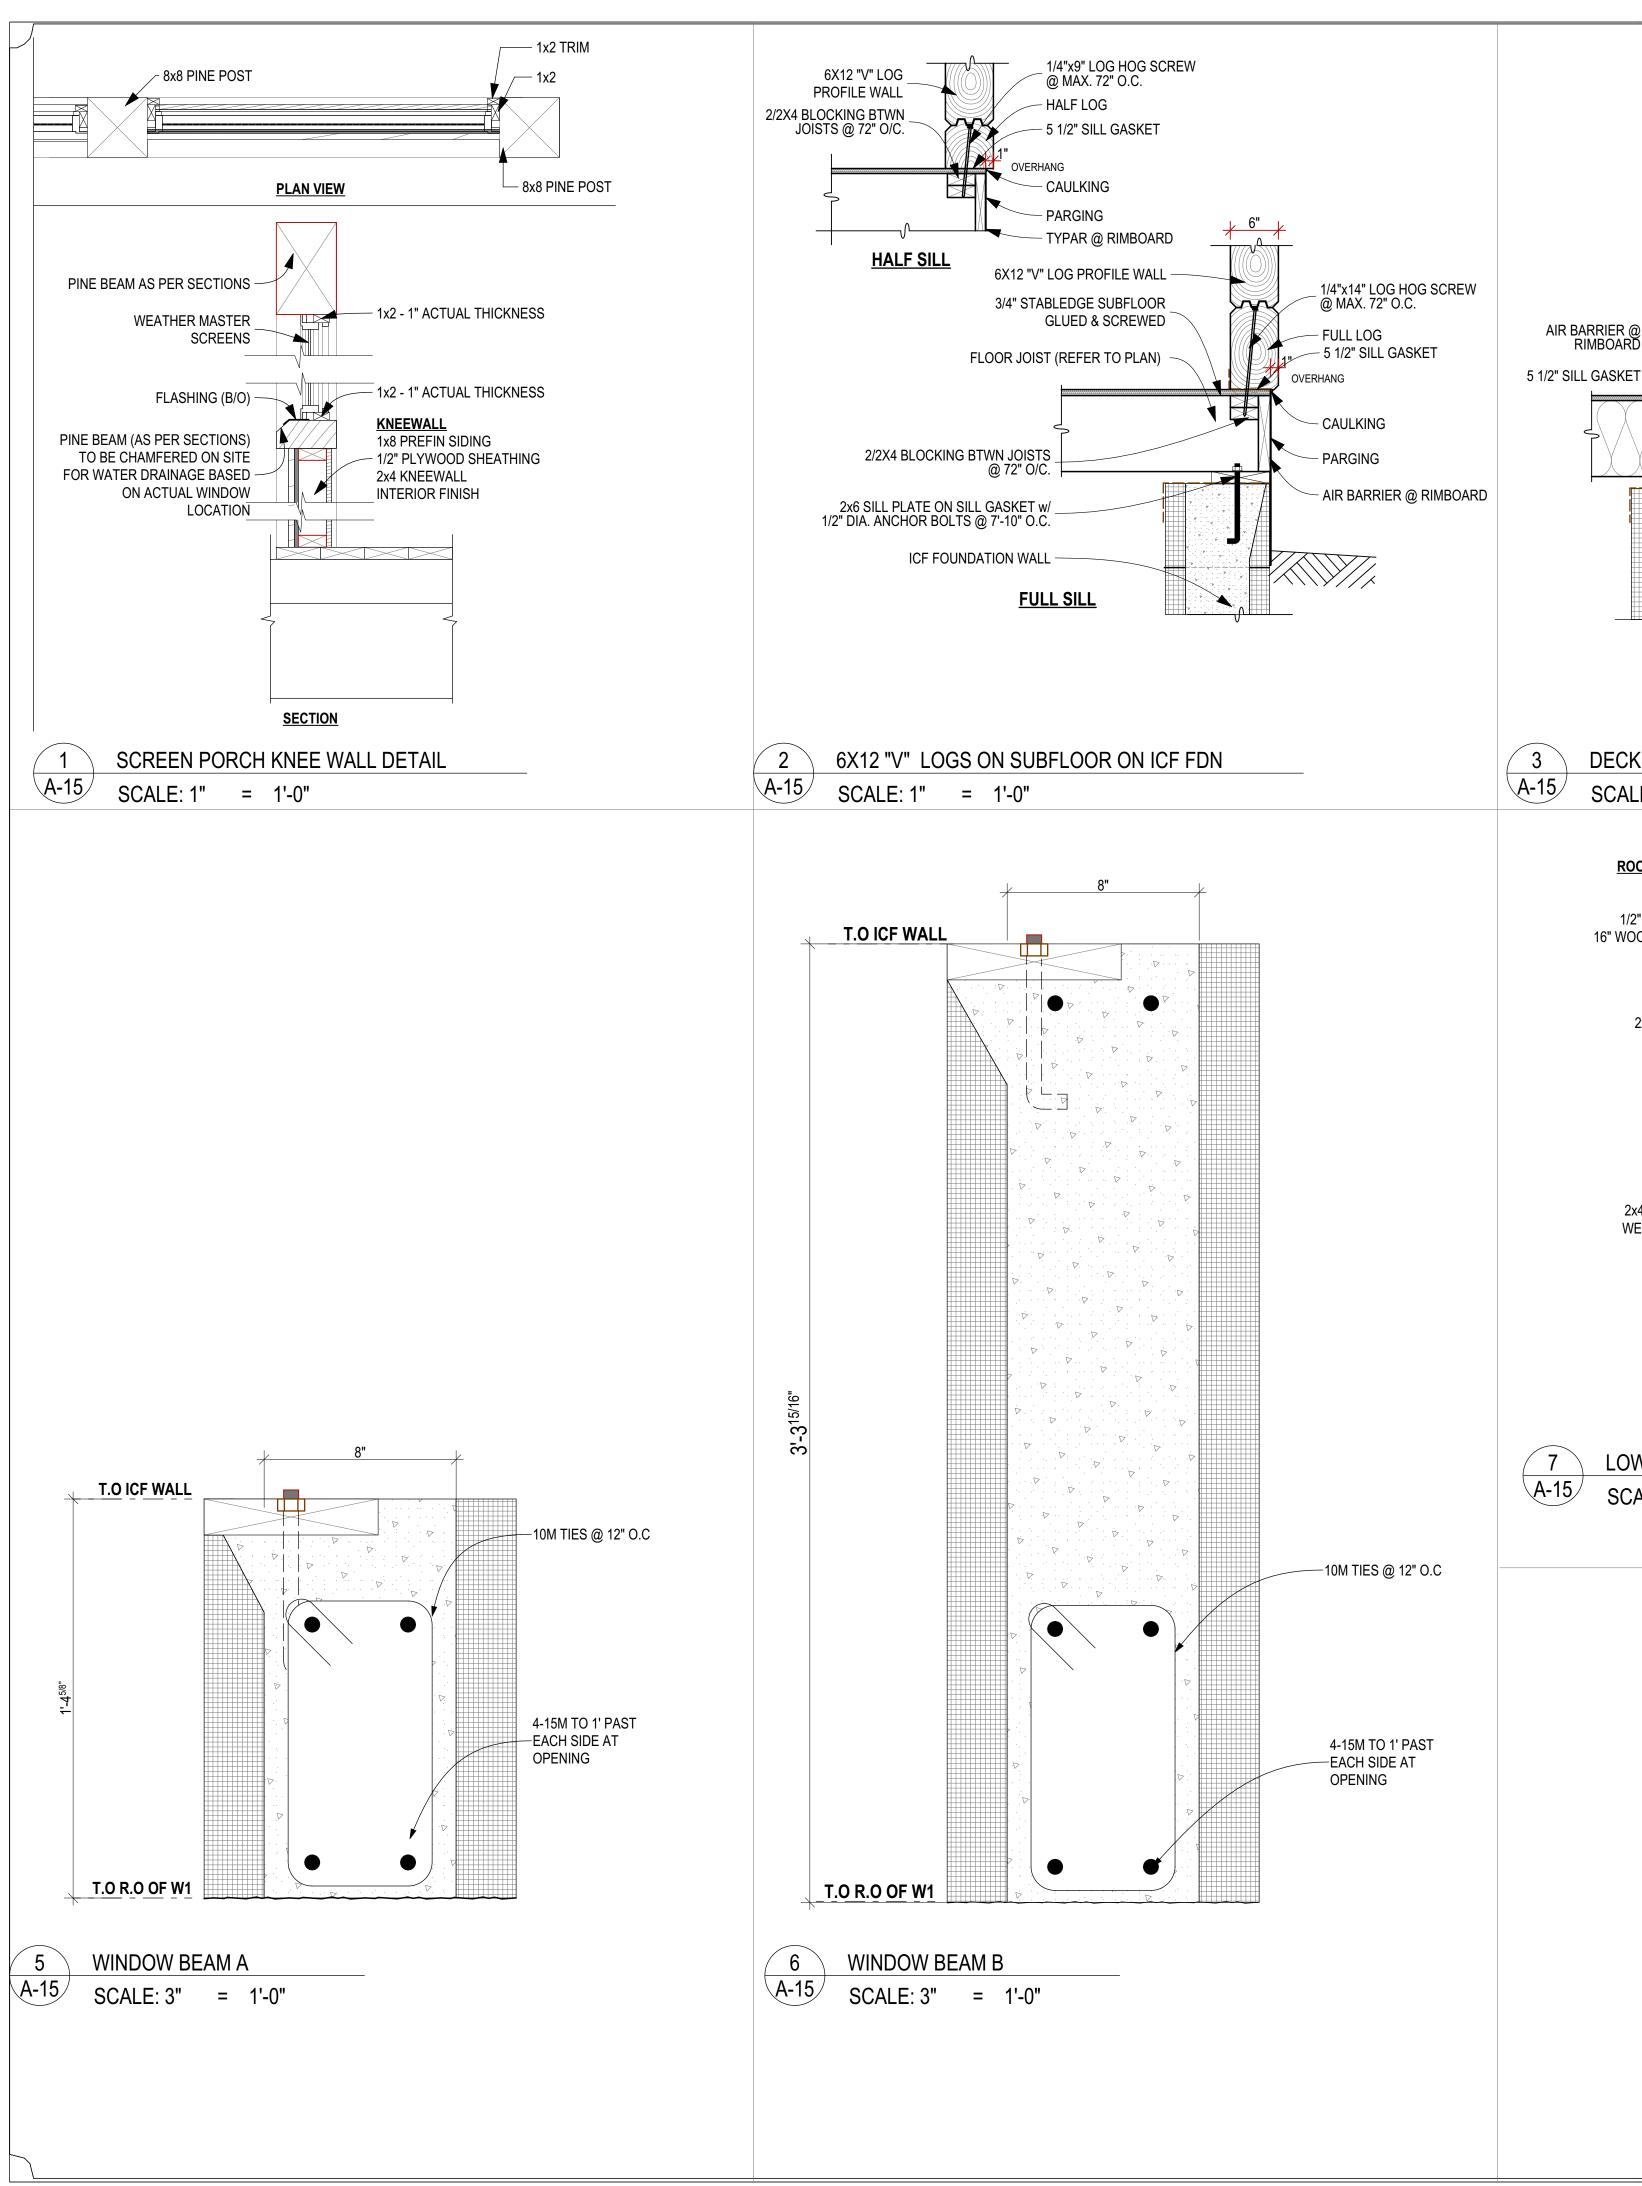


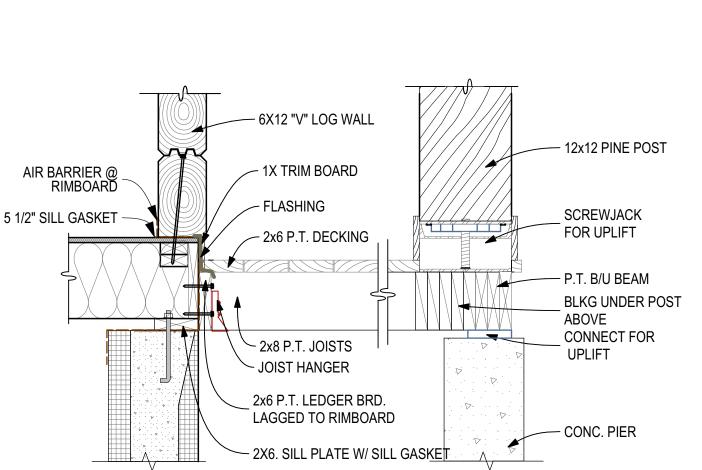


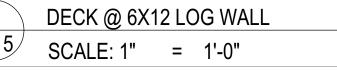

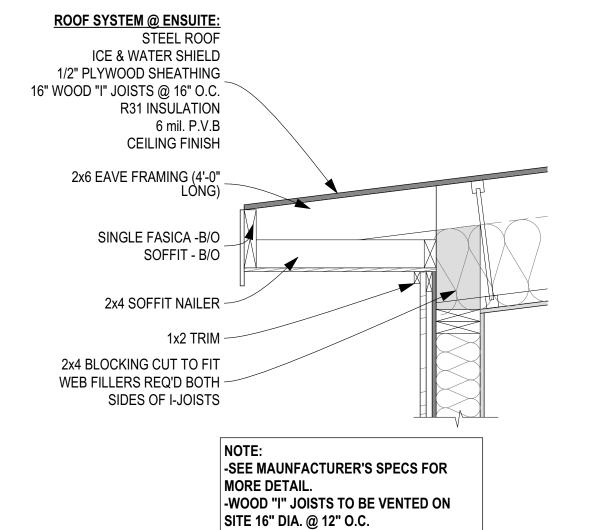


LOWER EAVE DETAIL @ ENSUITE SCALE: 1" = 1'-0"

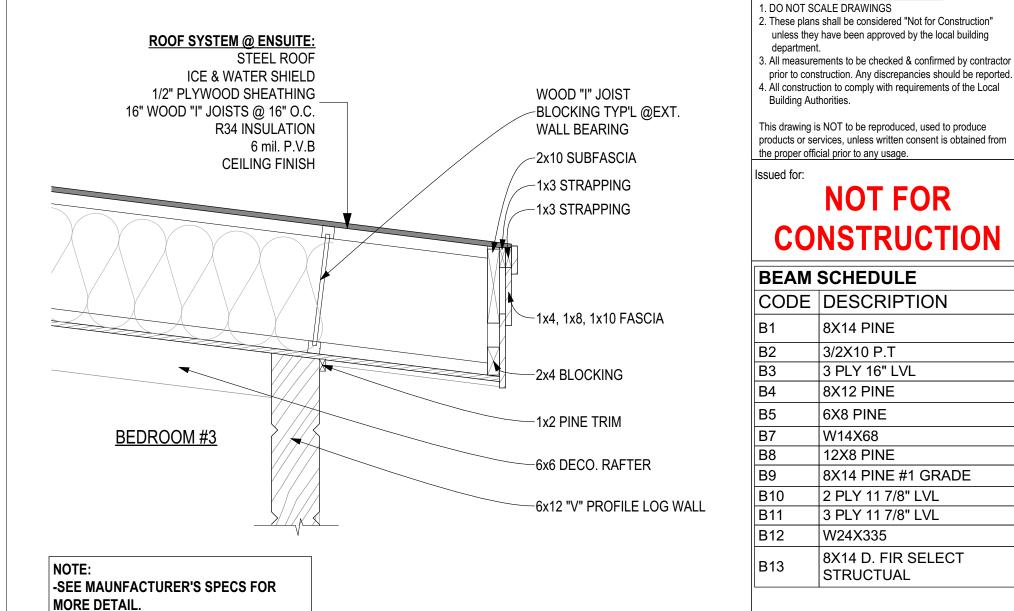

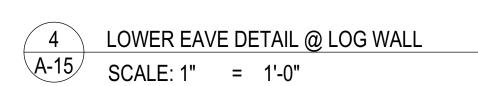

-WOOD "I" JOISTS TO BE VENTED ON

SITE 16" DIA. @ 12" O.C.

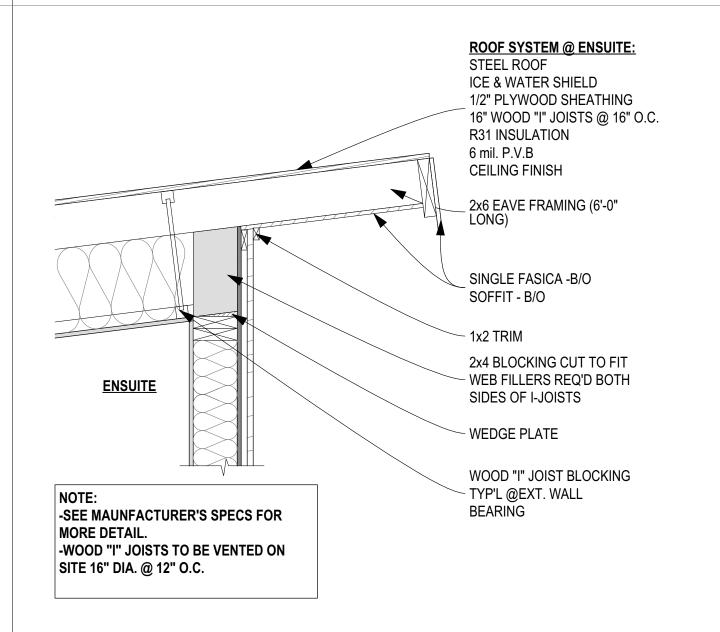

UPPER EAVE DETAIL @ ENSUITE SCALE: 1" = 1'-0"



**GENERAL NOTES** 

**NOT FOR** 

**CONSTRUCTION** 

8X14 PINE

3/2X10 P.T

8X12 PINE

6X8 PINE

W14X68

12X8 PINE

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POST SCHEDULE

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SCREWJACK - SJ3

6X6 PINE

3/2X6 SPF 3/2X4 SPF

4/2X6 SPF

HANGER SCHEDULE

LUS28

CODE DESCRIPTION

FOOTING SCHEDULE CODE DESCRIPTION

DESCRIPTION

2 PLY 11 7/8" LVL

3 PLY 11 7/8" LVL

3 PLY 16" LVL

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**DETAILS** 

CUSTOM DREAM HOME

PERCY LAKE PHASE 4, FORT IRWIN, HALBURTON Ground Snow Load: Design Roof Load: 2.9 kPa

Sales Rep.: Scale: Drawn By: Sales AS NOTED Proiect No:

18-002\_BP INTERNAL REVIEW - 5/16/2018

A-15 of A-16

18-002\_BP A-15 of A-16

