PryorMorrow

July 29, 2025

architects: engineers: interior design

ADDENDUM No. 4

Project: 2024922

South Jones High School Athletic Buildings

Jones County School District

Laurel, Mississippi

The following additions, changes, clarifications, and substitutions to the drawings and specifications, dated June 25, 2025, are to be included as part of the contract documents. Acknowledge receipt of this addendum by inserting its number and date in the proposal form.

Addendum Table of Contents: 2 8-1/2 x 11 pages of Addendum Items

1 8-1/2 x 11 pages of Civil Addendum Items

3 8-1/2 x 11 pages of Specifications

2 11x17 pages of Drawings

9 24x36 pages of Drawings

Total of 17 pages of Addendum

J Guadalupe Arellano C 4679 2025.07.29

J Guadalupe Arellano, Principal Architect, AIA

PryorMorrow PC, Brandon, Mississippi

jarellano@pryor-morrow.com



Columbus, MS

Michael W. Taylor, AIA: Corey D. Ravenhorst, PE: Kharma A. Leonard, AIA

P.O. Box 167 : 102 Roasecrest Drive : Columbus, MS 39703 : P 662 327 8990 : F 662 327 8991

Tupelo, MS

William V. Dexter, Jr., AIA: Charles A. Watson, AIA

P.O. Box 7066 : 413 West Main Street, Ste 300 : Tupelo, MS 38802 : P 6628408062 : F 662 840 8092

Brandon, MS

J Guadalupe Arellano, AIA

2151 Highway 18, Ste A: Brandon, MS 39042: P 601 829 6915: F 601 829 6916

Reform, AL

Michael W. Taylor, AIA

P.O. Box 83 : 418 First Avenue West : Reform, AL 35481 : P 205 828 0039

pryormorrow.com

General Information

Item No. 1. Refer to the enclosed Civil Addendum Item.

Refer to Drawings

Item No. 2.	Refer to Sheet A1.10, Wall Type 4 and 8, and Wall Section 1/A3.34, 3/A3.35,
	2/A3.36, and 2/A3.37 – Pre-Finished Metal Planks (Wood) shall be per enclosed
	Section 07 42 26 Metal Planks.

- Item No. 3. Refer to Sheet A1.12 Replace with enclosed sheet A1.12. Refer to enclosed A3.1 and A3.31 for Pressbox Building Sections and Wall Section and Shhet A4.7 and A4.8 for Interior Elevations.
- Item No. 4. Refer to Sheet A1.34 Suspended Cementitious Wood Fiber Shapes preselected colors shall be per enclosed A6.2 Weight Rooms Reflected Ceiling Plans.
- Item No. 5. Refer to A2.1 detail 6/A2.1 Replace detail with enclosed AD4.1.
- Item No. 6. Refer to A2.2, Building Elevation 1/A2.2 and 5/A2.2 Laser cut plate logo/signage for these elevations shall be per enclosed AD4.2
- Item No. 7. Refer to Sheet A4.0

Interior elevations for Coaches Office 102 shall be similar to Coaches Office 105.

Interior elevations for Restroom 109 shall be similar to Restroom 107.

Interior elevations for Locker Room 110 shall be similar to Locker Room 106.

End of Addendum No. Four

ADDENDUM NO. 4 TO DRAWINGS AND SPECIFICATIONS

SOUTH JONES HIGH SCHOOL ATHLETIC BUILDINGS

DRAWINGS

- 1. Sheet C3.10 Soccer/Volleyball Site Plan
 - The drawing was modified to add pavement to the south east of the site, pavement repair expanded to the west of the site, subsurface drainage added to the west of the site, and the removal of the 6" trench grate system. The current drawing dated 7/18/2025 is to be replaced with the revised C3.10 7/25/2025 and identified as addendum #4.
- 2. Sheet C3.20 Soccer/Volleyball Grading Plan
 - The grading plan was adjusted to ensure ADA grading is met in all directions. The grading sheet dated 6/25/2025 is to be completely removed and replaced with the revised C3.20 7/25/2025 and identified as Addendum #4.
- 3. Sheet C4.30 Pump Station Details
 - The pump station detail was modified to change the valve box design to have two check valves and two gate valves. The current drawing dated 7/18/25 is to be completely removed and replaced with the revised C4.30 7/25/2025 and identified as Addendum #4.

All other provisions of the Construction Drawings and Specifications shall remain unchanged and in full effect. This Addendum shall become a part of the Construction Drawings and Specifications for the JONES COUNTY SCHOOL DISTRICT project entitled "SOUTH JONES HIGH SCHOOL ATHLETIC BUILDINGS."

South Jones High School Athletic Buildings Jones County School District Ellisville, Mississippi

SECTION 07 42 23

METAL PLANKS (WOOD)

PART 1 - GENERAL

1.01 WORK INCLUDED

- A. Furnish and install prefinished metal wall and soffit planks complete with mounting accessories and trim.
- B. Meal plans shall be 6" V-Groove Aluminum Cladding

1.02 MANUFACTURER'S WARRANTY

- A. Provide a written guarantee, signed and issued in the name of the owner, covering the metal cladding/cladding material (metal planks) for 15 (fifteen) years from the date of Substantial Completion.
- B. Manufacturer's warranty shall cover the labor and material replacement for manufacturing defects and finish including cracking, peeling, and fade.

1.03 INSTALLER WARRANTY

- A. Furnish Owner with a three-year warranty that guarantees that wall panel repairs and repairs of interior damages that result from wall panel waterproofing failures are the responsibility of the Contractor.
- B. The wall panel warranty period begins when the building is finally accepted by the Owner.

1.04 SUBMITTALS

- A. Product data: submit manufacturer's printed product literature, specifications, and data sheet.
- B. Submit two 6 inch X 6 inch samples of cladding material, of color and profile preselected and specified.
- C. Shop drawings to indicate dimensions, profiles, attachment methods, schedule of wall elevations, trim and closure pieces, soffits, fascia, metal furring, and related work
- D. Submit manufacturer's complete color chart.
- E. Submit manufacturer's installation instructions.

PART 2 - PRODUCTS

2.01 MANUFACTURERS

A. Equal to: Longboard Architectural Products #120 - 1777 Clearbrook Rd., Abbotsford, BC, Canada V2T 5X5; info@longboardproducts.com; 1.800.604.0343

South Jones High School Athletic Buildings Jones County School District Ellisville, Mississippi

2.02 MATERIALS

- A. Prefinished Metal Planks Equal to Tongue and Groove Planks by Longboard Architectural Products
 - 1. Profile: 6" V-Groove plans extruded aluminum 6063-T5
 - 2. Finish: Woodgrain (pre-selected Dark Cherry). Submit all available wood grain options for the owner's final selection.
 - 3. Coating: Slight texture power coated finish with a matte sheen.
 - 4. Thickness: 1/16 inch (1.57mm) base metal thickness.

B. Accessories:

- 1. TRIM COMPONENTS: 5/8" Starter J-Track, 5/8" J-Track, 5/8" Two Piece J-Track, 3/4" Inside Corner, 1" Outside Corner, 3" V-Groove Corner, 5/8" Termination Set, 3/4" T&G U-Reveal, and all other trims as required for a full installation in same material and finishes as planks.
- 2. PLANK CLIPS: 316 Stainless steel Quick-Screen Clips for field installation.
- 3. FASTENING: Butt-Joint Fastening Kit (Aluminum backing plate & 4 x rivets), 1/16" U-Shims.

PART 3 - EXECUTION

3.01 DELIVERY, STORAGE, AND HANDLING

- A. Deliver materials and components in manufacturers' unopened containers or bundles. Prevent damage during unloading, storing and installation.
- B. Store, protect and handle materials and components in accordance with manufacturer's recommendations to prevent twisting, bending, mechanical damage, contamination, and deterioration.
- C. Stack metal cladding planks horizontally on platforms or pallets, covered with suitable weathertight and ventilated covering. Store metal cladding to ensure dryness, with positive slope for drainage of water. Do not store metal cladding in contact with other materials that might cause staining, denting, or other surface damage.
- D. Prolonged storage is not recommended, so if immediate erection is not possible, take extra care to protect metal planks from water marks, and damage.

3.02 INSPECTION

A. Inspect substrate and supporting structure and the conditions under which the metal planks and accessories are to be installed. Do not proceed with the installation until unsatisfactory conditions have been corrected in a manner acceptable to the installer and the Architect. Initiation of installation work indicates acceptance of substrate and existing conditions.

South Jones High School Athletic Buildings Jones County School District Ellisville, Mississippi

3.03 INSTALLATION

- A. Install plank cladding and components in accordance with manufacturer's written instructions and shop drawings, including product technical bulletins, datasheets and install videos.
- B. Install all cladding planks using Quick-Screen Clips in accordance with the manufacturer's written instructions, technical bulletins, datasheets and install videos to not restrict thermal movement. Install screws in pre-punched holes. Install one (1) hard-fastened screw per plank, except where butt-joints are used, through the outermost location of the plank flange to prevent plank migration. All fasteners should penetrate into solid, secure framing or blocking.
- C. Install components in accordance with the manufacturer's written instructions and shop drawings, including technical bulletins, datasheets and install videos with positive anchorage to building and provide for thermal movement.
- D. Install screw fasteners using power tools having controlled torque adjusted to compress Quick-Screen Clips tight without damage or deformation of the Quick-Screen Clips, screw heads, screw threads or cladding.
- E. Install Butt-Joints as per installation guide to maintain tight fitting hairline joints. Never exceed one (1) hard-fastener per plank or multiple plank run, all other attachment points to use Quick-Screen Clips to not restrict thermal movement.
- F. Do not install damaged panels; replace as required.
- G. Install in strict accordance with manufacturer's instructions.

END OF SECTION



Northeast Jones High School Athletic Buildings Jones County School District Laurel, MS

PROJECT NO. 2024921
DRAWN BY: JGA
CHECKED BY: JGA
DATE: July 29, 2025

Copyright © 2025 PryorMorrow PC

AD4.1




Northeast Jones High School
Athletic Buildings
Jones County School District
Laurel, MS

	PROJECT N	O.	20	2492°
	DRAWN BY	/ :		JGA
ı	CHECKED I		JGA	
ı	DATE:	July	29,	2025
П				

Copyright © 2025 PryorMorrow PC

AD4.2

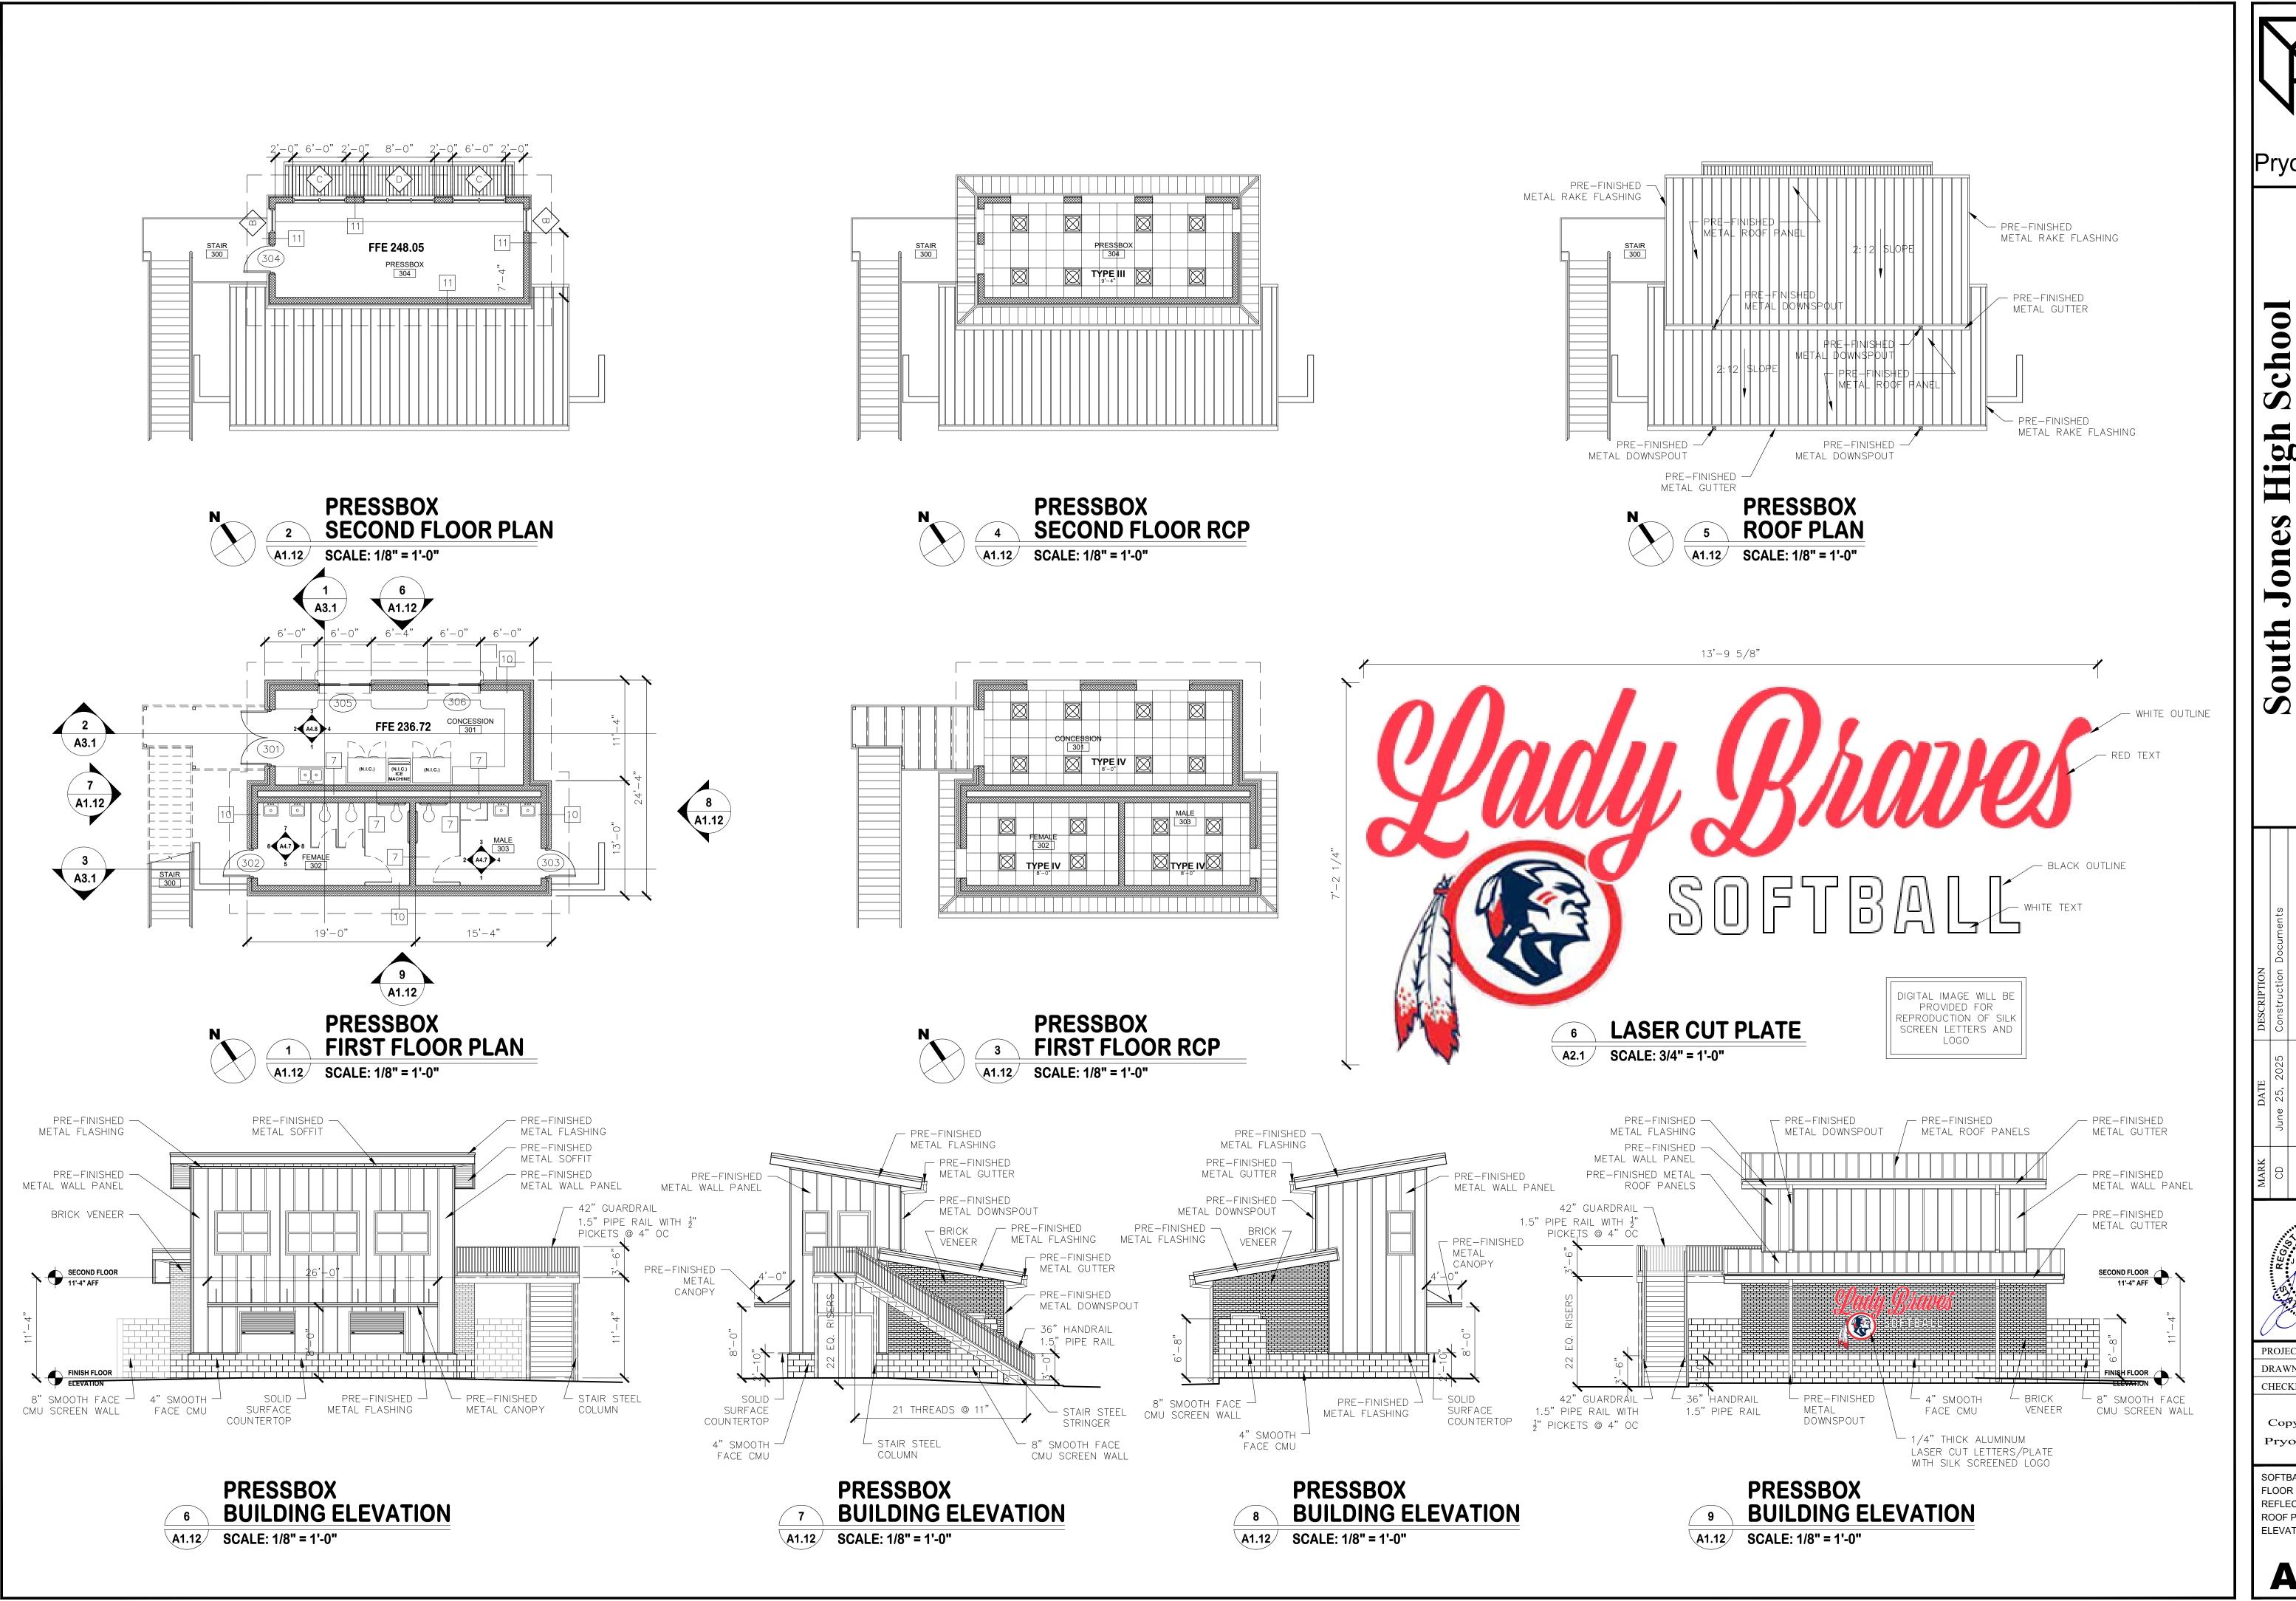

PryorMorrow

School ngs

thletic Buildings
ones County School District

Mone 25, 2025 Construction Documents

Construction Documents



PROJECT NO. 2024922

DRAWN BY: KCD


CHECKED BY: JGA

Copyright © 2025

PryorMorrow PC

SOFTBALL PRESS BOX
FLOOR PLAN
REFLECTED CEILING PLAN
ROOF PLAN
ELEVATIONS

A1.12

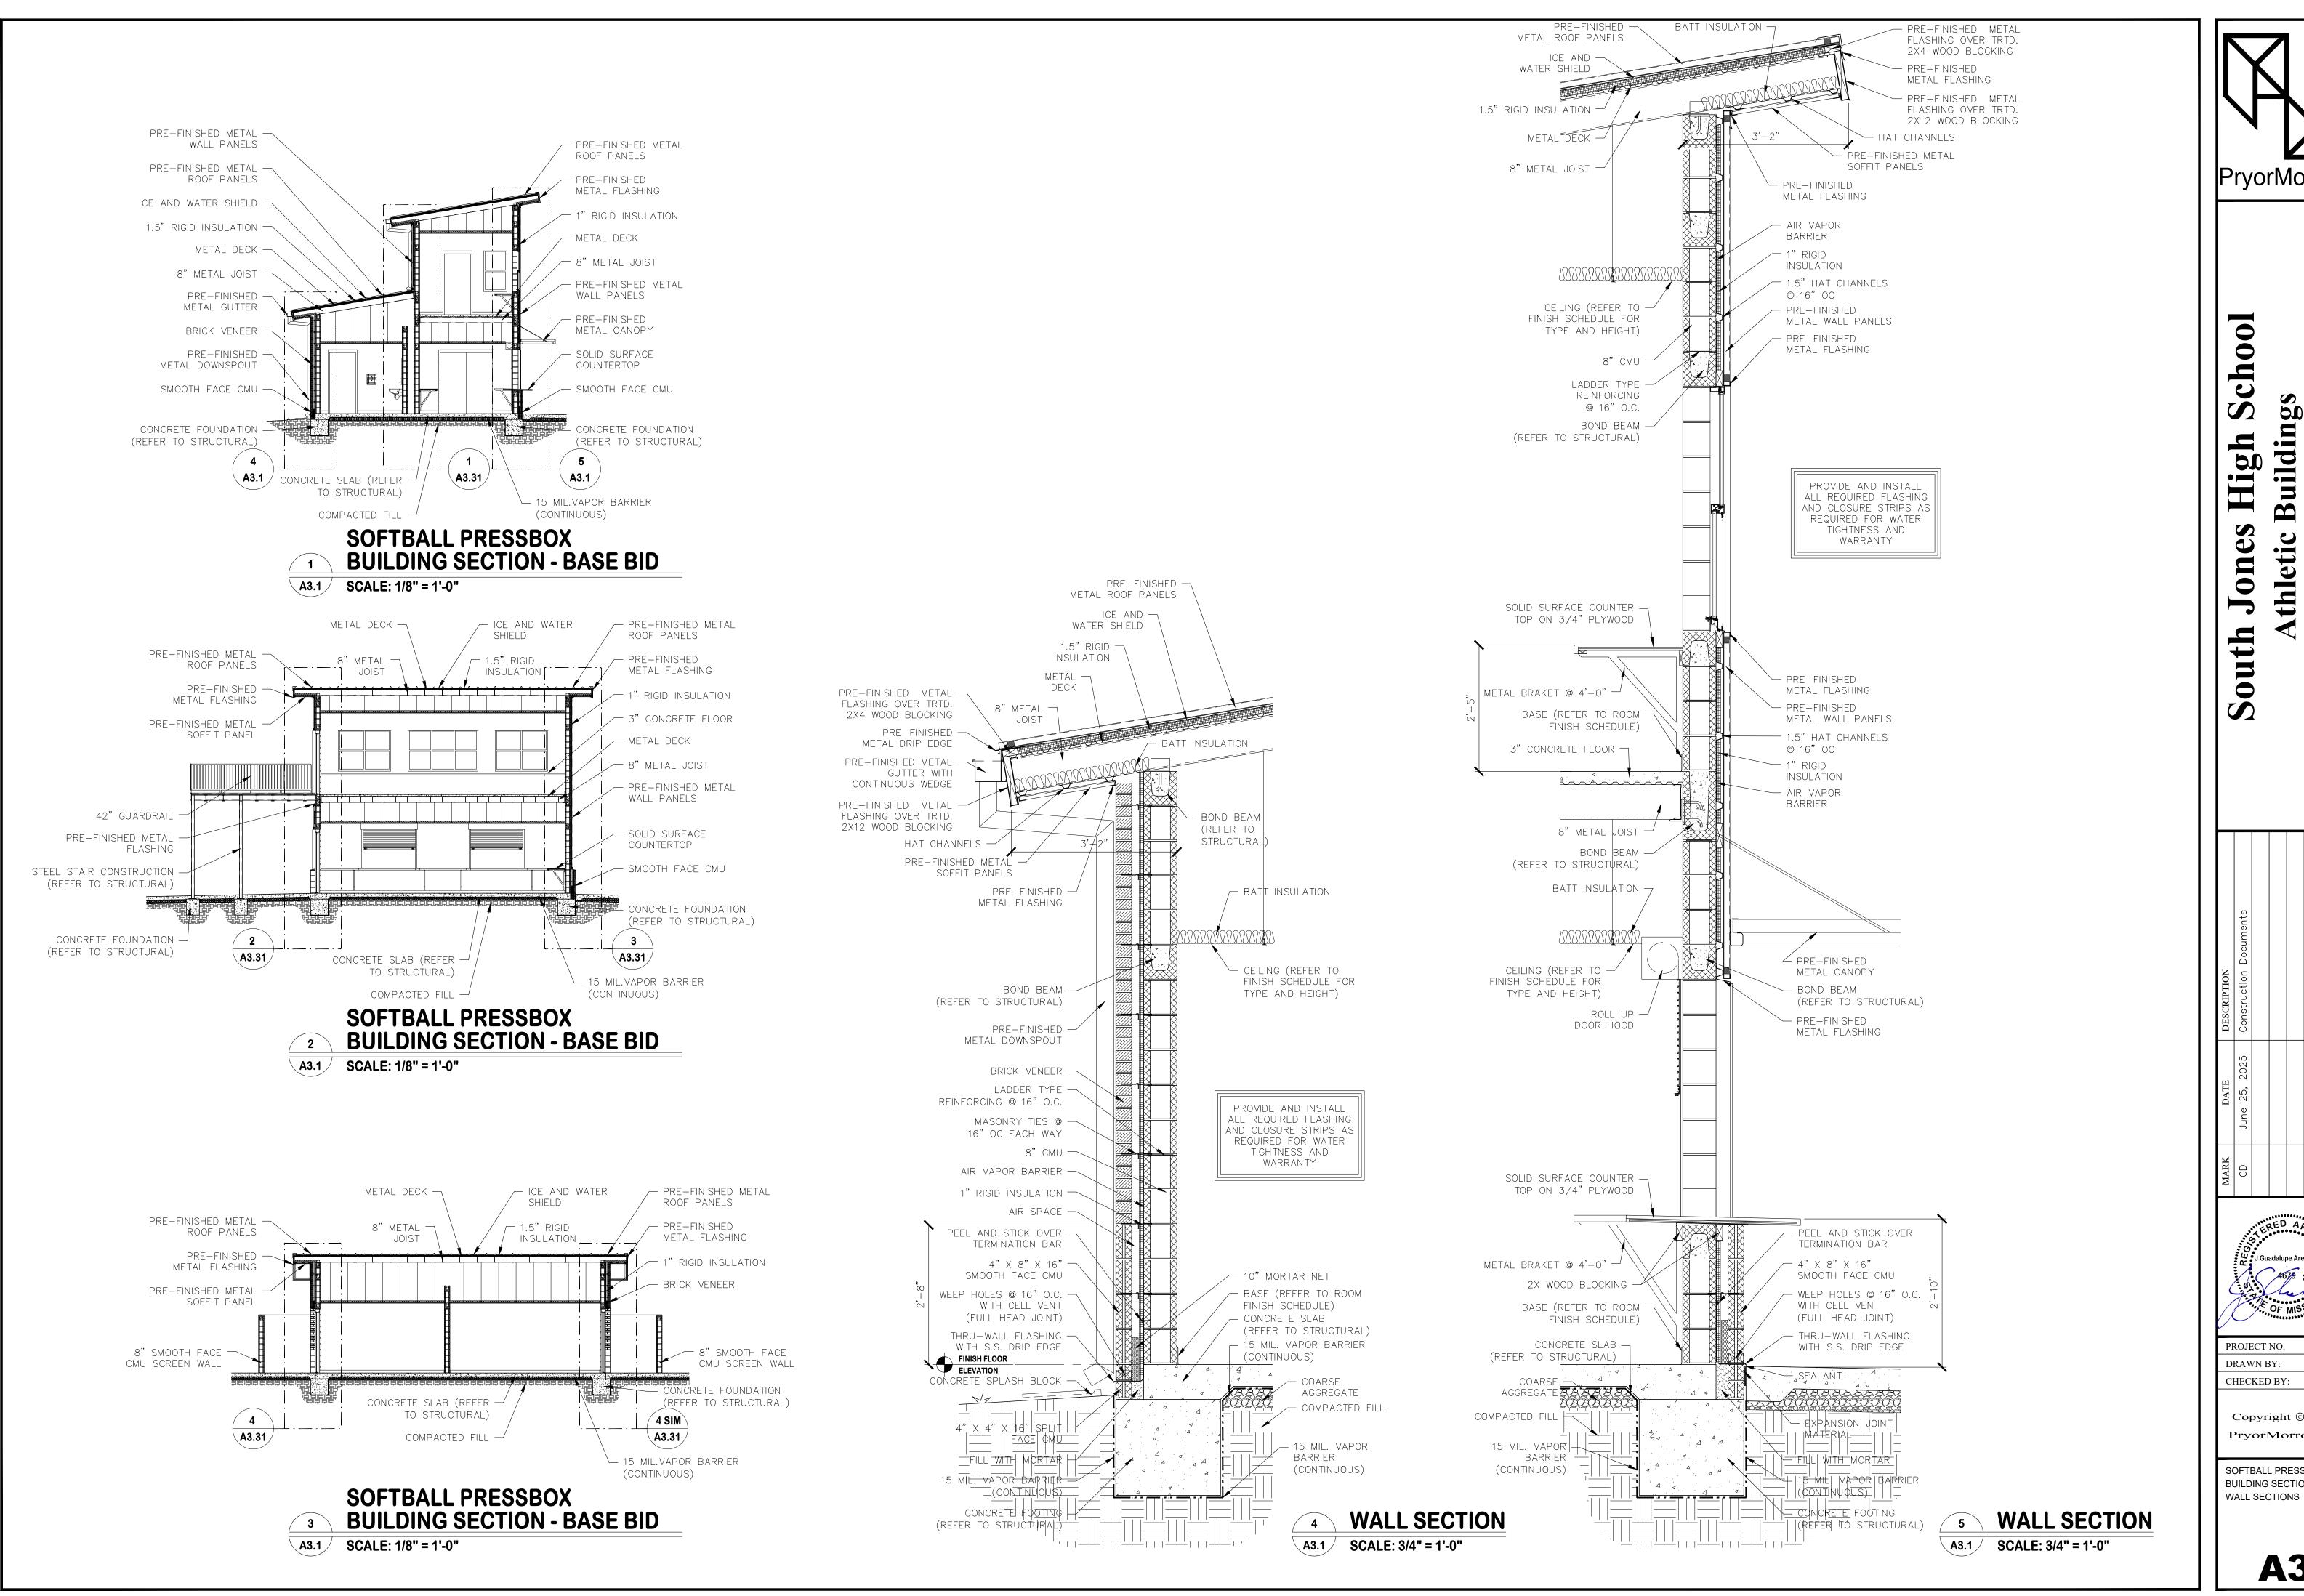

PryorMorrow

in uild thletic


PROJECT NO.


2024922 DRAWN BY: CHECKED BY:


Copyright © 2025 PryorMorrow PC

SOFTBALL PRESS BOX **BUILDING SECTIONS**

A3.1

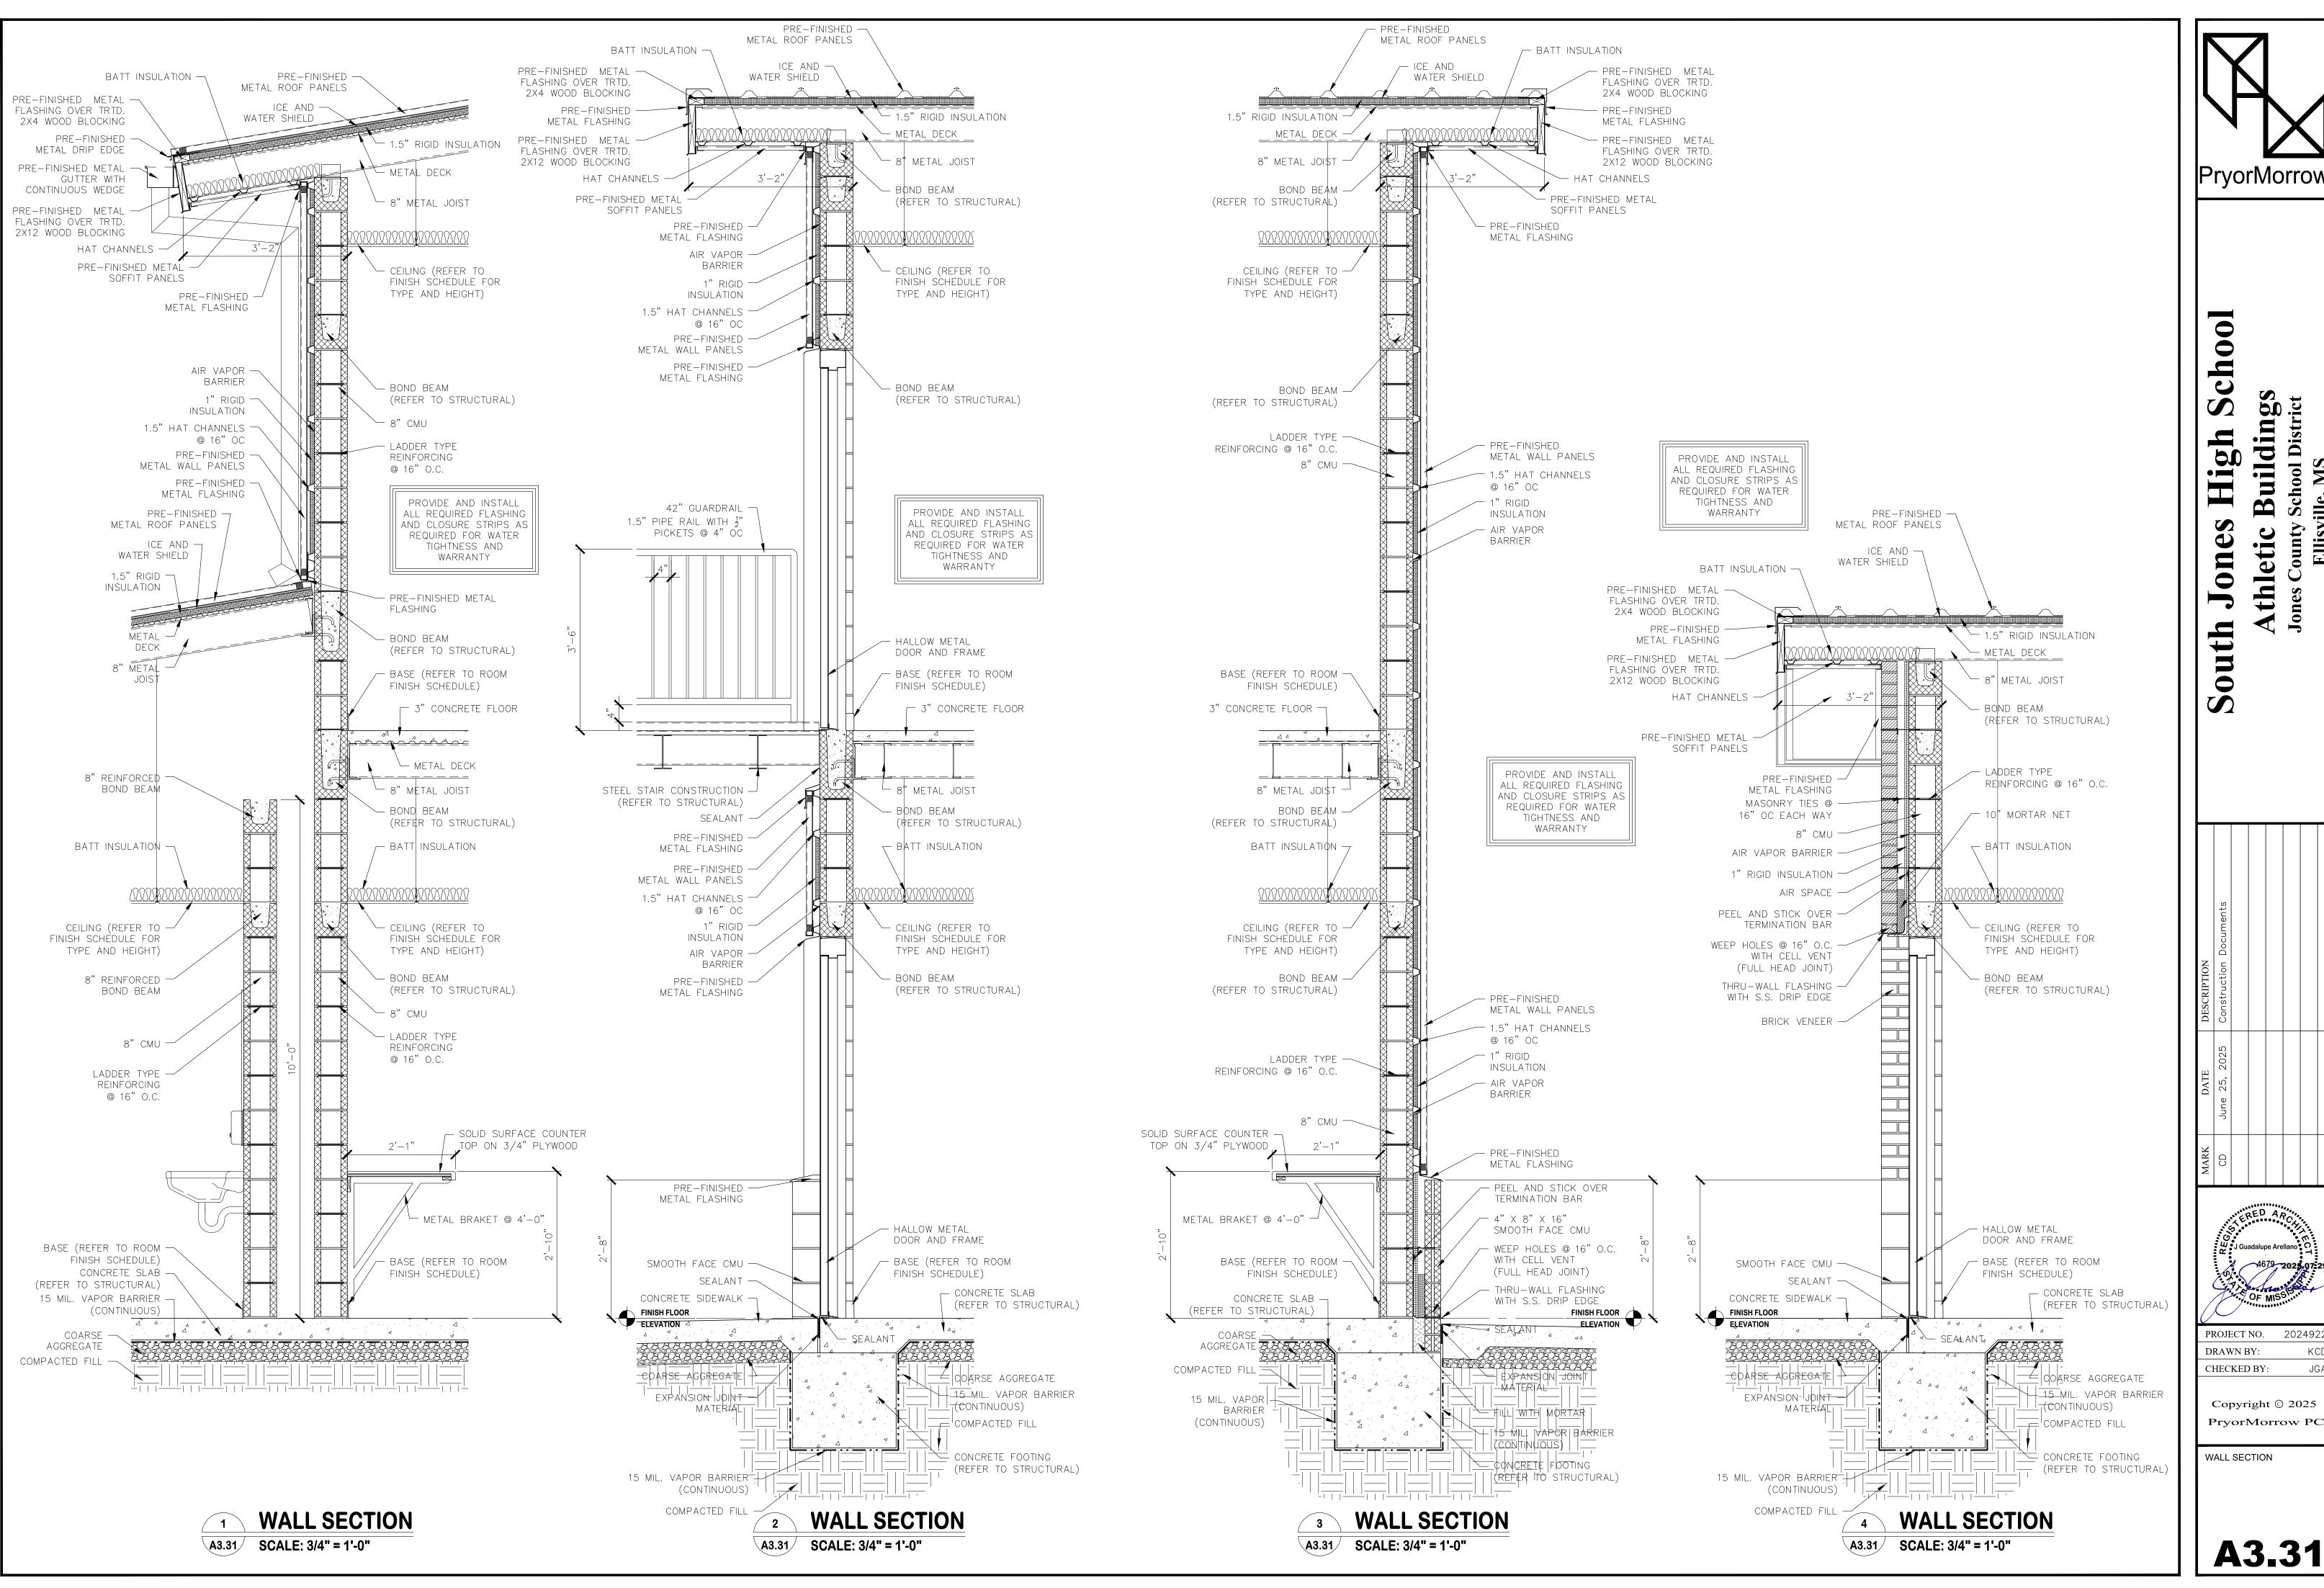

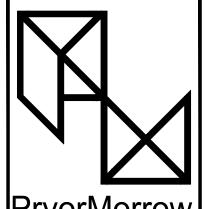


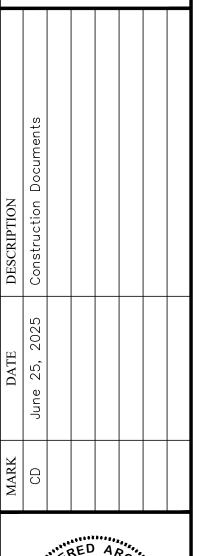




2024922

Copyright © 2025

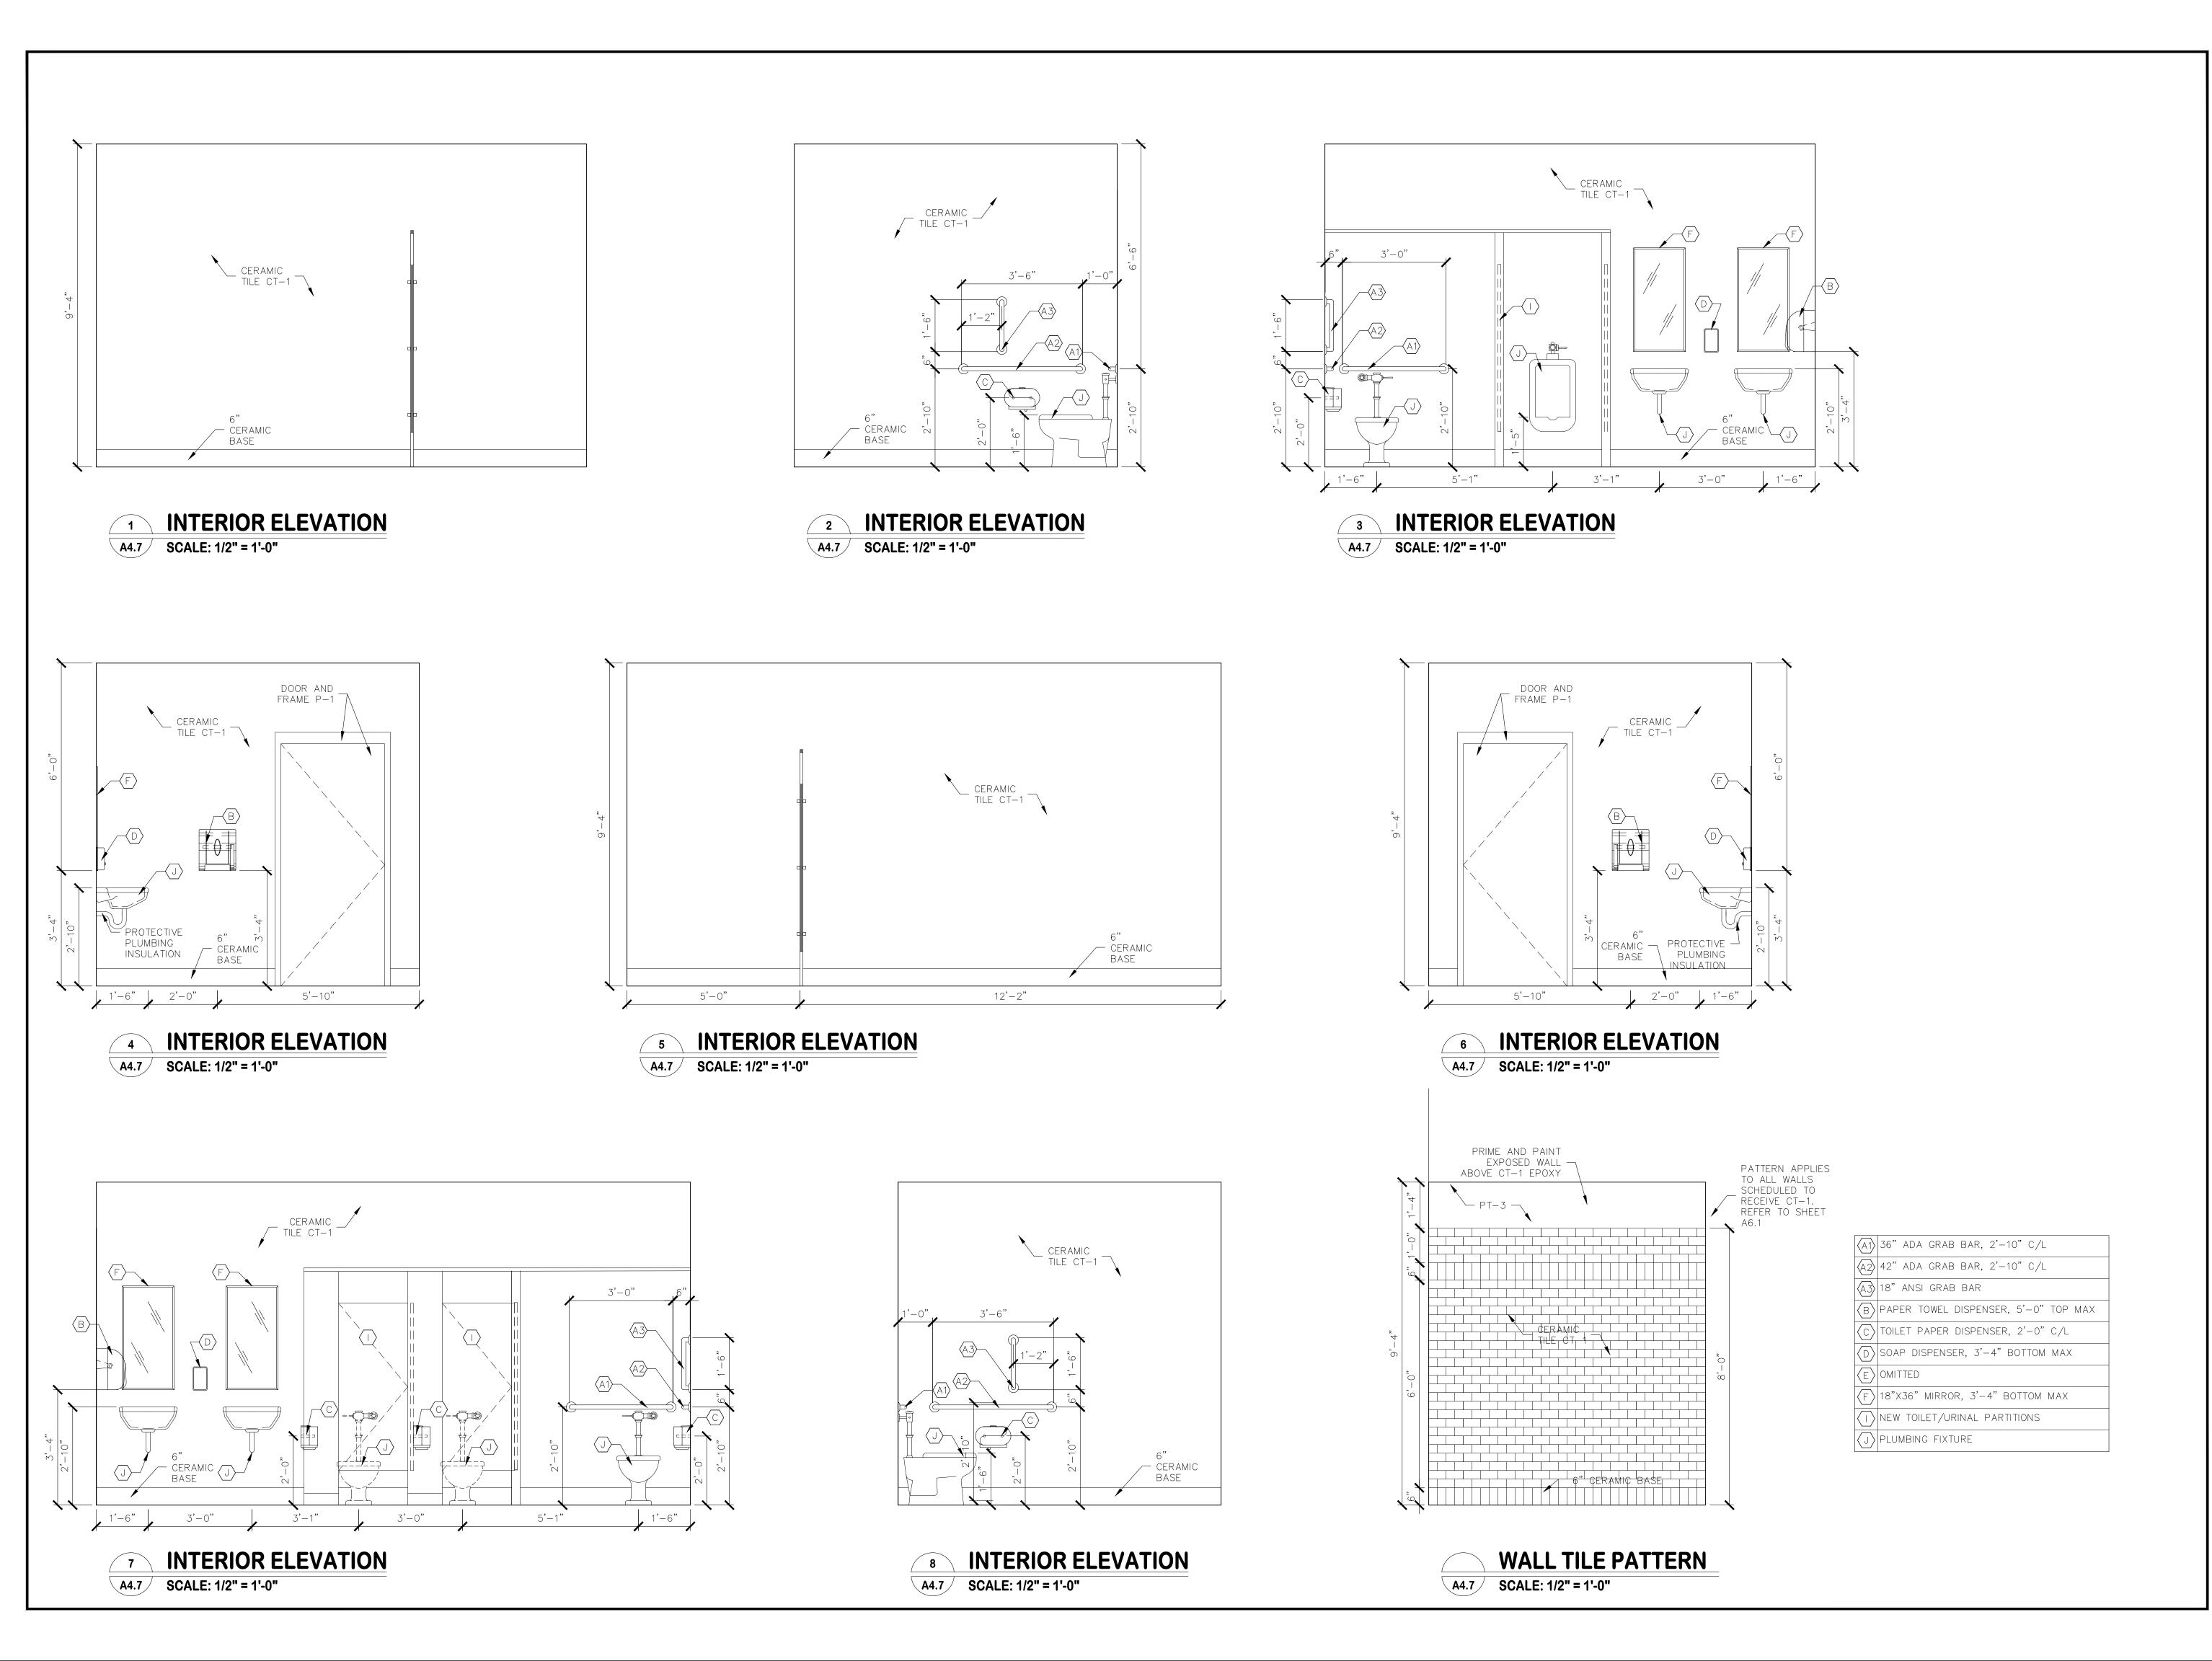

School

South

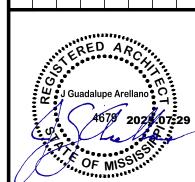



PROJECT NO. CHECKED BY:

Copyright © 2025 PryorMorrow PC

INTERIOR ELEVATIONS


A4.7

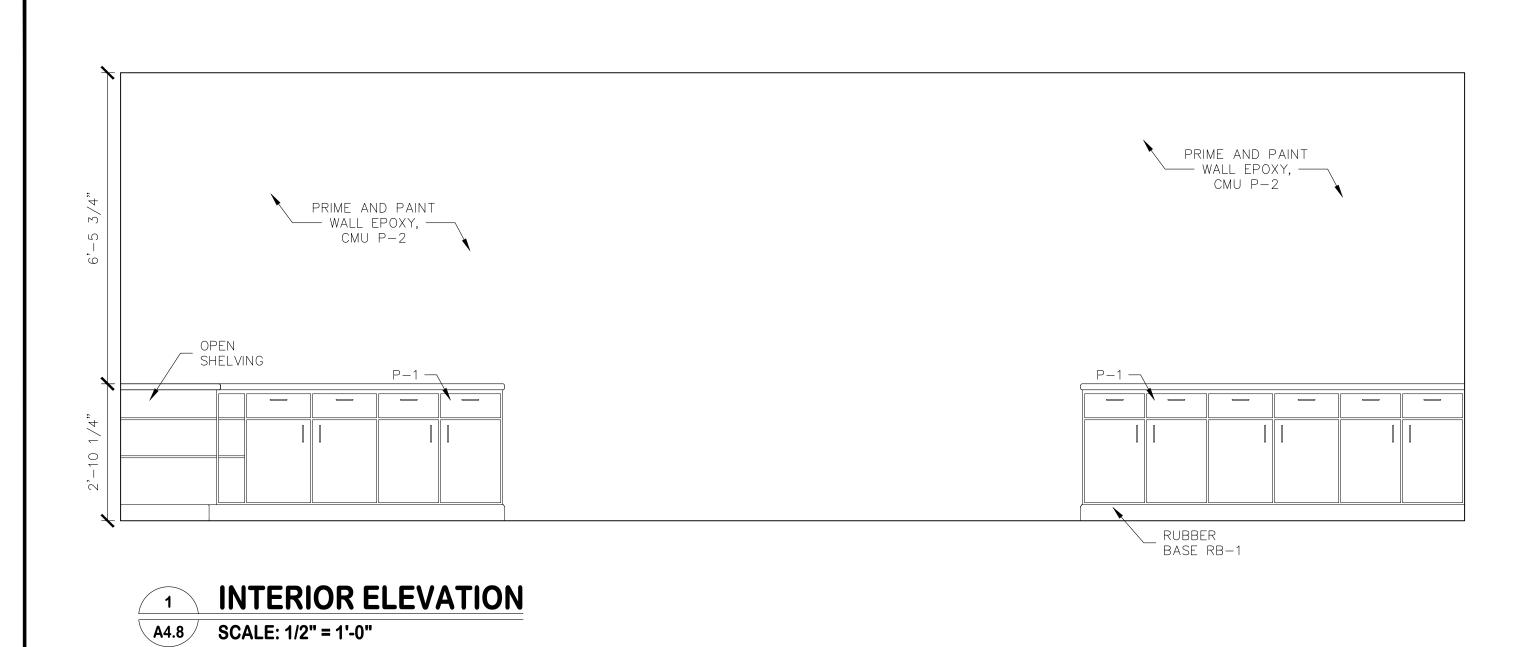


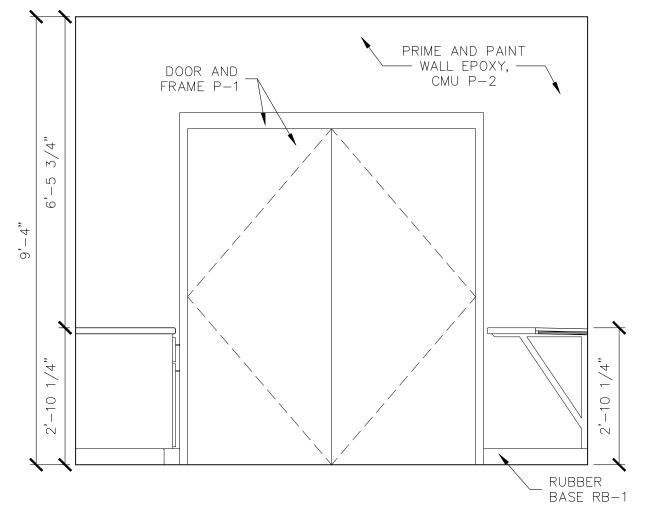

INTERIOR ELEVATION


A4.8 SCALE: 1/2" = 1'-0"

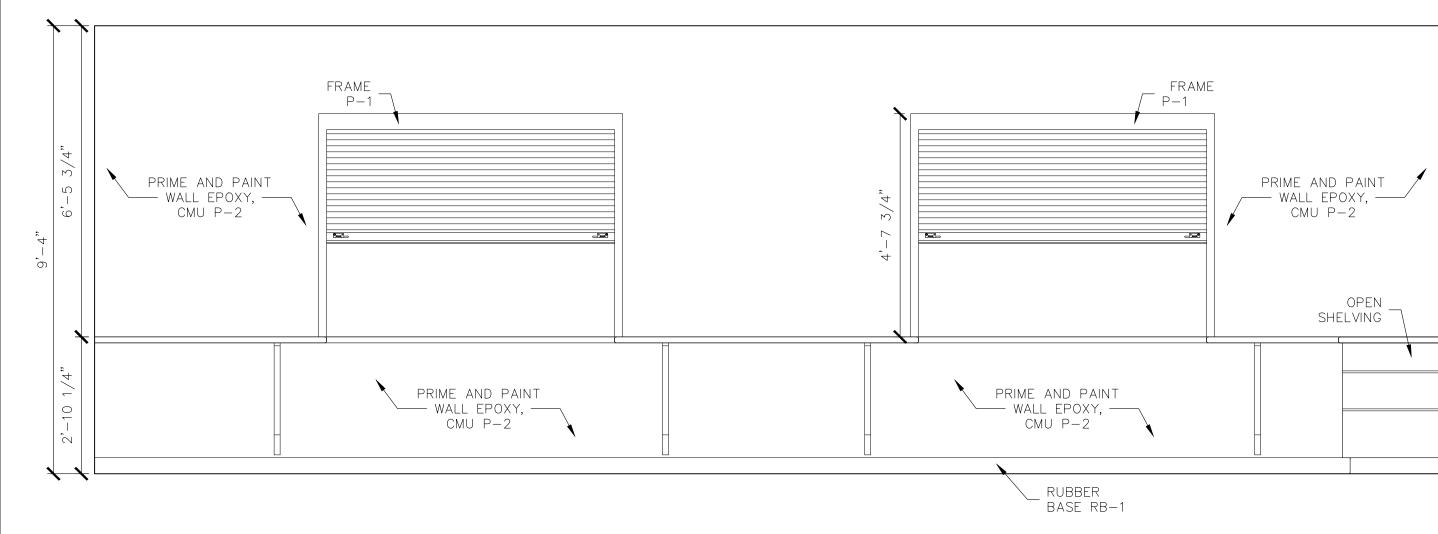

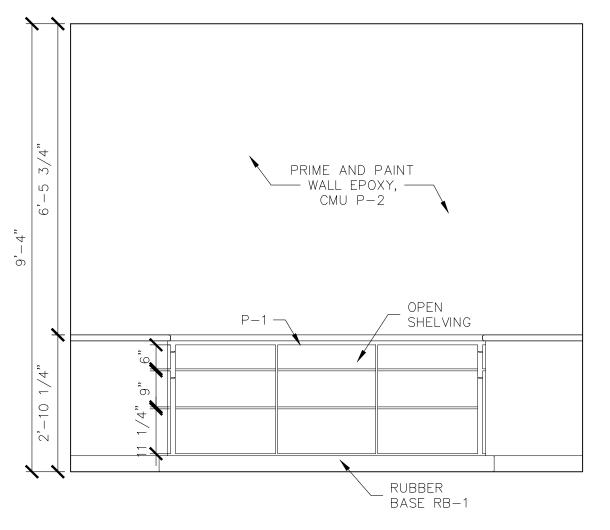

4 INTERIOR ELEVATION
A4.8 SCALE: 1/2" = 1'-0"

3 INTERIOR ELEVATION
A4.8 SCALE: 1/2" = 1'-0"

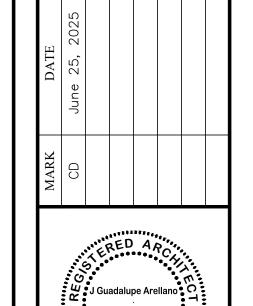

High School

Jones

South

thletic


Buildings
y School District
ville, MS

PROJECT NO. 2024922
DRAWN BY: KCD
CHECKED BY: JGA


Copyright © 2025 PryorMorrow PC

INTERIOR ELEVATIONS

A4.8

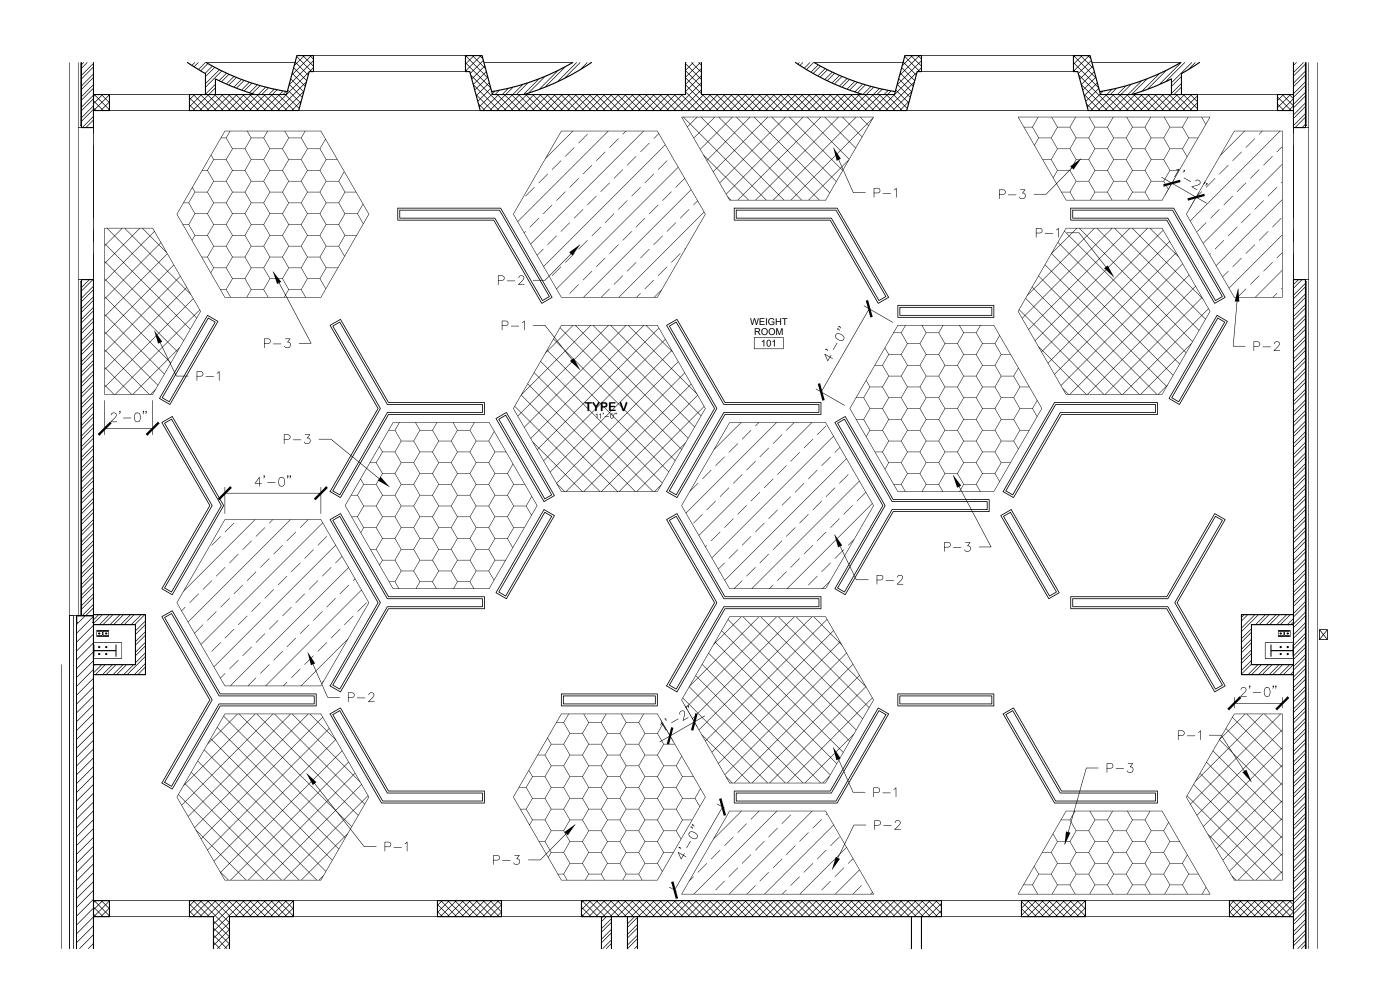

SOCCER-VOLLEYBALL
REFLECTED CEILING PLAN - WEIGHT ROOM
A6.2 SCALE: 1/4" = 1'-0"

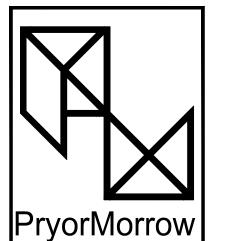

South Jones High School
Athletic Buildings
Jones County School District
Ellisville, MS

DESCRIPTION	Construction Documents						
DATE	June 25, 2025						
MARK	CD						




PROJECT NO. 202492
DRAWN BY: KC
CHECKED BY: JG

Copyright © 2025 PryorMorrow PC

WEIGHT ROOM REFLECTED CEILING PLAN

A6.2

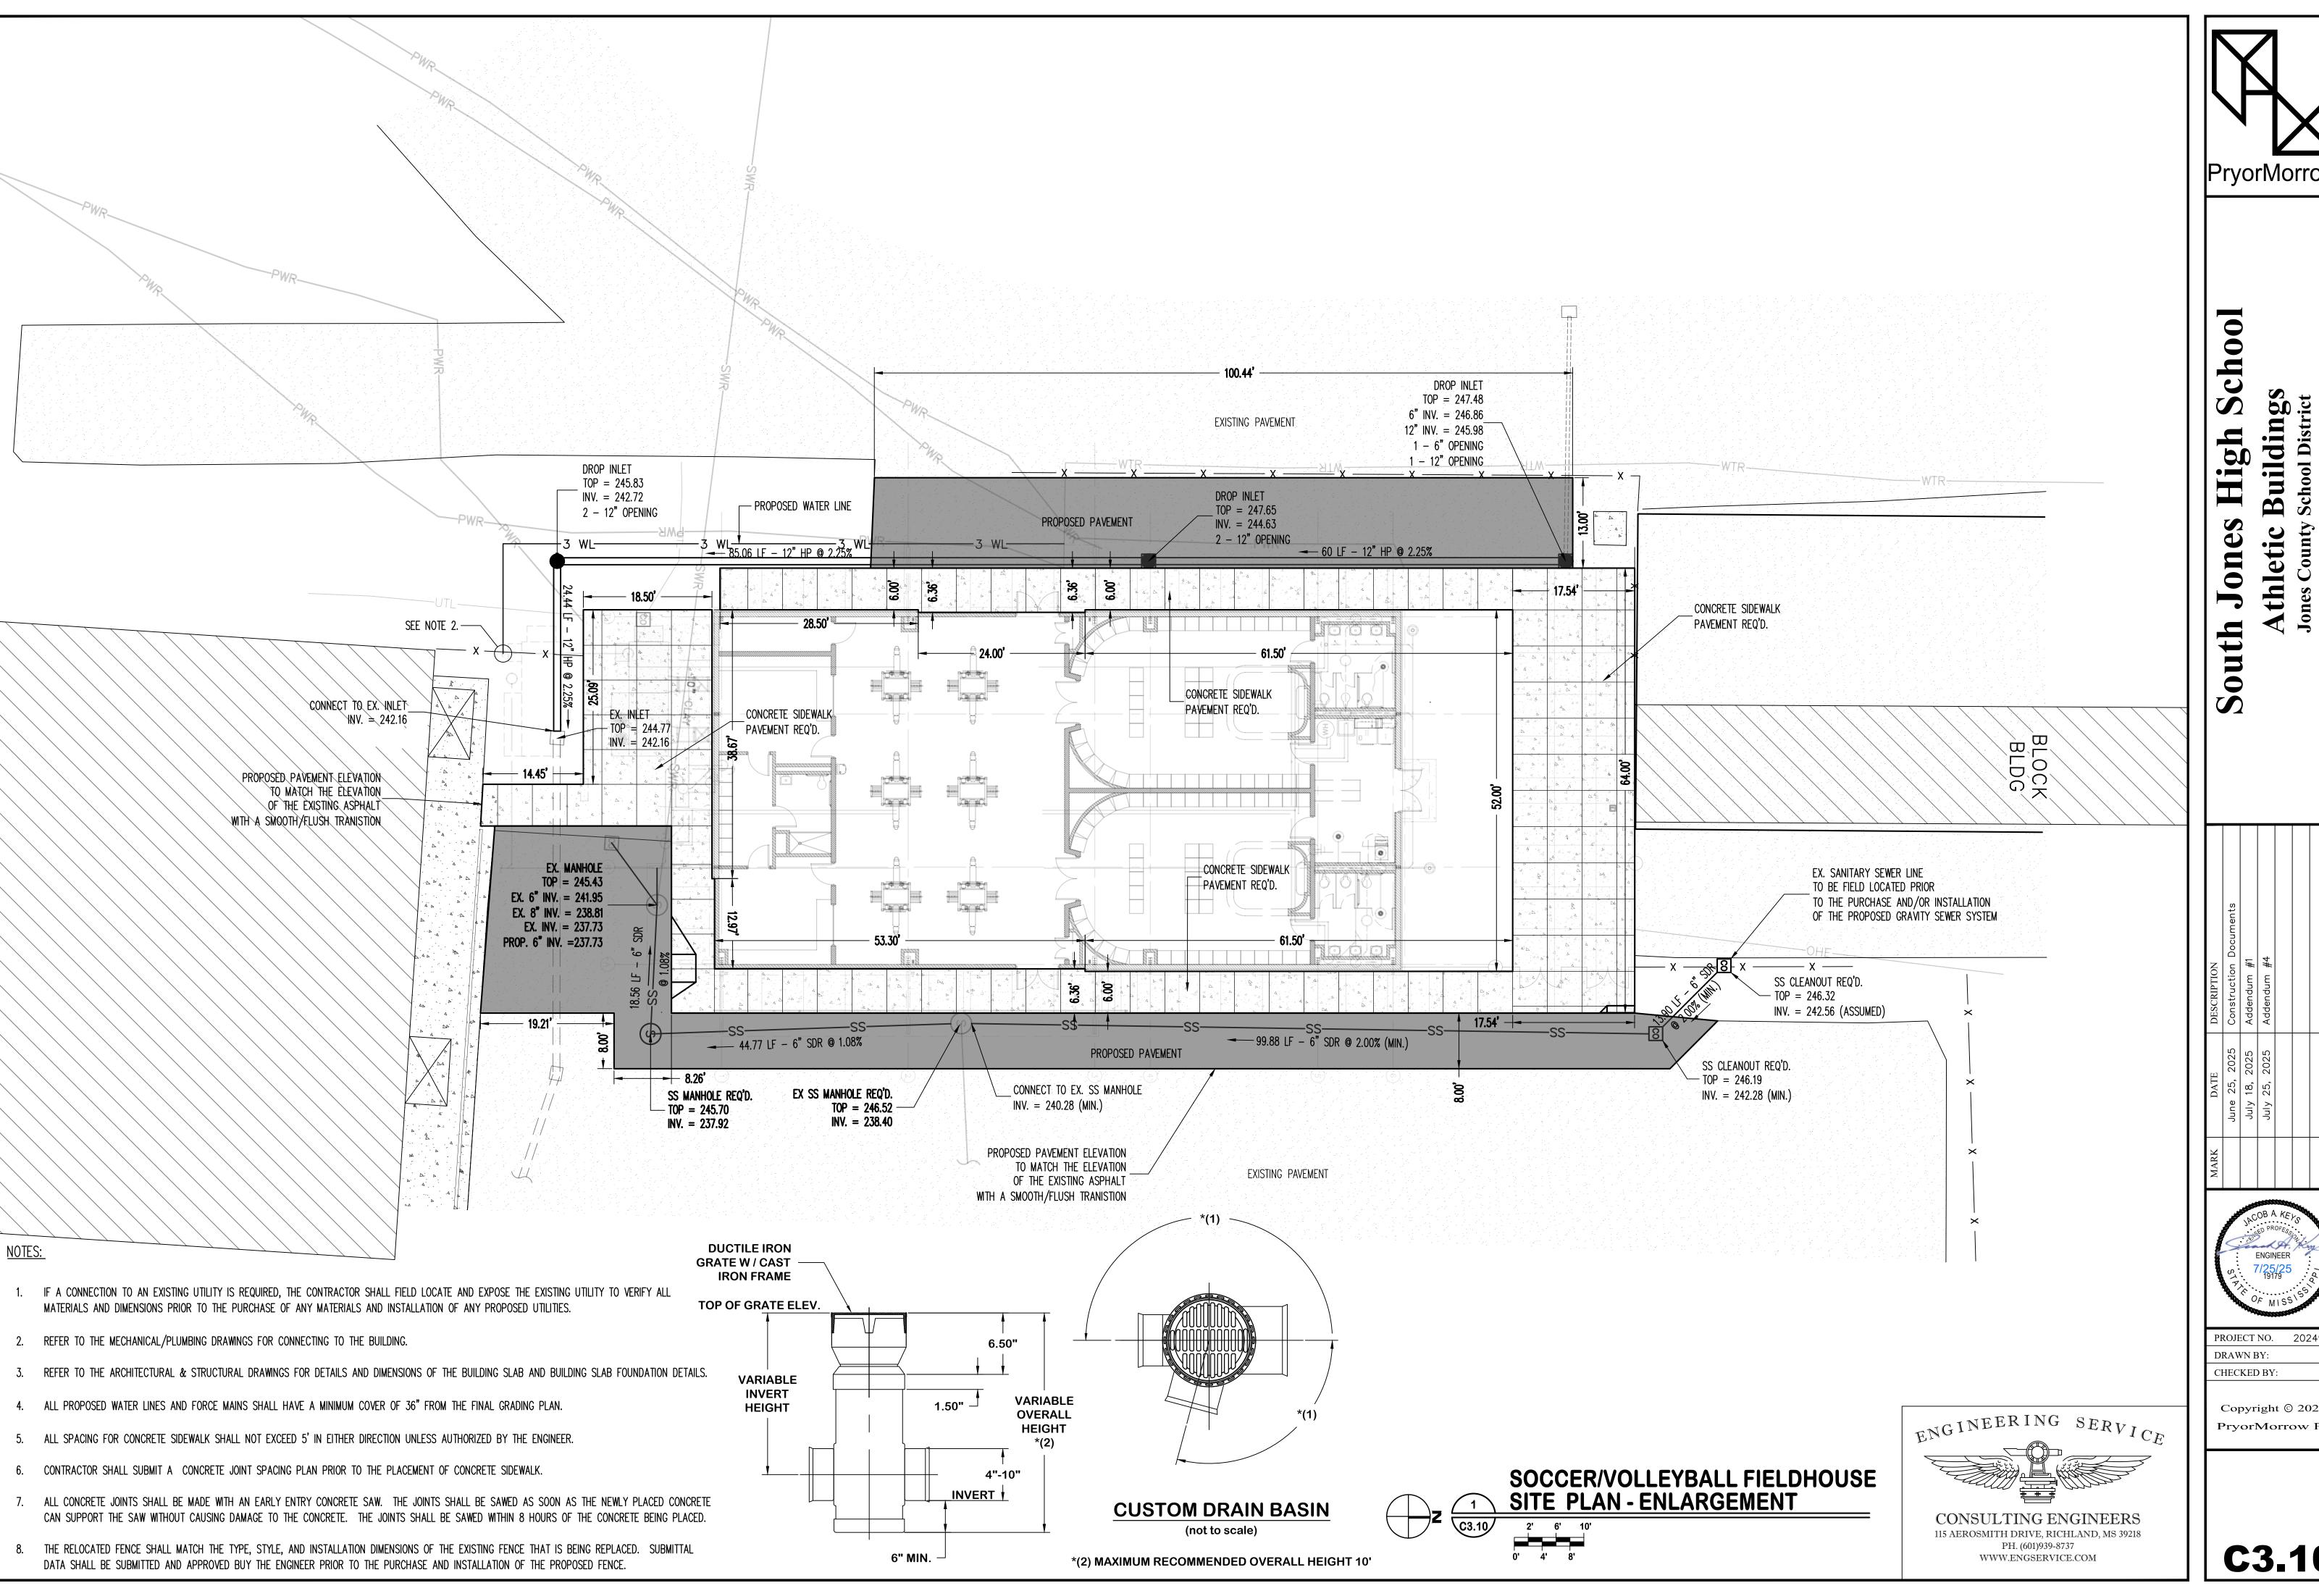




2024922

Copyright © 2025

PryorMorrow PC

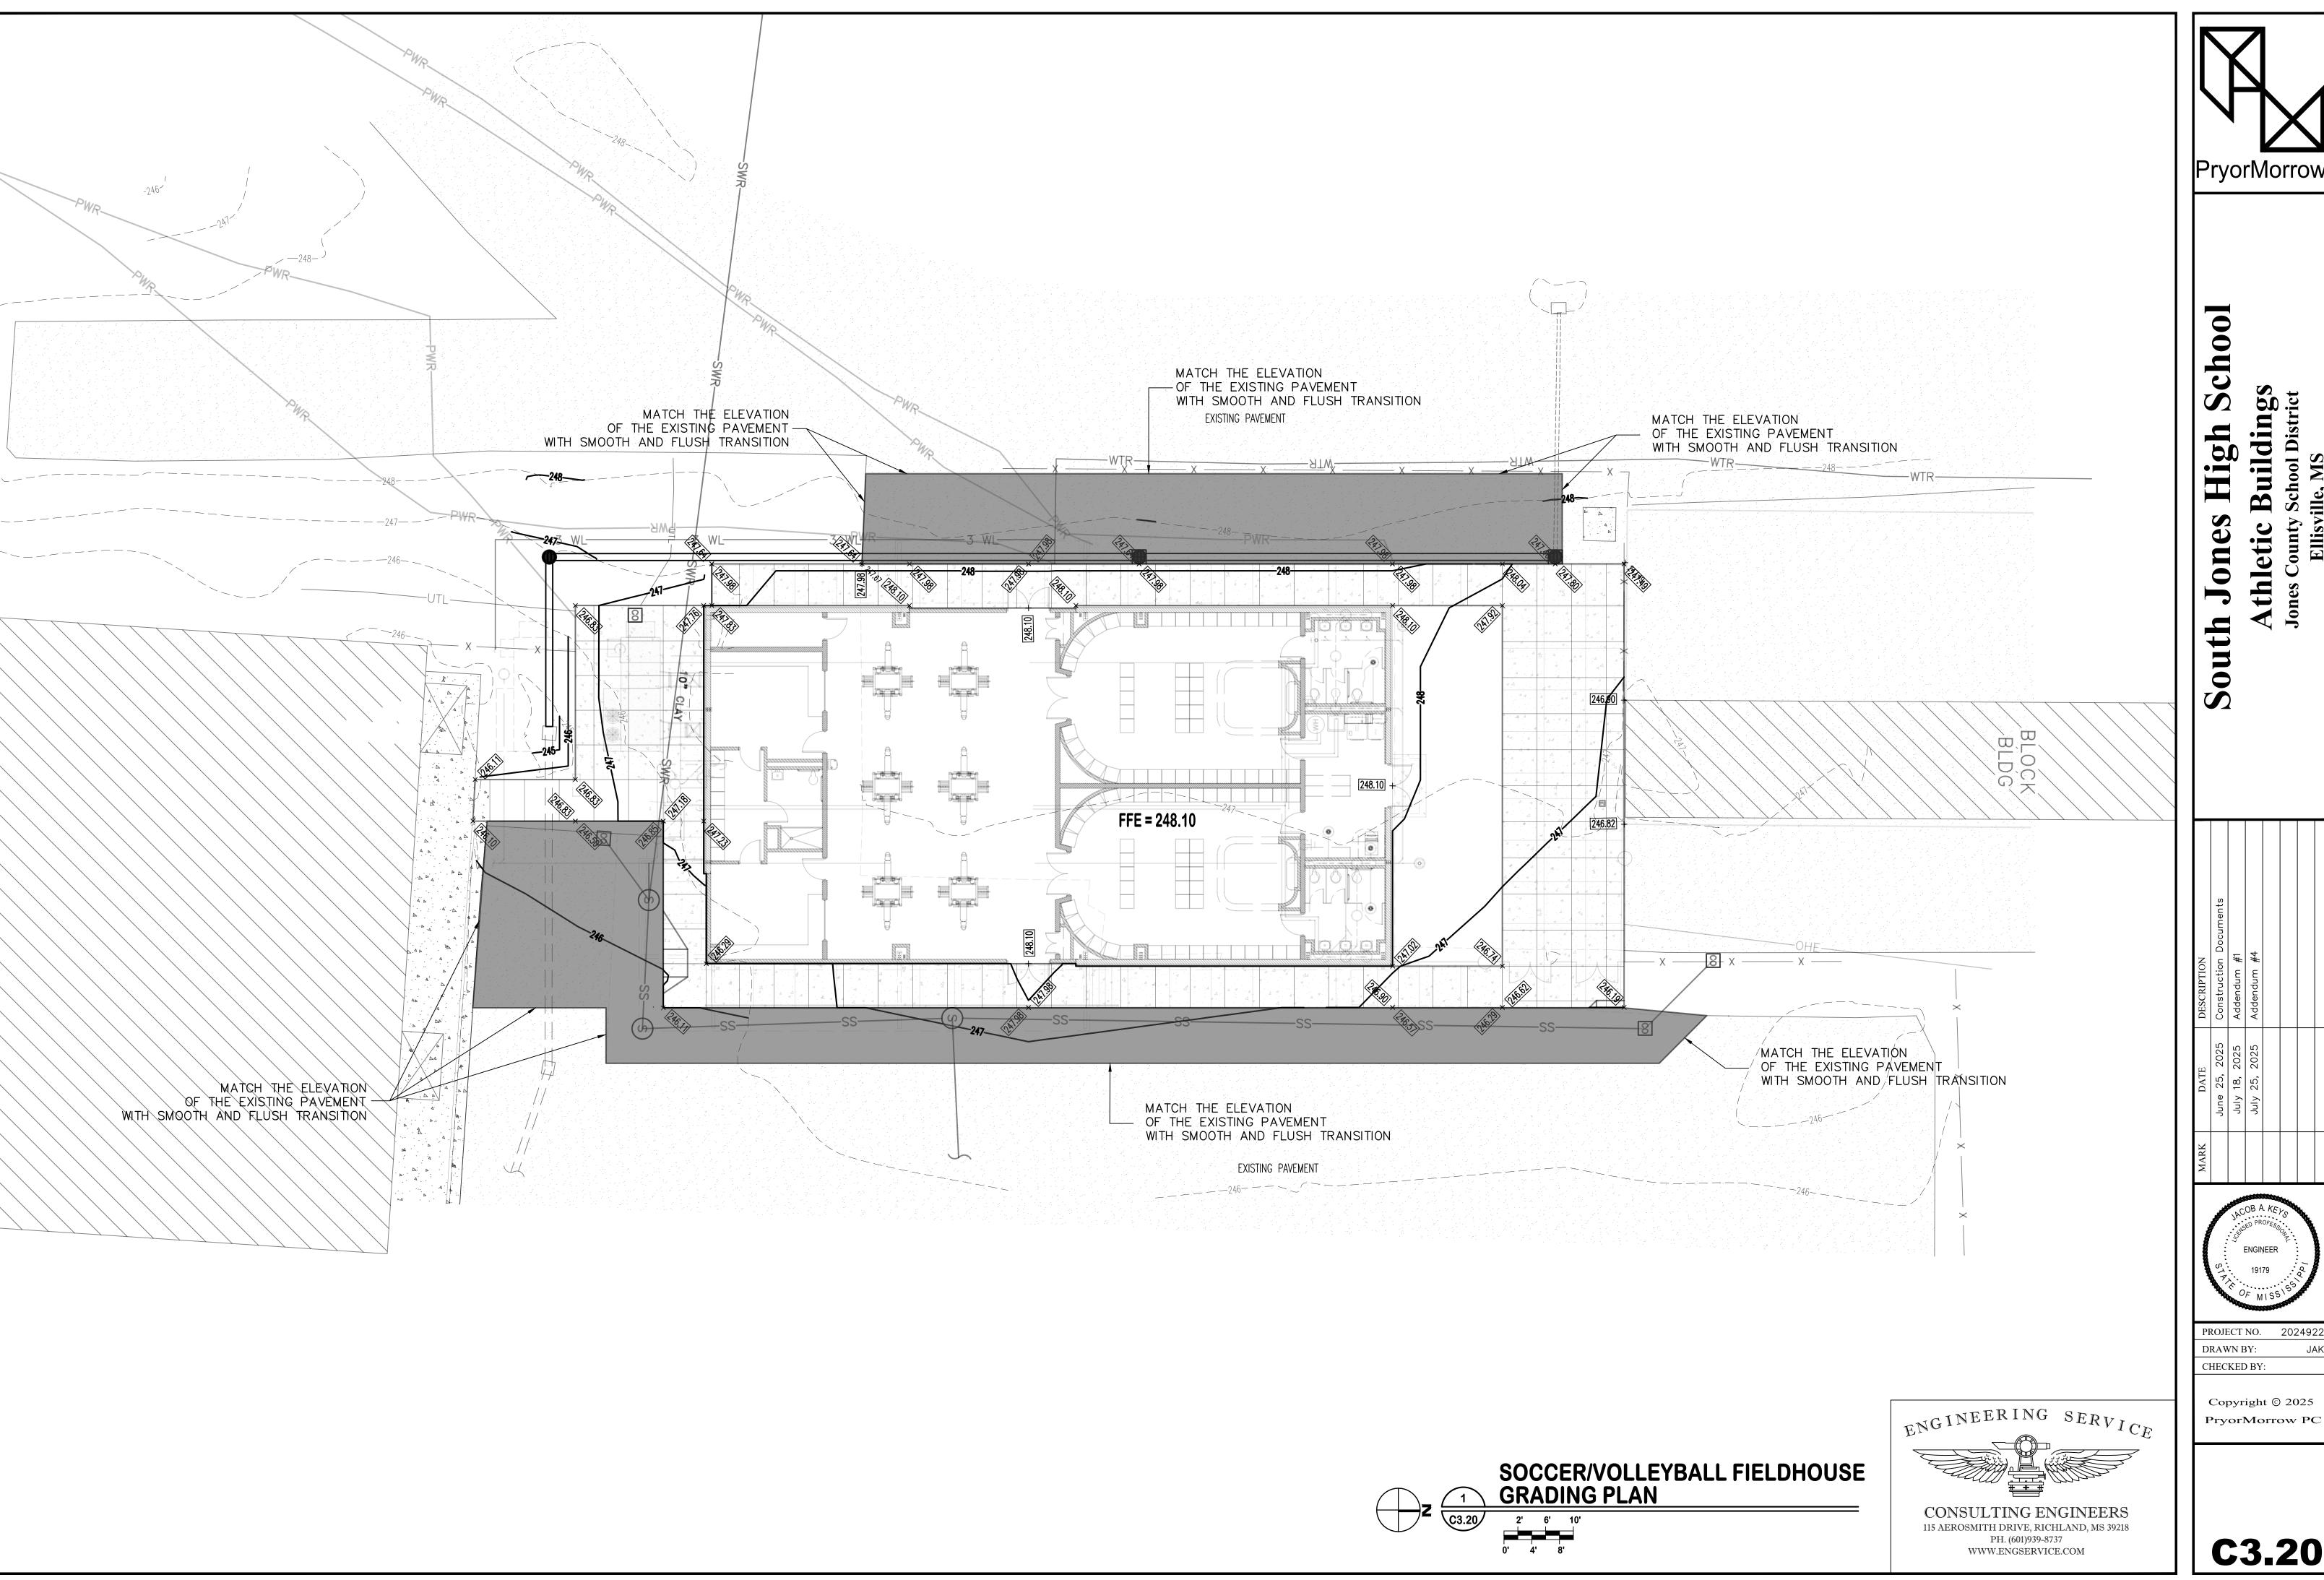




PROJECT NO. 2024922

PryorMorrow PC

C3.20

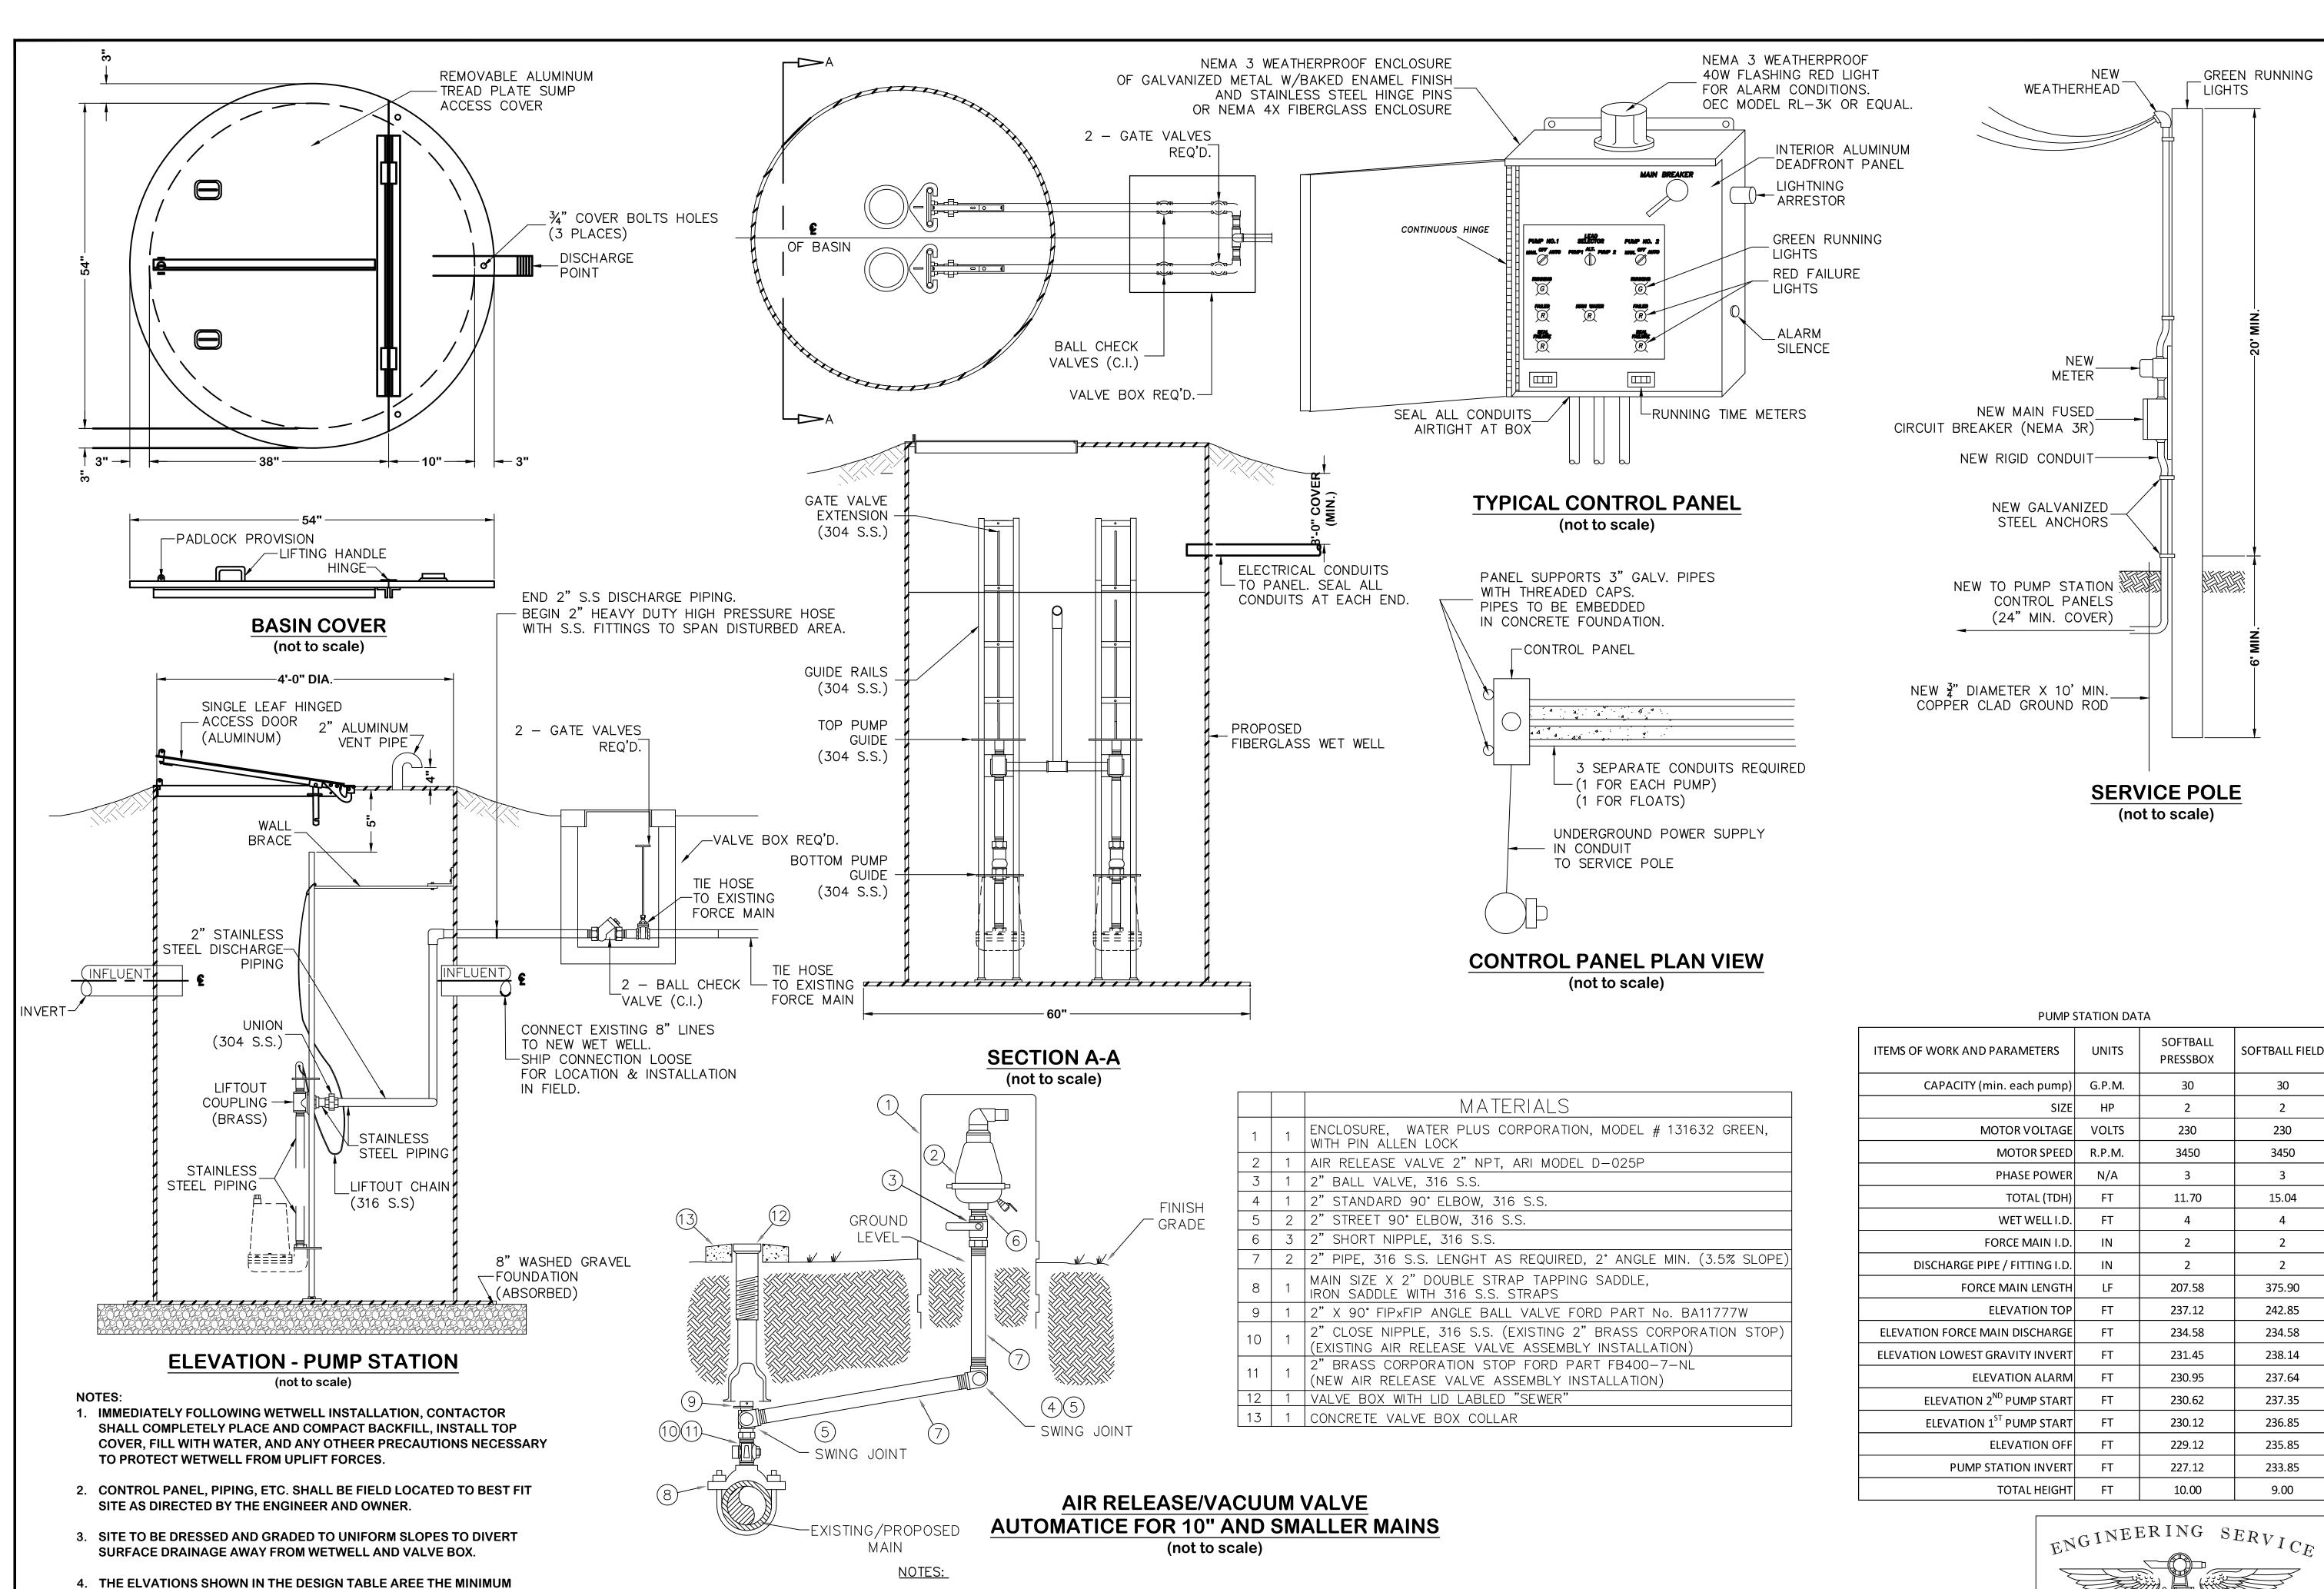

1. IN AS MUCH IS PRACTICAL, NEW FORCE MAINS SHOULD BE INSTALLED SUCH THAT HIGH POINT/ARV

SENSITIVE AREA, THEN CONSULT WITH THE ENGINEER AS TO BE THE BEST THE BEST ALTERNATIVE

2. IF AN EXISTING HIGH POINT/PROPOSED ARV LOCATIONS IS IN FRONT OF A RESIDENCE OR IN A

LOCATION IS AWAY FROM RESIDENCES OR OTHER SENSITIVE AREAS.

LOCATION, PREFERABLY DOWNSTREAM FROM THE HIGH POINT.

DESIGN REQUIREMENTS. IF MANUFACTURER OF THE PROPOSED

& INSTALLATION BY OTHERS).

LOWERED AS NECESSARY AT NO ADDITIONAL COST TO THE OWNER

5. 8" INLET & OUTLET PIPE CONNECTIONS SHIPPED LOOSE (FOR LOCATION

PUMP(S) REQUIRE A GREATER DEPTH, THE WETWELL BOTTOM SHALL BE

|PryorMorrow

choo 5. 5. uildin etic 0u thl

no

SOFTBALL FIELD

30

230

3450

15.04

2

375.90

242.85

234.58

238.14

237.64


237.35

236.85

235.85

233.85

9.00

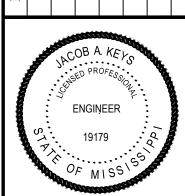

PROJECT NO. 2024922 DRAWN BY: CHECKED BY:

Copyright © 2025

PryorMorrow PC

CONSULTING ENGINEERS 115 AEROSMITH DRIVE, RICHLAND, MS 39218 PH. (601)939-8737 WWW.ENGSERVICE.COM

PUMP STATION DETAILS C4.30